

**HOUSING
STUDIO**

333 West Trade Street, Suite 300
Charlotte, NC 28202
T: 704.333.7862 F: 704.343.9380


**TIBURON PARC
APARTMENT HOMES**
WILMINGTON, NC

**THE
OLEANDER
COMPANY**


Project No: 2923
Issue Date: NOV. 30, 2012
Issued For: 60% PROGRESS SET
Issue Date: DEC. 31, 2012
Issued For: 90% PROGRESS SET
Issue Date: FEB. 18, 2013
Issued For: HUD/Permit Set

**DUMPSTER ENCLOSURE PLAN
& ELEVATIONS**


A8.4

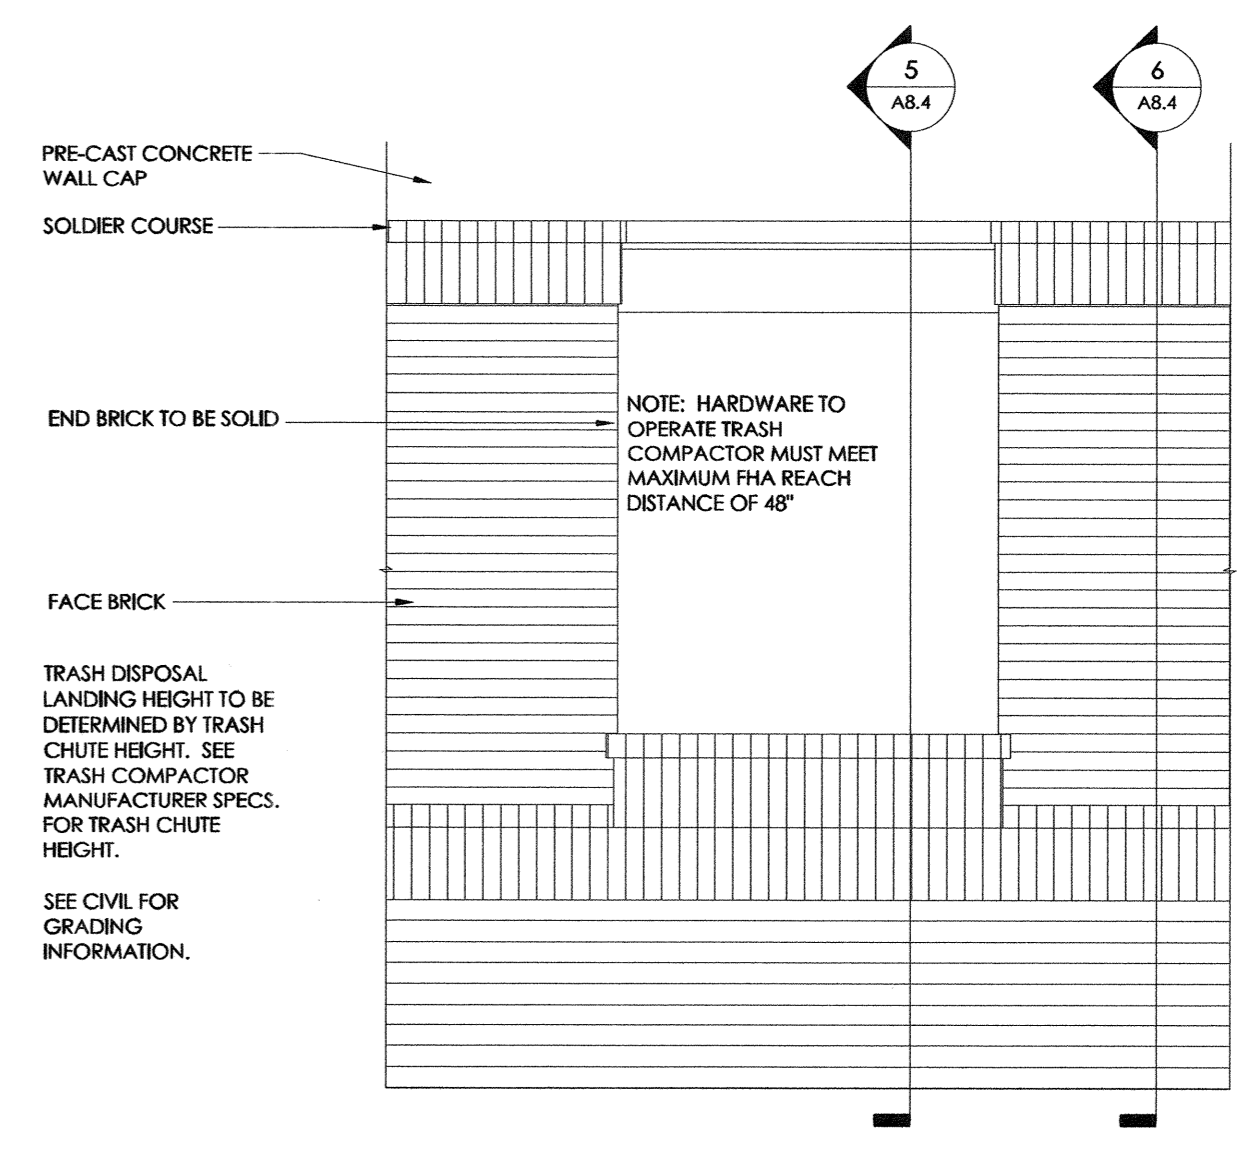


7 DUMPSTER ENCLOSURE ENLARGED ELEVATION
1/2" = 1'-0"

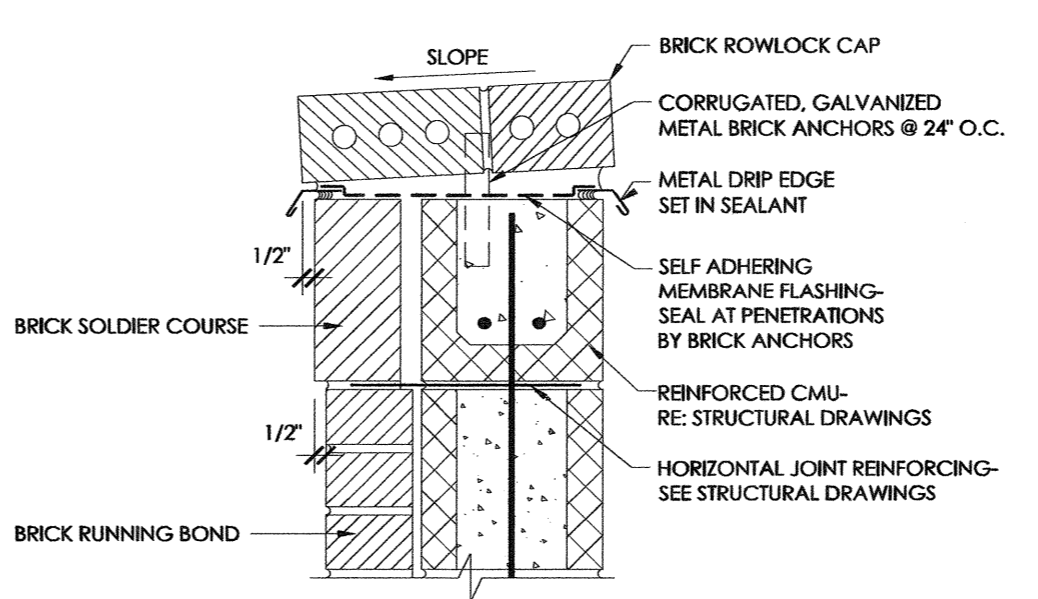


8 WALL CAP DETAIL
1 1/2" = 1'-0"

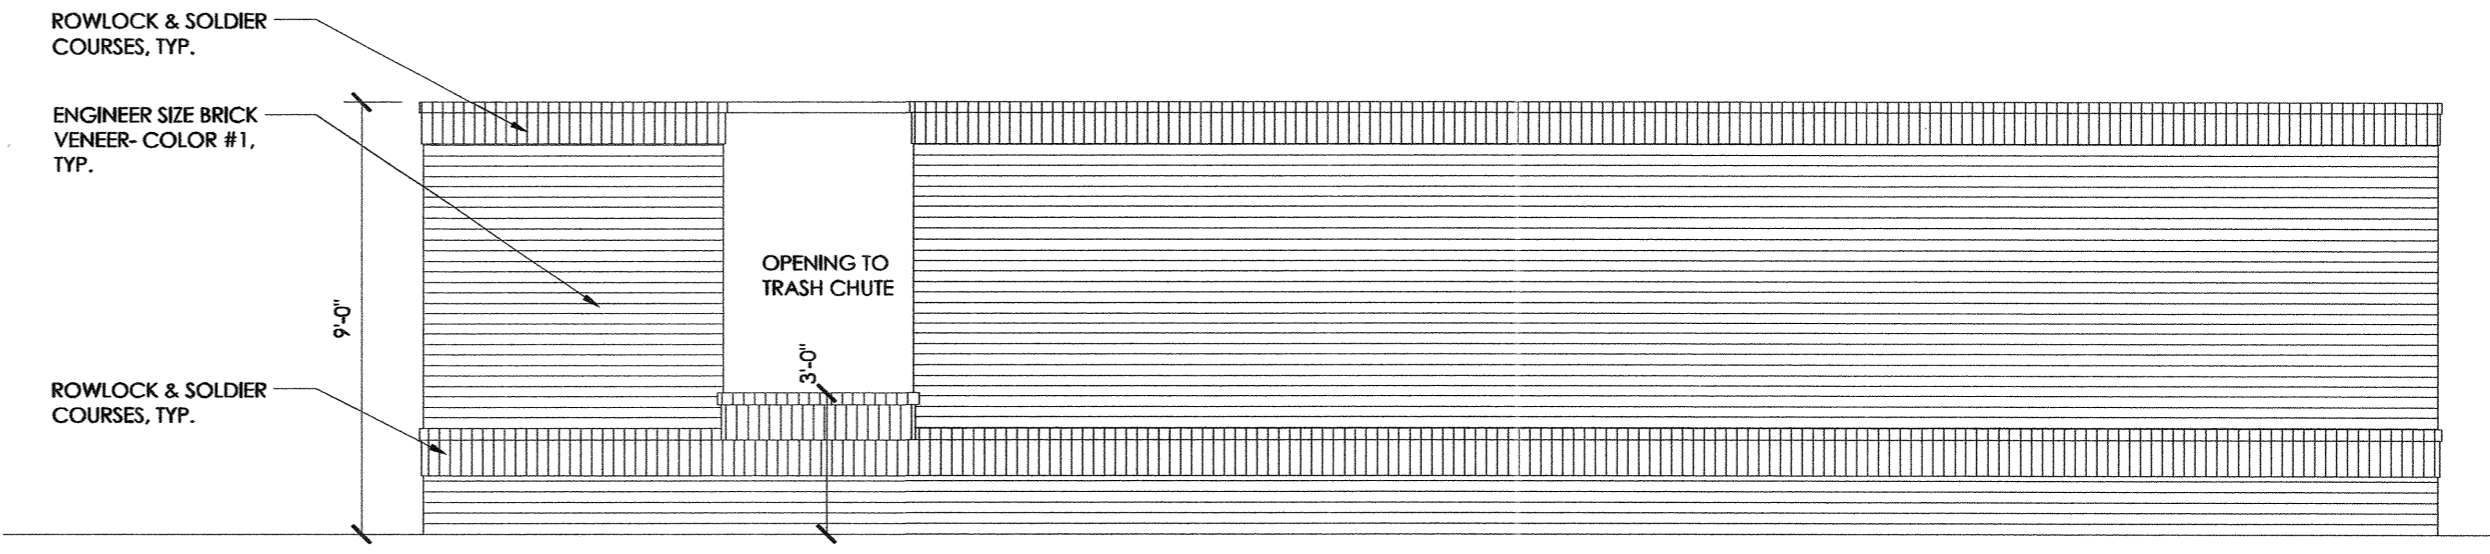


4 DUMPSTER ENCLOSURE ELEVATION
1/4" = 1'-0"

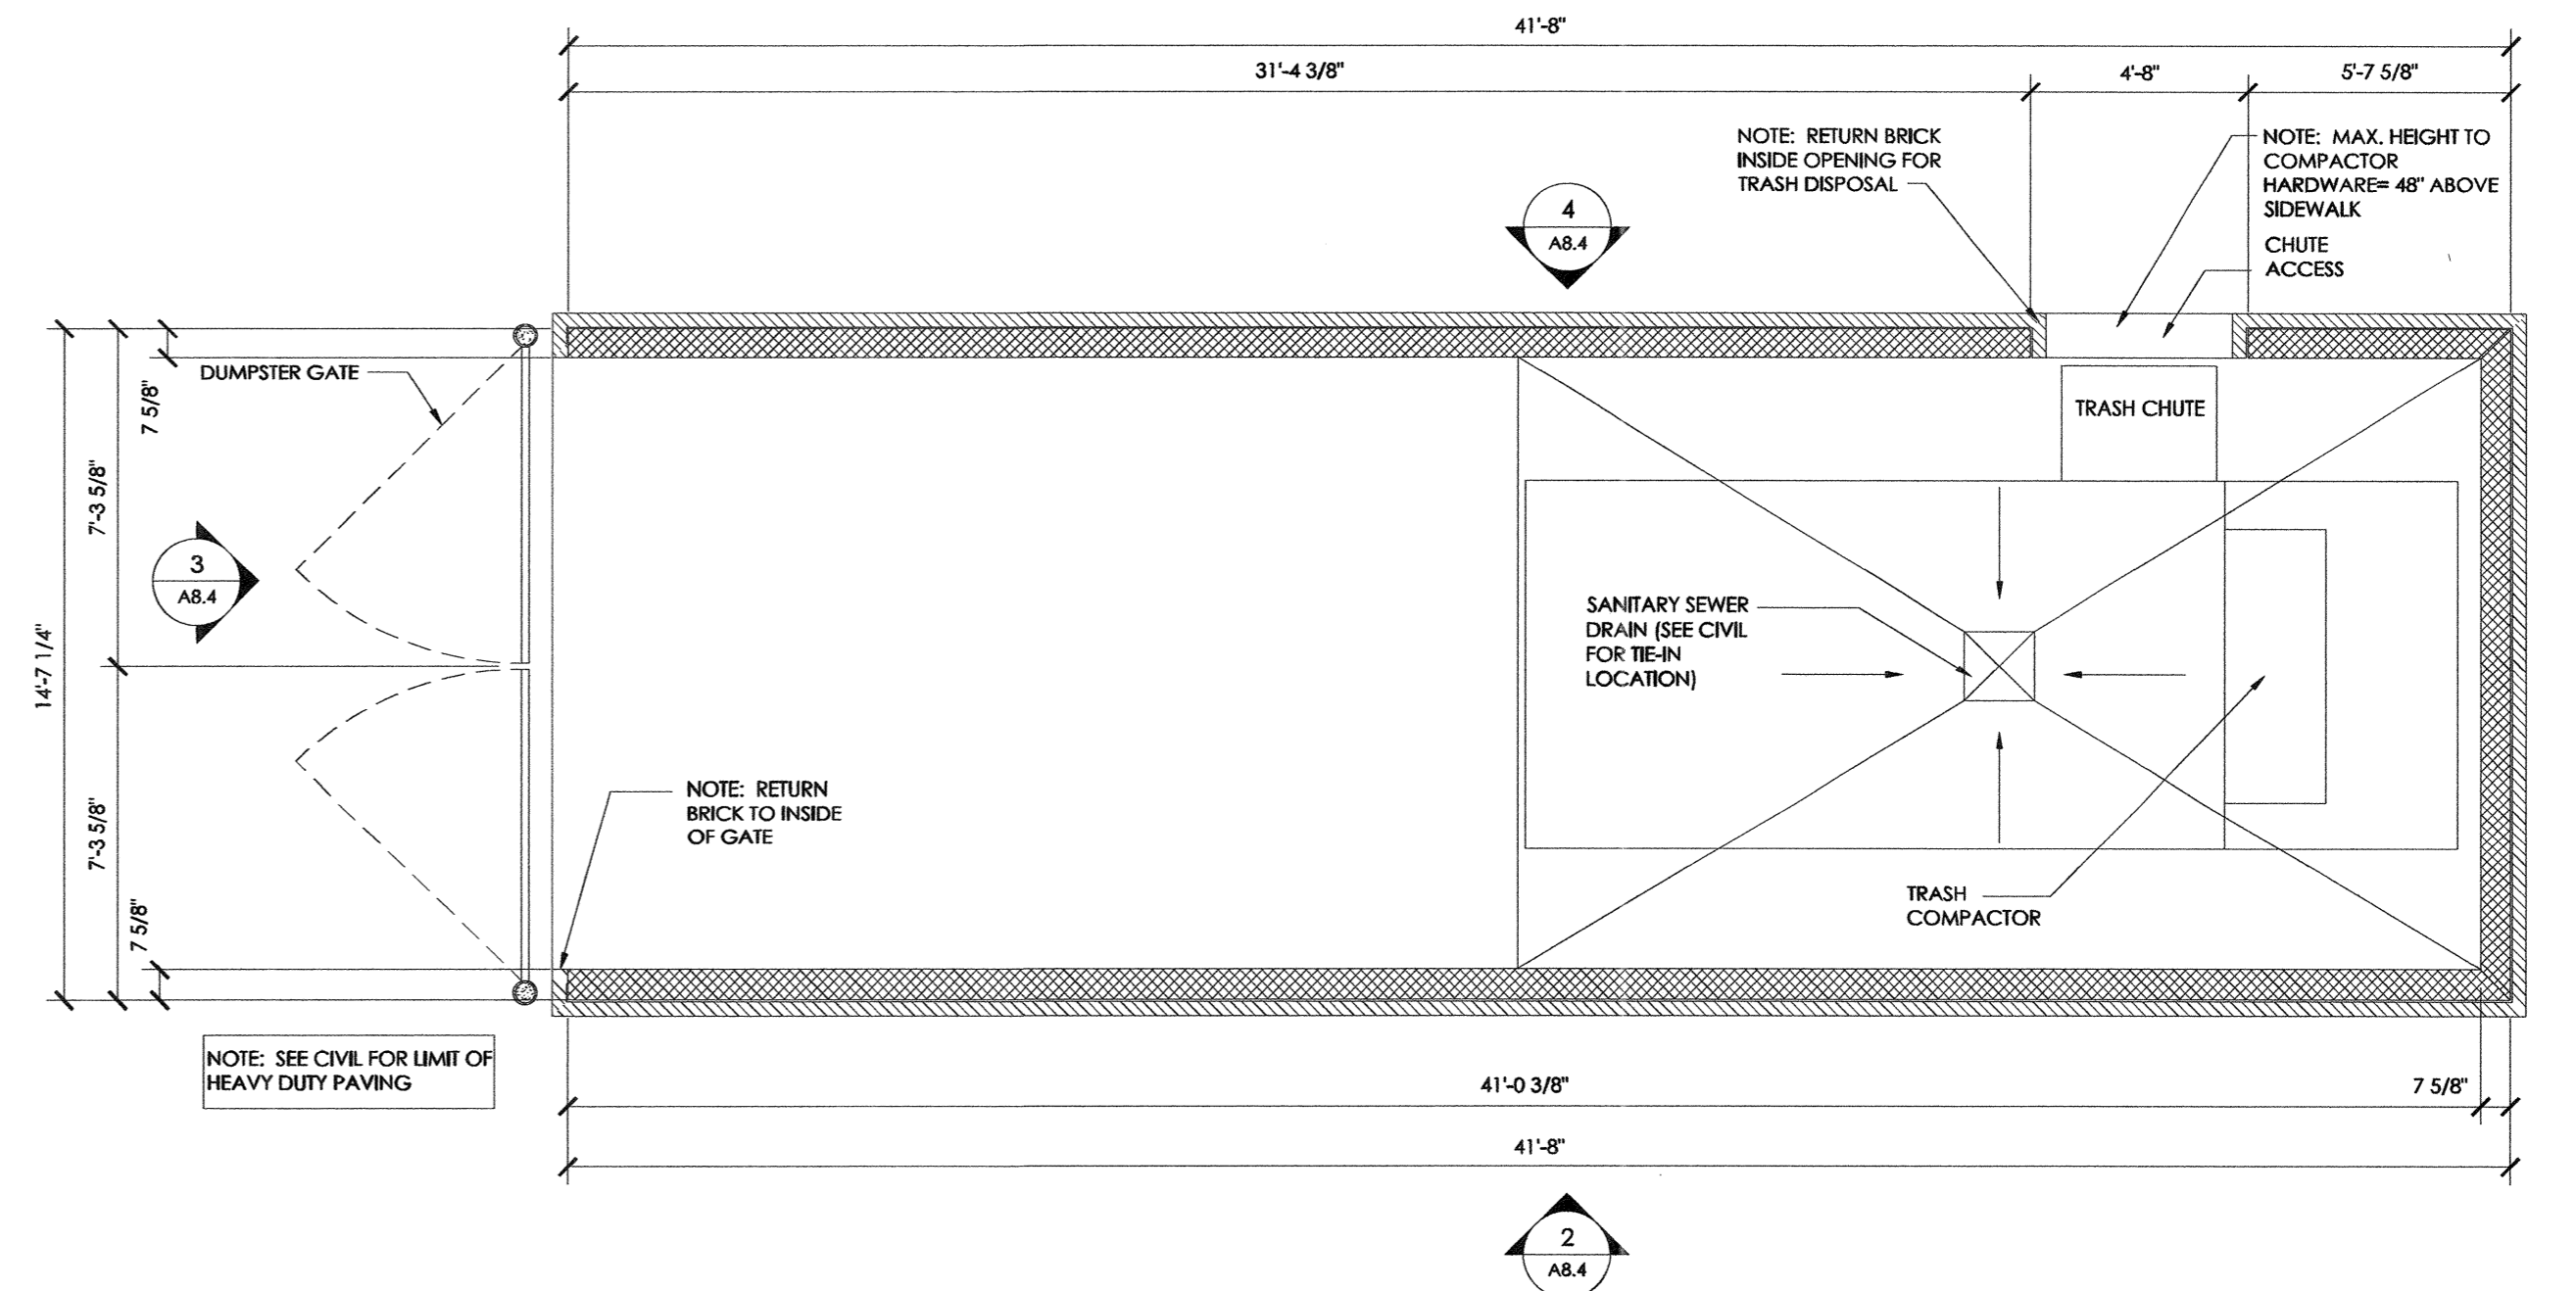


1 DUMPSTER ENCLOSURE PLAN
1/4" = 1'-0"

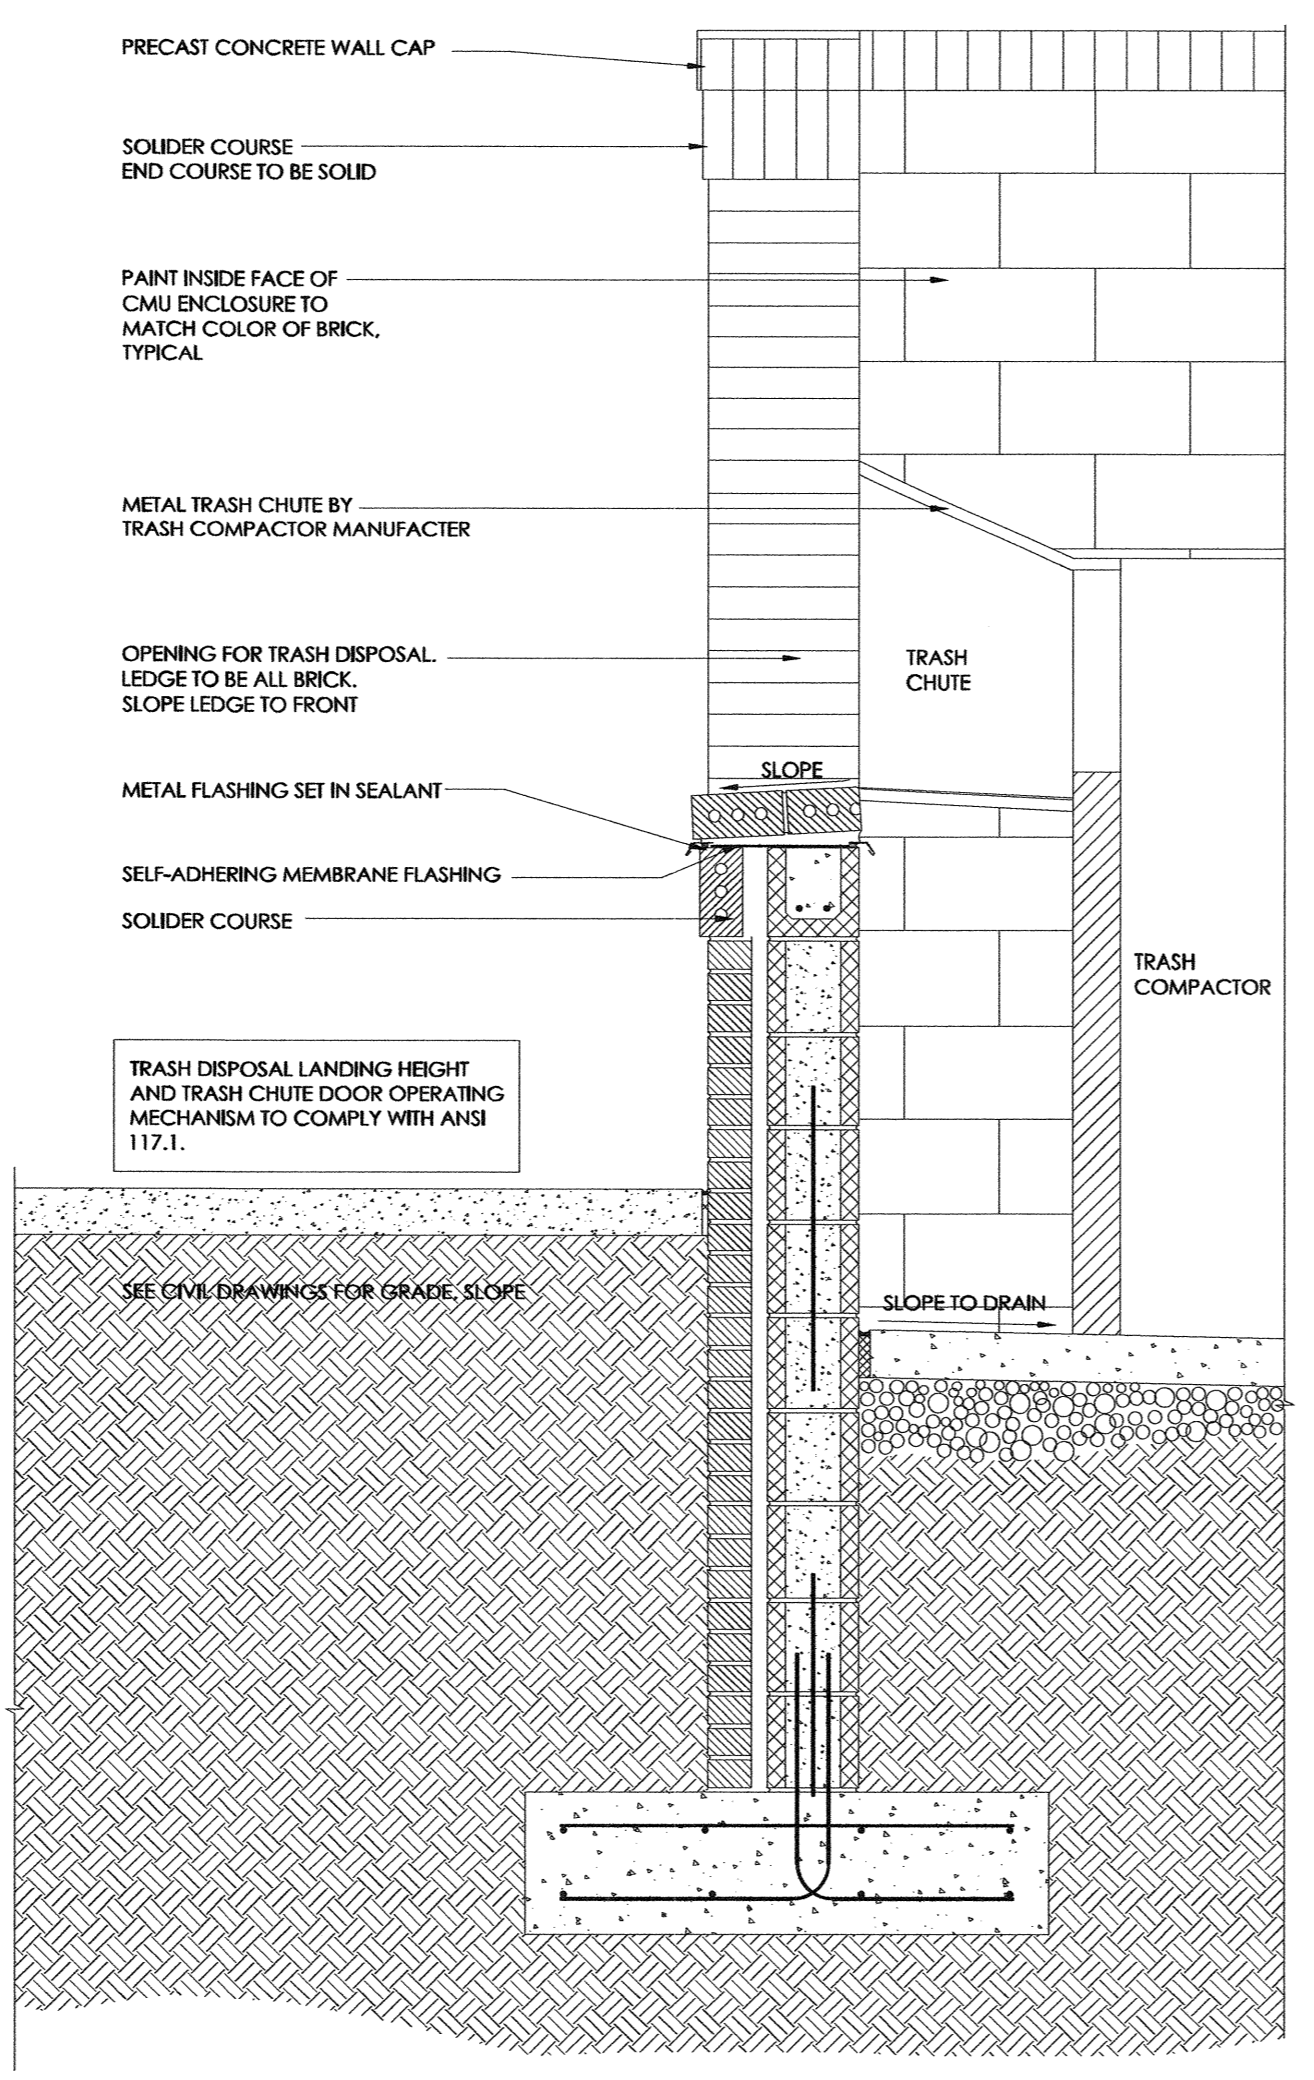


5 TRASH CHUTE WALL SECTION
3/4" = 1'-0"

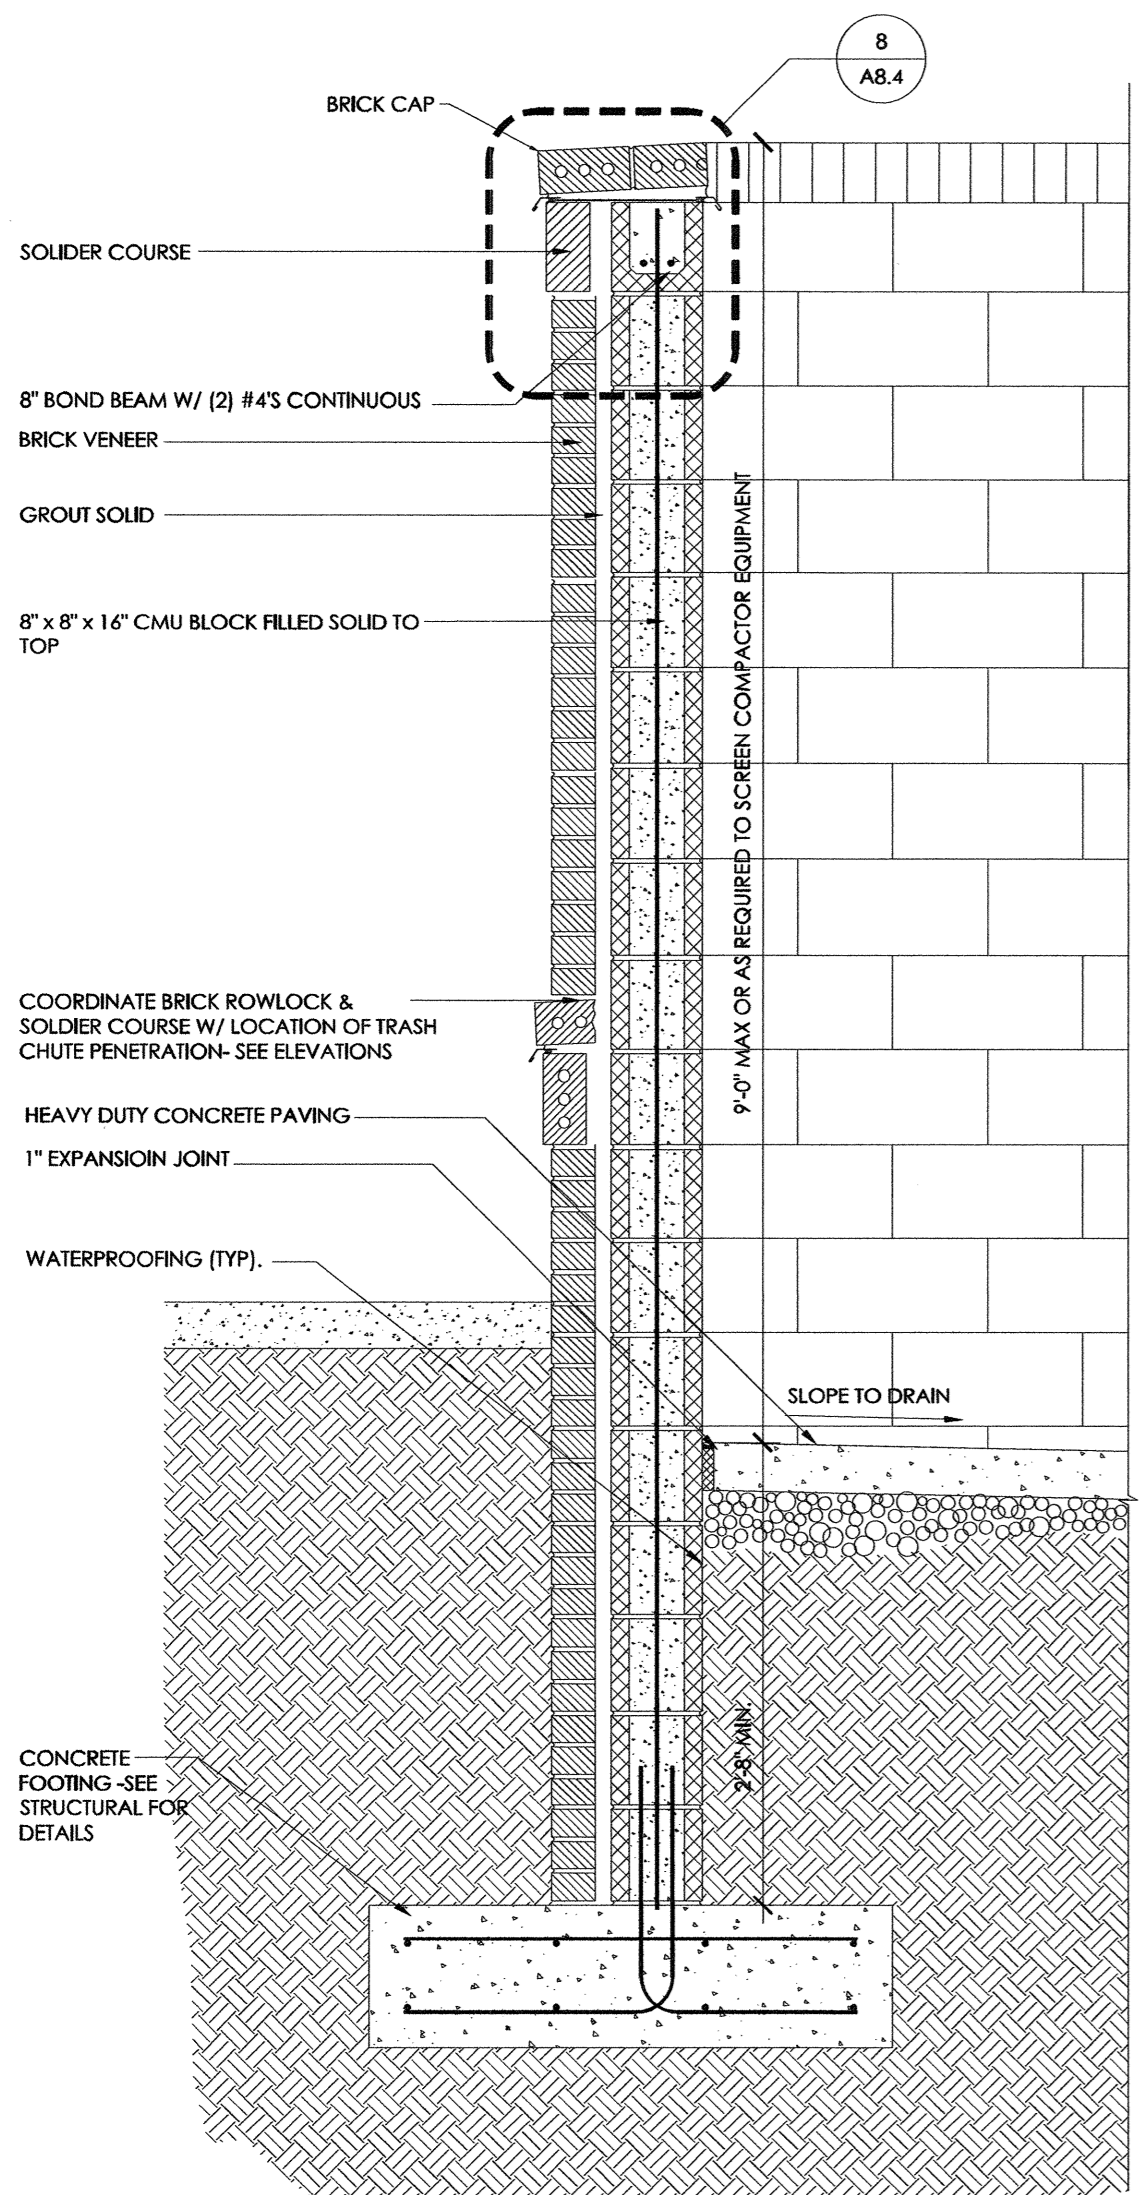

6 DUMPSTER ENCLOSURE WALL SECTION
3/4" = 1'-0"

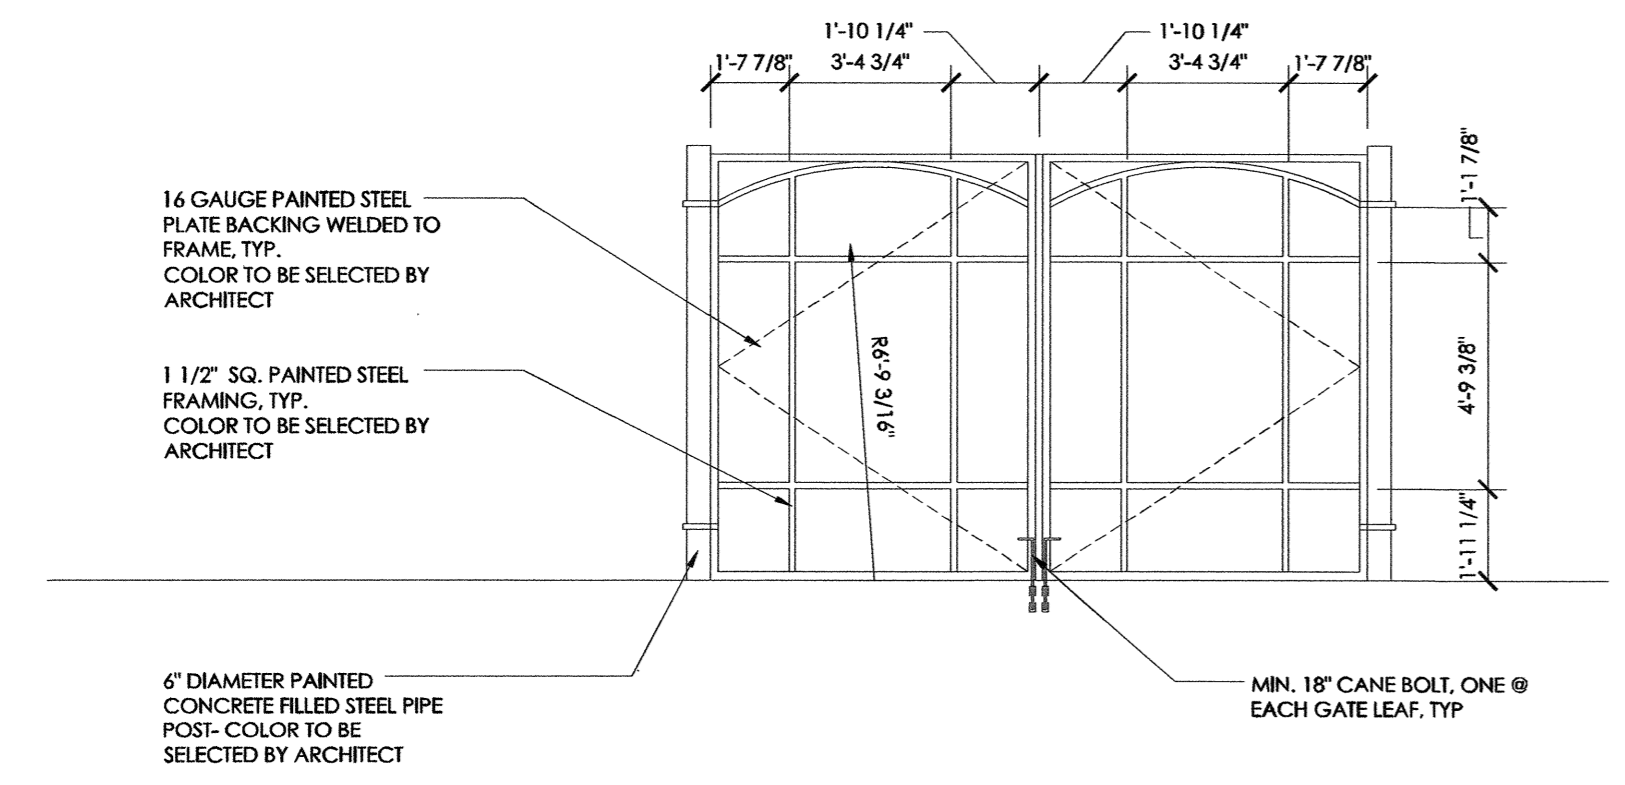

3 DUMPSTER ENCLOSURE ELEVATION
1/4" = 1'-0"

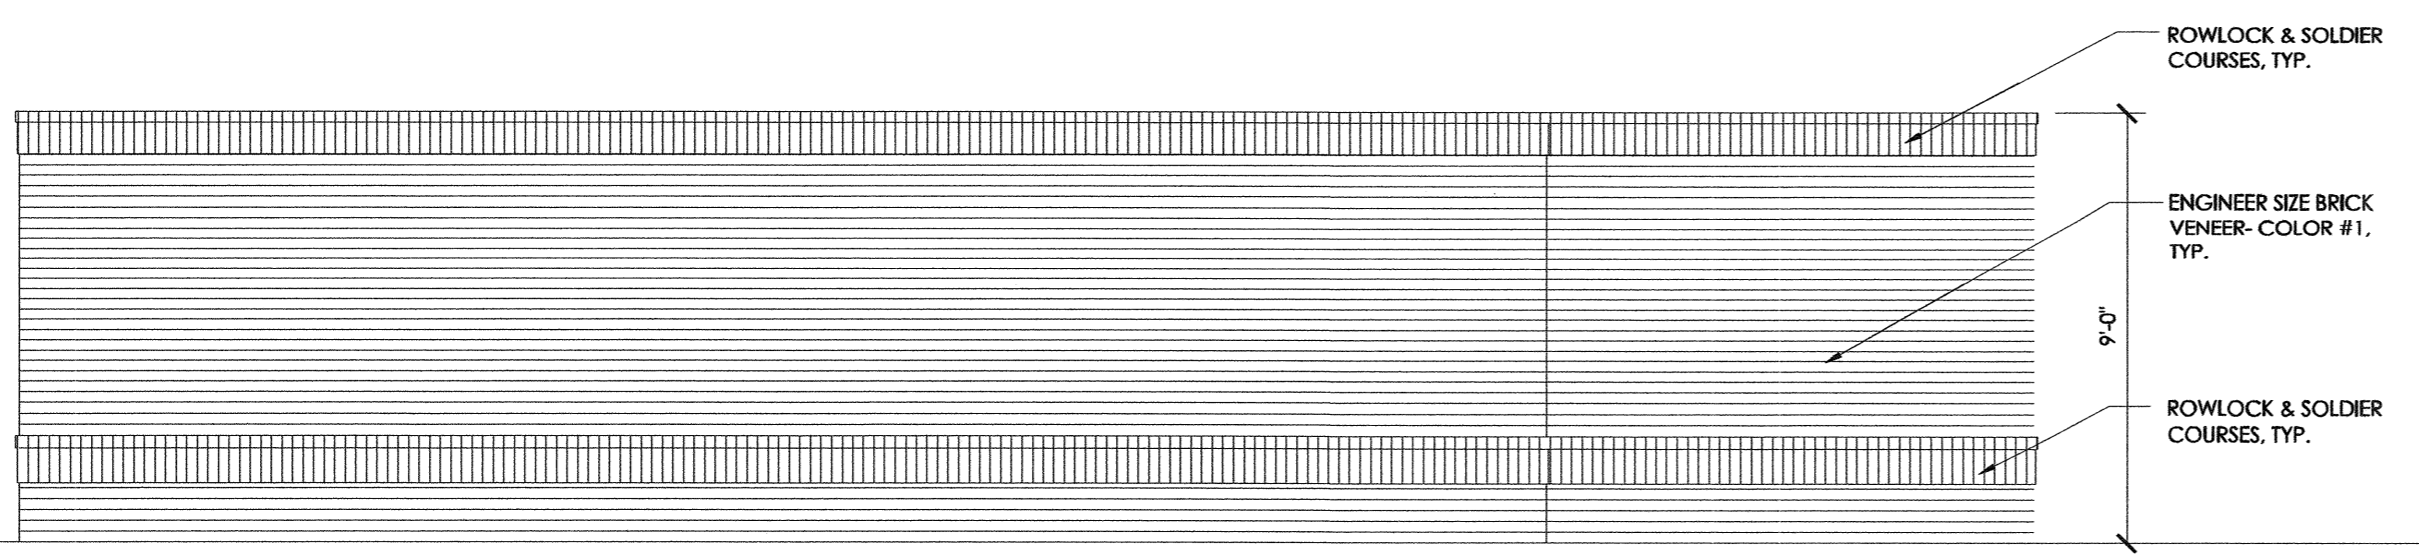

2 DUMPSTER ENCLOSURE ELEVATION
1/4" = 1'-0"

BUILDING DATA PHASE I

BUILDING TYPE	# ON SITE	STORIES	HEIGHT	UNITS/BUILDING	UNITS/TOTAL	BLDG. AREA TOTAL	FOOTPRINT TOTAL
TYPE I	1	3	39'±	24	24	25,563 SF	10,955 SF
TYPE II	1	3	38.5'±	24	24	31,875 SF	13,350 SF
TYPE III	2	3	38'±	30	60	51,126 SF	21,460 SF
TYPE IV	1	4	49.5'±	32	32	40,126 SF	13,020 SF
TYPE V	1	2	33'±	5	5	9,330 SF	6,000 SF
GARAGE	3	1	14.5'±			6,321 SF	6,321 SF
MAIL KIOSK	1	1	14.5'±			544 SF	830 SF
POOL HOUSE	1	1	14.5'±			683 SF	1,380 SF
TOTAL	11				145	165,568 SF	73,316 SF

BUILDING TYPE	CONSTRUCTION TYPE	1 BR	2 BR	3 BR	TOTAL UNITS	BLDG AREA	FOOT PRINT	APPROX. BLDG. DIMS AT WIDEST POINT
TYPE I	V-B	12	12		24	25,563 SF	10,955 SF	150' X 79'
TYPE II	V-B		12	12	24	31,875 SF	13,350 SF	197' X 75'
TYPE III	V-B	24	6		30	25,563 SF	10,730 SF	142' X 83'
TYPE IV	V-A		32		32	40,126 SF	13,020 SF	177' X 79'
TYPE V		5			5	9,330 SF	6,000 SF	123' X 65'
GARAGE						2,107 SF	2,107 SF	81' X 26'
MAIL KIOSK						544 SF	830 SF	43' X 21'
POOL HOUSE						683 SF BLDG. 697 SF CANOPY	1,380 SF	47.5' X 20' 20' X 34'

WATER/SEWER USAGE PHASE I

BLDG. TYPE	DOMESTIC GPM*	DOMESTIC GPD*	NCDENR SEWER (15A, 2T RULES GPD)
TYPE I	55 GPM	2160 GPD	24X240 GPD=5760 GPD
TYPE II	60.5 GPM	3600 GPD	12X240 GPD+12X360 GPD=7200 GPD
TYPE III	56.4 GPM	2160 GPD	30X240 GPD=7200 GPD
TYPE IV	74 GPM	3840 GPD	32X240 GPD=7680 GPD
TYPE V	30.8 GPM	1300 GPD	5X240 GPD+2X25 GPD=1250 GPD

*INFORMATION PROVIDED BY PLUMBING ENGINEER

SITE DATA TABLE PHASE I	
USE:	MULTI-FAMILY APARTMENTS
TOTAL SITE AREA:	10.81 ACRES (470,887 SF)
UPLAND AREA:	7.41 ACRES (322,868 SF)
WETLAND AREA:	2.32 ACRES (101,190 SF)
RIGHT-OF-WAY AREA:	1.07 ACRES (46,629 SF)
PARCEL ID#:	R08109-004-024-000
MAP ID#:	313609.16.2484.000
ZONING:	MF-M
CAMA LAND USE:	URBAN
BUILDING SETBACKS: (REQUIRED)	FRONT SETBACK: 35' TYPICAL, (BLDG. #1 39' MIN.) INTERIOR SIDE SETBACK: 20' TYPICAL, (BLDG. #2 24' MIN.) CORNER SIDE SETBACK: 30' REAR SETBACKS: 25' TYPICAL, (BLDG. #3 29' MIN.)
BUILDING SETBACKS: (PROPOSED)	FRONT SETBACK: 47.84' INTERIOR SIDE SETBACK: 24' CORNER SIDE SETBACK: N/A REAR SETBACKS: 29'
MAX. LOT COVERAGE:	30%
PROPOSED LOT COVERAGE:	15.57%
MAX. BUILDING HEIGHT:	96' (HEIGHTS OVER 35' REQUIRE ADDITIONAL SETBACK)
PROPOSED MAX. BUILDING HEIGHT:	49.5'±
PARKING REQUIREMENT	
PARKING REQ'D: MULTI-FAMILY	MAX.: 2.5 SPACES PER UNIT MIN.: 1 BR-1.5 PER UNIT 2 BR-2 PER UNIT 3 BR-2.25 PER UNIT
REQUIRED MAX:	(65+68+12)=145X2.5=363
REQUIRED MIN:	1 BR (65X1.5)=98 2 BR (68X2)=136 3 BR (12X2.25)=27 TOTAL=261 HC ACCESSIBLE=6
PROVIDED:	OFF STREET: 245 HC ACCESSIBLE: 7 GARAGE: 18 (INCLUDES 1 HC PER GARAGE) ON STREET: 3 TOTAL: 273
BICYCLE PARKING:	15 PROVIDED
IMPERVIOUS AREA:	
BUILDINGS:	73,316 SF
ASPHALT, CURB AND GUTTER (SITE):	90,850 SF
ASPHALT, CURB AND GUTTER (ROW):	32,634 SF
SIDEWALK/CONCRETE:	29,000 SF
EXISTING MUP:	2,500 SF
TOTAL:	228,300 SF
PROPOSED % IMPERVIOUS:	48.50%
LANDSCAPING REQUIREMENTS (REFER TO LANDSCAPE PLAN)	
15 TREES PER DISTURBED ACRE REQUIRED	
DISTURBED AREA=8.75 AC X 15=131 TREES	
INTERIOR LANDSCAPING: 20% CANOPY COVER OF INTERIOR AREA OF PARKING FACILITY	
STREET/PAVING LANDSCAPING: 18 MULTIPLIER	
FOUNDATION PLANTINGS: 12% FACE OF BUILDING X LENGTH	
OPEN SPACE: REFER TO SRB PLAN SHEET C4.1	
OPEN SPACE REQUIRED: 35% OF TRACT MINUS WETLANDS, 17.5% EITHER ACTIVE OR PASSIVE, 17.5% ACTIVE, PASSIVE, RECREATION, OR OPEN SPACE.	


SYMBOL	DATE	DESCRIPTION	BY
		REVISIONS	

SITE DATA
TIBURON PARC APARTMENTS
 2945 MOYNET WAY
 WILMINGTON, NORTH CAROLINA

OWNER:
 NELSON MACRAE
 MIDTOWN ONE, LLC
 P.O. BOX 3145
 WILMINGTON, N.C. 28406
 910-392-3300

NORRIS & TUNSTALL
CONSULTING ENGINEERS, INC.
 1127 FLORAL PARKWAY
 SUITE 400
 WILMINGTON, NC, 28403
 PHONE (910) 343-9653
 FAX (910) 343-9604
 office@nteng.com
 licence #JC-3641


HUD/PERMIT SET
12073
 DES. JST
 CKD. JPN
 DRWN. NKS
 DATE 5/2/13

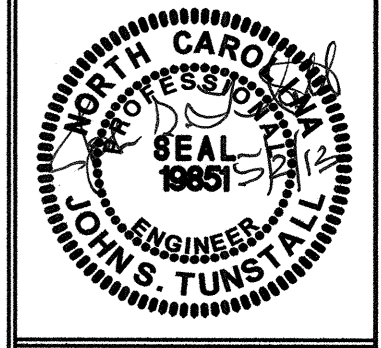

C1


For each open utility cut of City streets, a \$325 permit shall be required from the City prior to occupancy and/or project acceptance.

NCDENR PWSS WATER PERMIT #: _____
 WATER CAPACITY: _____ GPD
 DWQ SEWER PERMIT #: _____
 SEWER CAPACITY: _____ GPD
 SEWER SHED # AND PLANT: _____
 SEWER TO FLOW THROUGH NEI: YES or NO (CIRCLE ONE)

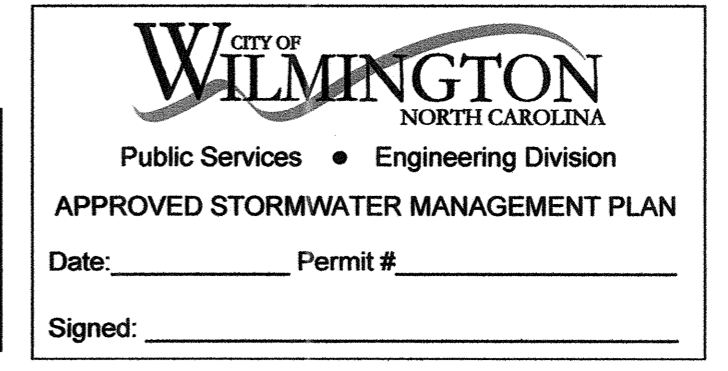

Approved Construction Plan
 Name _____ Date _____
 Planning _____
 Traffic _____
 Fire _____

F:\Projects\2012\12073 Midtown Apartments of Tiburon Parc\12073 Plans\wg\12073-master.r4.dwg, 5/2/2013 2:22:54 PM

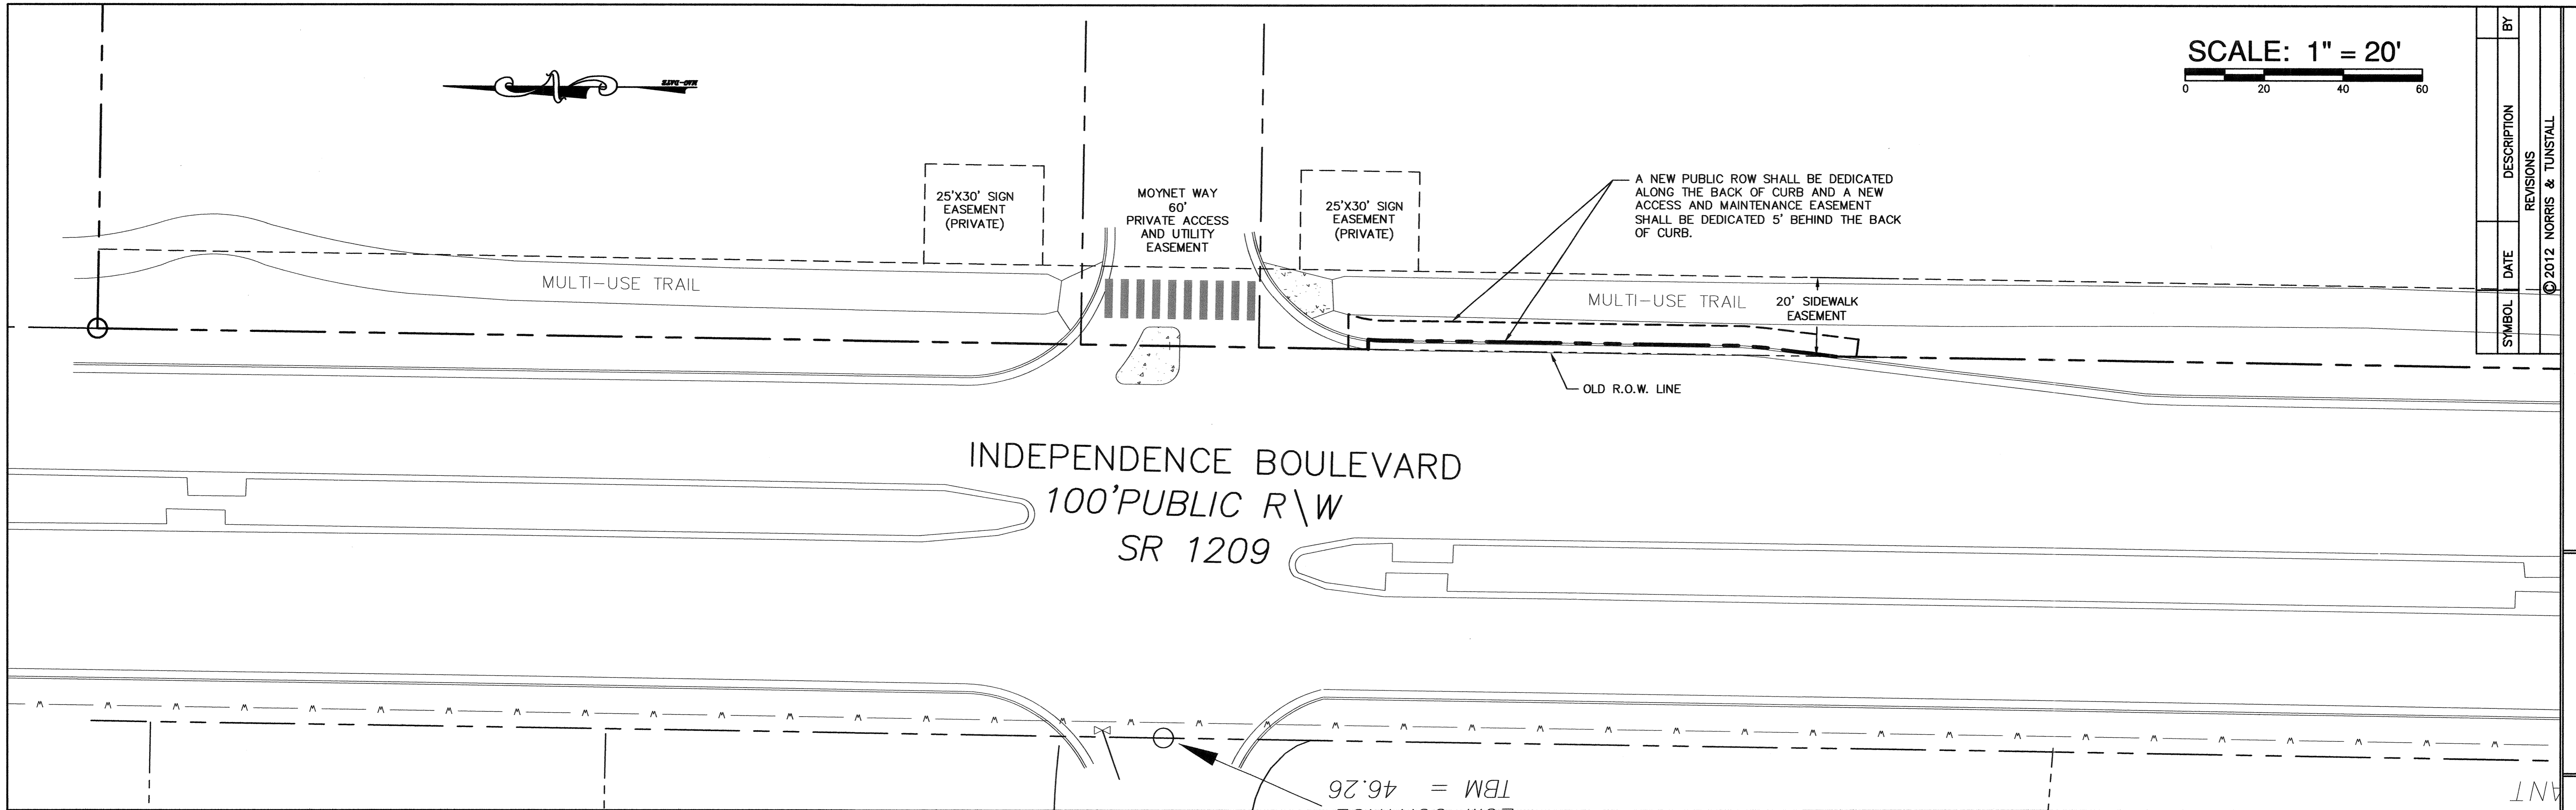


SCALE: 1" = 20'

SYMBOL	DATE	DESCRIPTION	BY
		REVISIONS	
		© 2012 NORRIS & TUNSTALL	

INDEPENDENCE BOULEVARD
100' PUBLIC R\W
SR 1209

RIGHT-OF-WAY DEDICATION AND
ACCESS AND MAINTENANCE EASEMENT
TIBURON PARC APARTMENTS
2945 MOYNET WAY
WILMINGTON, NORTH CAROLINA


OWNER:
NELSON MACRAE
MIDTOWN ONE, LLC
P.O. BOX 3145
WILMINGTON, N.C. 28408
910-392-3900

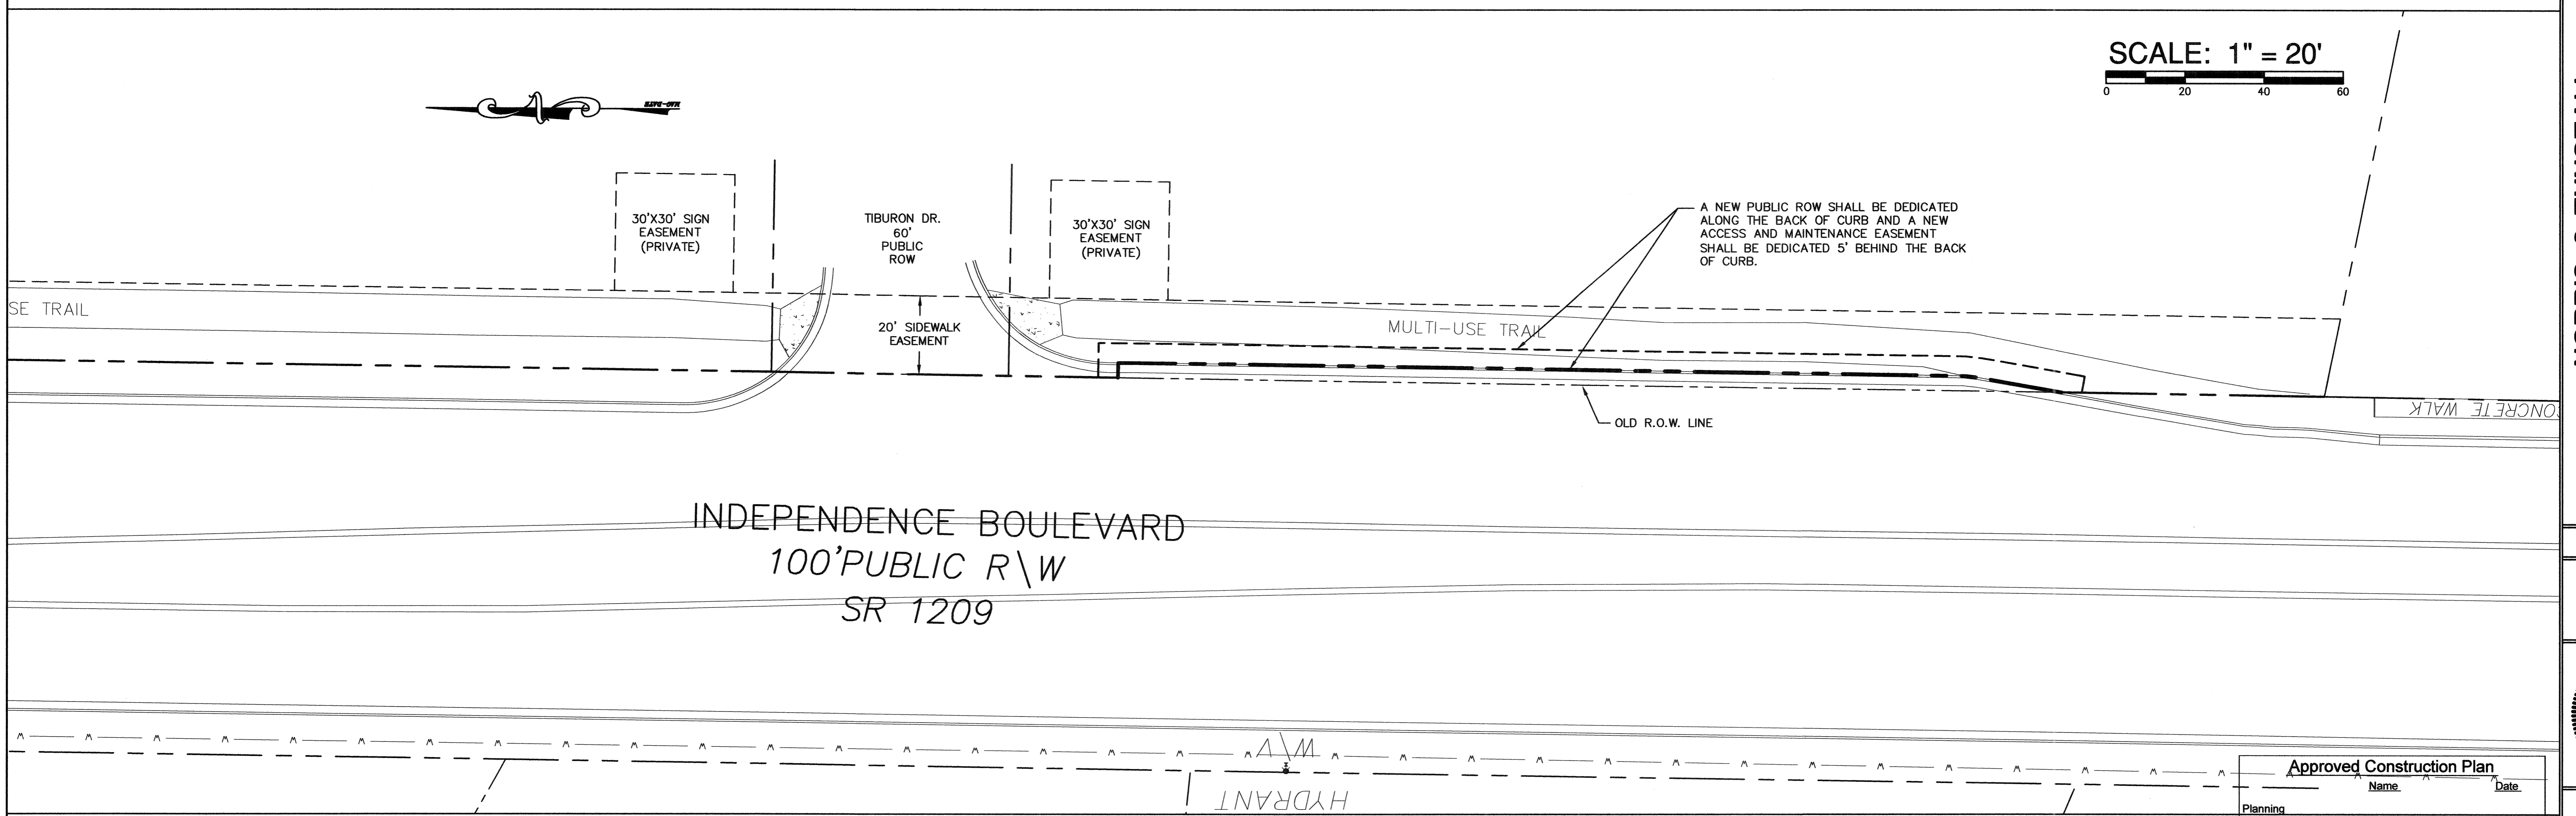

SCALE: 1" = 20'

NORRIS & TUNSTALL
CONSULTING ENGINEERS, INC.
1127 FLORAL PARKWAY
SUITE 400
WILMINGTON, NC, 28403
PHONE (910) 343-9653
FAX (910) 343-9604
office@nrteng.com
license #C-3641


HUD/PERMIT SET
12073
DES. JST
CHK. JPN
DRWN. NKS
DATE 5/2/13

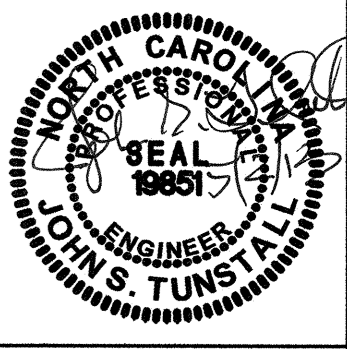

Approved Construction Plan

Name	Date
Planning	
Traffic	
Fire	

C10

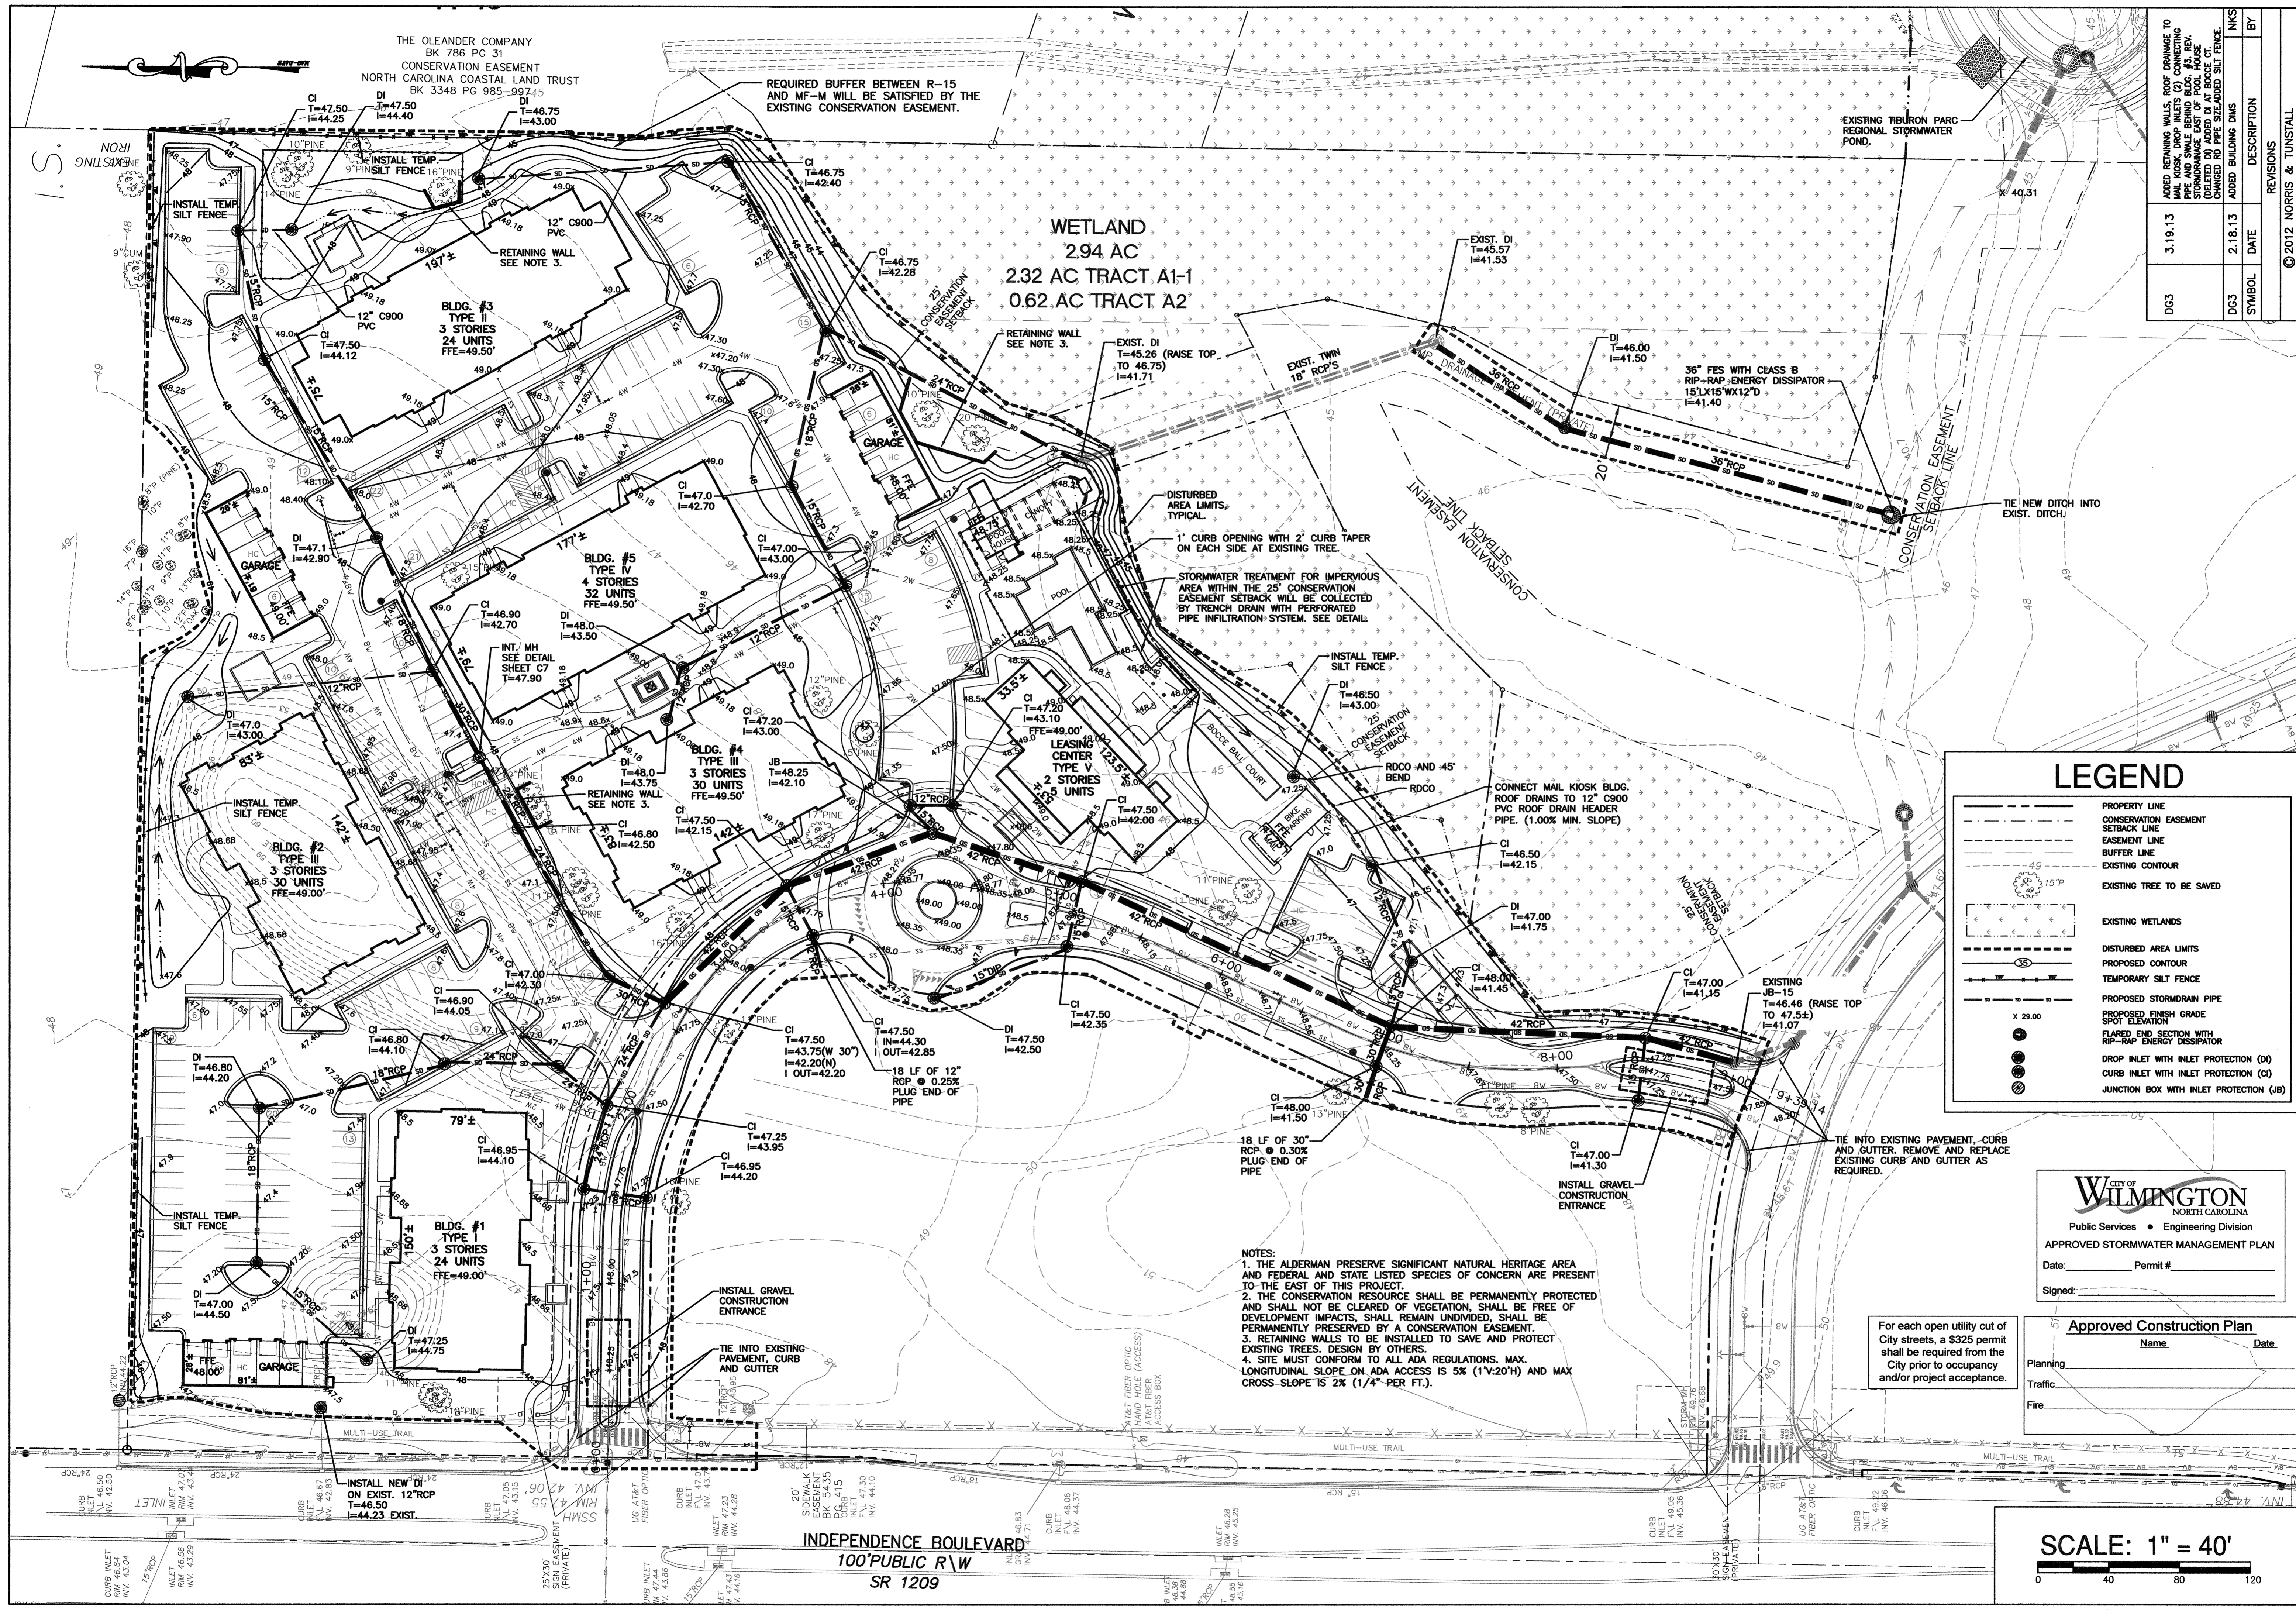

NO.	DATE	DESCRIPTION	BY
DG3	3.19.13	ADDED RETAINING WALLS, ROOF DRAINAGE TO MAIL KIOSK, DROP INLETS (D), CONNECTING PIPE AND SMALL BEING BLDG. #3, REV. STORMWATER EAST OF POOL HOUSE CHANGED TO PIPE SIZE ADDED SILT FENCE	NKS
DG3	2.18.13	ADDED BUILDING DIMS	NKS

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OWNER:
NELSON MACRAE
MIDTOWN ONE, LLC
P.O. BOX 3146
WILMINGTON, N.C. 28406
910-392-3300


NORRIS & TUNSTALL
CONSULTING ENGINEERS, INC.
1127 FLORAL PARKWAY
SUITE 400
WILMINGTON, NC, 28403
PHONE (910) 343-8653
FAX (910) 343-8604
office@nteng.com
license #G-3641

HUD/PERMIT SET
12073
DES. JST
CHK. JPN
DRWL. NKS
DATE 5/2/13

C2

LEGEND

	PROPERTY LINE
	CONSERVATION EASEMENT SETBACK LINE
	EASEMENT LINE
	BUFFER LINE
	EXISTING CONTOUR
	EXISTING TREE TO BE SAVED
	EXISTING WETLANDS
	DISTURBED AREA LIMITS
	PROPOSED CONTOUR
	TEMPORARY SILT FENCE
	PROPOSED STORM DRAIN PIPE
	PROPOSED FINISH GRADE SPOT ELEVATION
	FLARED END SECTION WITH RIP-RAP ENERGY DISSIPATOR
	DROP INLET WITH INLET PROTECTION (D)
	CURB INLET WITH INLET PROTECTION (C)
	JUNCTION BOX WITH INLET PROTECTION (JB)

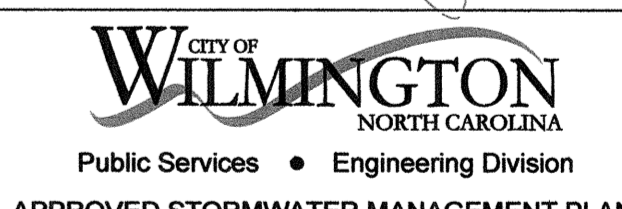

APPROVED STORMWATER MANAGEMENT PLAN
Date: _____ Permit # _____
Signed: _____

Approved Construction Plan
Name: _____ Date: _____

Planning _____
Traffic _____
Fire _____

For each open utility cut of City streets, a \$325 permit shall be required from the City prior to occupancy and/or project acceptance.

NOTES:
1. THE ALDERMAN PRESERVE SIGNIFICANT NATURAL HERITAGE AREA AND FEDERAL AND STATE LISTED SPECIES OF CONCERN ARE PRESENT TO THE EAST OF THIS PROJECT.
2. THE CONSERVATION RESOURCE SHALL BE PERMANENTLY PROTECTED AND SHALL NOT BE CLEARED OF VEGETATION, SHALL BE FREE OF DEVELOPMENT IMPACTS, SHALL REMAIN UNDIVIDED, SHALL BE PERMANENTLY PRESERVED BY A CONSERVATION EASEMENT.
3. RETAINING WALLS TO BE INSTALLED TO SAVE AND PROTECT EXISTING TREES. DESIGN BY OTHERS.
4. SITE MUST CONFORM TO ALL ADA REGULATIONS. MAX. LONGITUDINAL SLOPE ON ADA ACCESS IS 5% (1V:20H) AND MAX CROSS-SLOPE IS 2% (1/4" PER FT.).

SCALE: 1" = 40'


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INLET BASIN #	DA TOTAL (Ac)	TOTAL IMP. (Ac)
1	0.30	0.26
1A	0.11	0.10
2	0.12	0.02
3	0.27	0.25
3A	0.05	0.04
4	0.39	0.33
5	0.42	0.33
6	0.46	0.19
7	0.31	0.26
8	0.20	0.14
9	0.21	0.14
10	0.27	0.19
11	0.23	0.16
12	0.23	0.19
13	0.40	0.35
14	0.24	0.23
15	0.18	0.11
16	0.17	0.11
16A	0.07	0.04
17	0.38	0.23
17A	0.04	0.03
18	0.40	0.24
19	0.23	0.20
19A	0.10	0.05
20	0.12	0.11
20A	0.15	0.08
21	0.10	0.08
21A	0.22	0.17
22	0.19	0.15
22A	0.15	0.09
22B	0.11	0.07
23	0.00	0.00
24	0.29	0.25
25	0.15	0.15
26	0.17	0.04
27	0.12	0.11
28	0.22	0.15
29	0.03	0.03
30	0.17	0.12
31	0.11	0.09
32	0.10	0.07
33	2.33	1.70

**DA23 REMOVED BASED ON REV. TO SD SYSTEM 3-19-13

O&I-1
 R06109-004-027-000
 2025 INDEPENDENCE BLVD.
 NEW HANOVER BOARD OF EDUCATION
 ALDERMAN ELEMENTARY
 BK. 5430 PG. 1613

THE OLEANDER COMPANY
 BK 786 PG 31
 CONSERVATION EASEMENT
 NORTH CAROLINA COASTAL LAND TRUST
 BK 3348 PG 985-997

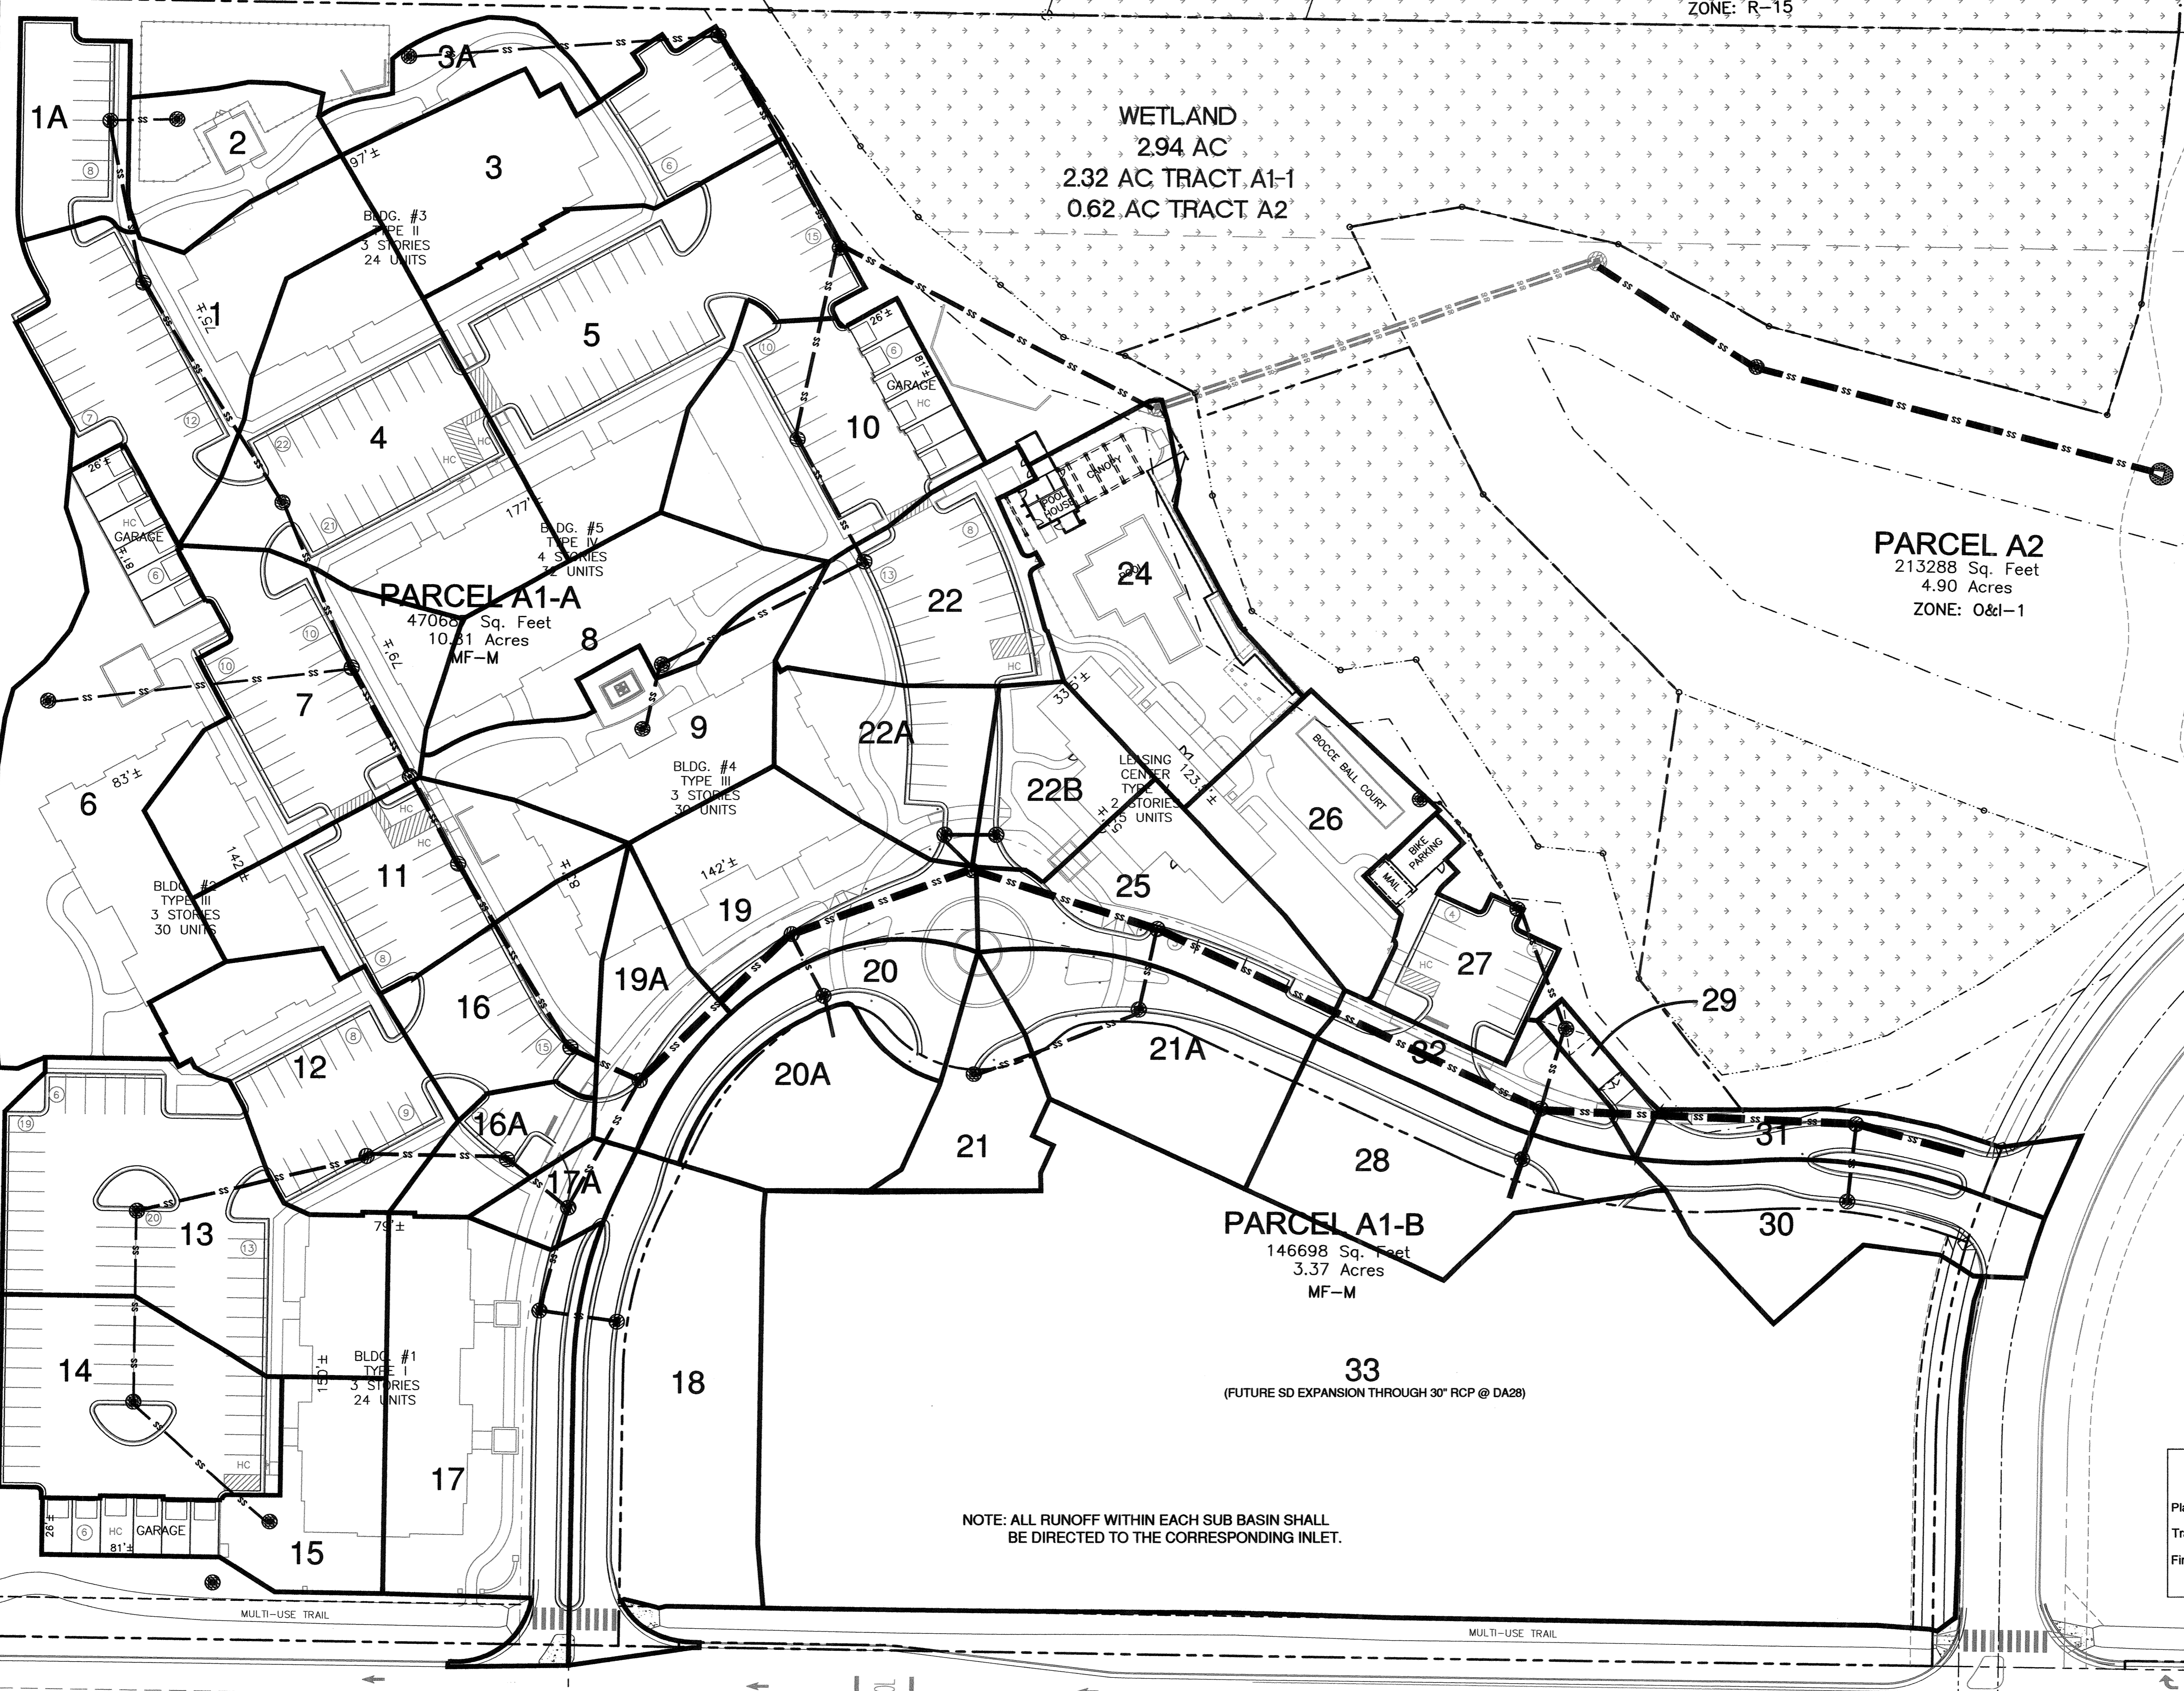

NOTE: ALL RUNOFF WITHIN EACH SUB BASIN SHALL BE DIRECTED TO THE CORRESPONDING INLET.

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WILMINGTON NORTH CAROLINA
 Public Services • Engineering Division
 APPROVED STORMWATER MANAGEMENT PLAN
 Date: _____ Permit # _____
 Signed: _____

Approved Construction Plan
 Name _____ Date _____
 Planning _____
 Traffic _____
 Fire _____

SCALE: 1" = 40'
 0 40 80 120

DC3	3.19.13	REVISED DRAINAGE AREAS	BY
SYMBOL	DATE	DESCRIPTION	
		REVISIONS	

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DRAINAGE AREA PLAN

TIBURON PARC APARTMENTS
 2945 MOYNET WAY
 WILMINGTON, NORTH CAROLINA

OWNER:
 NELSON MACRAE
 MIDTOWN ONE, LLC
 P.O. BOX 3146
 WILMINGTON, N.C. 28406
 910-392-3300

NORRIS & TUNSTALL
 CONSULTING ENGINEERS, INC.


1127 FLORAL PARKWAY
 SUITE 400
 WILMINGTON, NC 28403
 PHONE (910) 343-9853
 FAX (910) 343-9804
 office@nteng.com
 license #C-3681

HUD/PERMIT SET

12073

DES. JST
 CKD. JPN
 DRWN. NKS

DATE 5/2/13

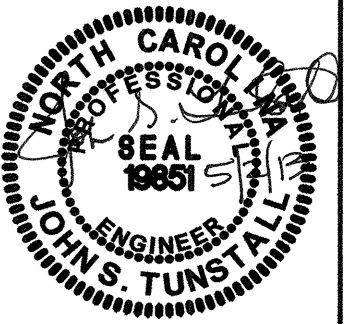

C2.1

WETLAND
294 AC
2.32 AC TRACT A1-1
0.62 AC TRACT A2

DC3	SYMBOL	DATE	ADDED BUILDING DIMS	DESCRIPTION	BY
2.18.13					

UTILITY PLAN
TIBURON PARC APARTMENTS
2945 MOYNET WAY
WILMINGTON, NORTH CAROLINA

OWNER:
NELSON MACRAE
MIDTOWN ONE, LLC
P.O. BOX 3146
WILMINGTON, N.C. 28406
910-392-9300

NORRIS & TUNSTALL
CONSULTING ENGINEERS, INC.
1127 FLORAL PARKWAY
SUITE 400
WILMINGTON, NC 28403
PHONE (910) 343-9653
FAX (910) 343-9604
office@nteng.com
license #C-3641

HUD/PERMIT SET
12073
DES. JST
CHK. JPN
DRWL. NKS
DATE 5/2/13

SCALE: 1" = 40'
0 40 80 120

C3

LEGEND

	PROPERTY LINE
	CONSERVATION EASEMENT SETBACK LINE
	EASEMENT LINE
	BUFFER LINE
	EXISTING TREE TO BE SAVED
	EXISTING WETLANDS
	PROPOSED STORMDRAIN PIPE
	PROPOSED WATERLINE SIZE VARIES SEE PLAN
	PROPOSED SANITARY SEWER
	PROPOSED FIRE HYDRANT

- UTILITY NOTES FOR FIRE HYDRANTS
- FIRE HYDRANTS MUST BE WITHIN 150' OF THE FIRE DEPARTMENT CONNECTION.
 - THE FIRE DEPARTMENT CONNECTION MUST BE WITHIN 40' OF FIRE APPARATUS PLACEMENT.
 - LANDSCAPING AND PARKING CANNOT BLOCK OR IMPEDE THE FIRE DEPARTMENT CONNECTIONS OR FIRE HYDRANTS. A 3' CLEAR SPACE SHALL BE MAINTAINED AROUND THE CIRCUMFERENCE OF THE FIRE HYDRANT CONNECTION AND THE FIRE HYDRANT.
 - FIRE HYDRANTS MUST BE LOCATED WITHIN 8' OF THE CURB.
 - NEW HYDRANTS MUST BE AVAILABLE FOR USE PRIOR TO CONSTRUCTION OF THE BUILDINGS.
 - THE CONTRACTOR SHALL MAINTAIN ALL WEATHER ACCESS FOR EMERGENCY VEHICLES AT ALL TIMES DURING CONSTRUCTION.
 - IT SHALL BE THE RESPONSIBILITY OF THE SUBDIVIDER TO ERECT OFFICIAL STREET NAME SIGNS AT ALL INTERSECTIONS ASSOCIATED WITH THE SUBDIVISION IN ACCORDANCE WITH THE TECHNICAL STANDARDS AND SPECIFICATIONS MANUAL. THE SUBDIVIDER MAY ACQUIRE AND ERECT OFFICIAL STREET NAME SIGNS OR MAY CHOOSE TO CONTRACT WITH THE CITY TO INSTALL THE STREET SIGNS AND THE SUBDIVIDER SHALL PAY THE COST OF SUCH INSTALLATION. CONTACT TRAFFIC ENGINEERING AT 341-7888 TO DISCUSS INSTALLATION OF APPROVED AND STREET NAME SIGNS. PROPOSED STREET NAMES MUST BE TRAFFIC PRIOR TO INSTALLATION OF STREET NAME SIGNS.
 - UNDERGROUND FIRE LINE AND PRIVATE WATER MAINS MUST BE PERMITTED AND INSPECTED BY THE WILMINGTON FIRE DEPARTMENT FROM THE PUBLIC RIGHT-OF-WAY TO THE BUILDING. CONTACT THE WILMINGTON FIRE DEPARTMENT DIVISION OF FIRE AND LIFE SAFETY AT 910-343-0696 FOR ADDITIONAL INFORMATION.
 - A MINIMUM OF 5' SHALL SEPARATE UNDERGROUND FIRE LINES OR PRIVATE WATER MAINS FROM OTHER UNDERGROUND UTILITIES.
- NOTE: SEE WATER AND STORMDRAIN CROSSING DETAILS (A) THRU (P) SHEET PR4.

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Approved Construction Plan

Name _____ Date _____

Planning _____

Traffic _____


Fire _____

NC DENR PWSS WATER PERMIT #: _____
WATER CAPACITY: _____ GPD


DWQ SEWER PERMIT #: _____
SEWER CAPACITY: _____ GPD

SEWER SHED # AND PLANT: _____
SEWER TO FLOW THROUGH NEI: YES or NO (CIRCLE ONE)

REMOVE AND REPLACE EXIST. MUP AS REQUIRED FOR WATERLINE INSTALLATION.

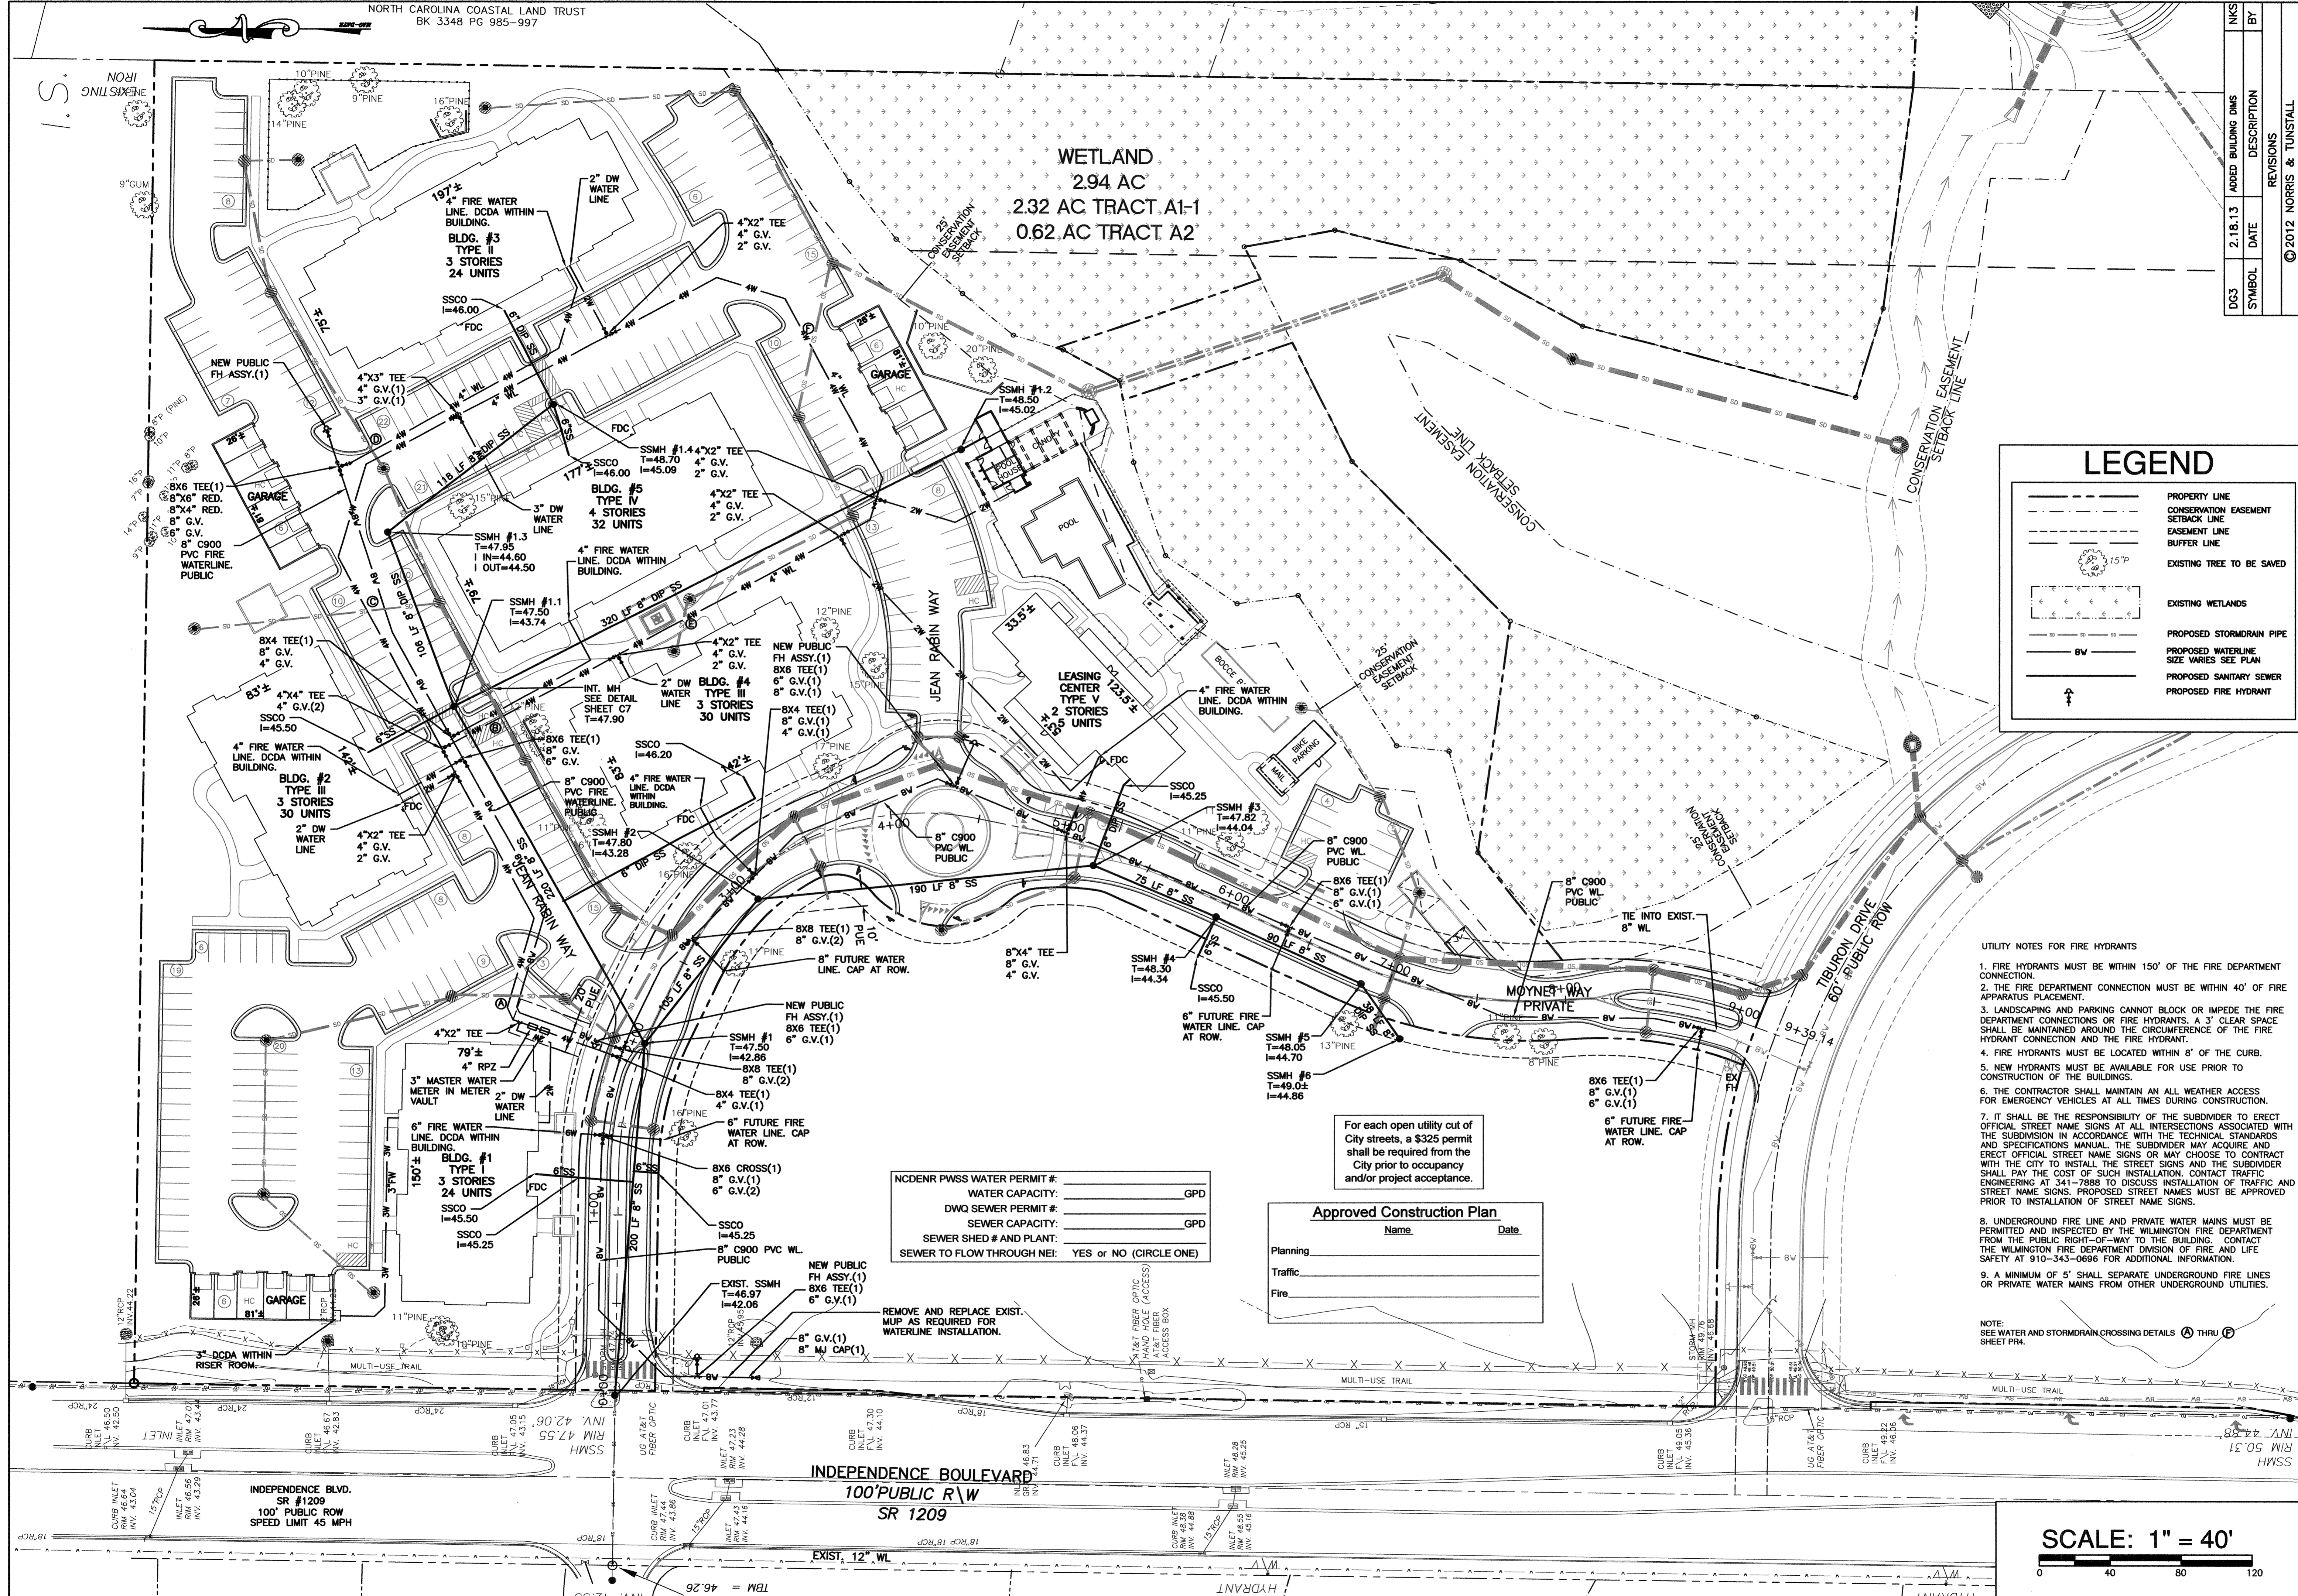

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SYMBOL	DATE	DESCRIPTION	BY
DG3	3.19.13	USED RETAINING WALLS, ROOT BRANCHES TO MAIN MUSIC DROP INLETS (2) CONNECTING STORMWATER EAST OF POOL HOUSE (DELETED D1).	
DG3	2.18.13	ADDED BUILDING DIMENSIONS, SIDEWALK DIMENSIONS, SIDEWALK SPACES, DRIVEWAY SPACES, PROVIDED 7' RC ACCESSIBLE PATH TO DUMPSTER.	

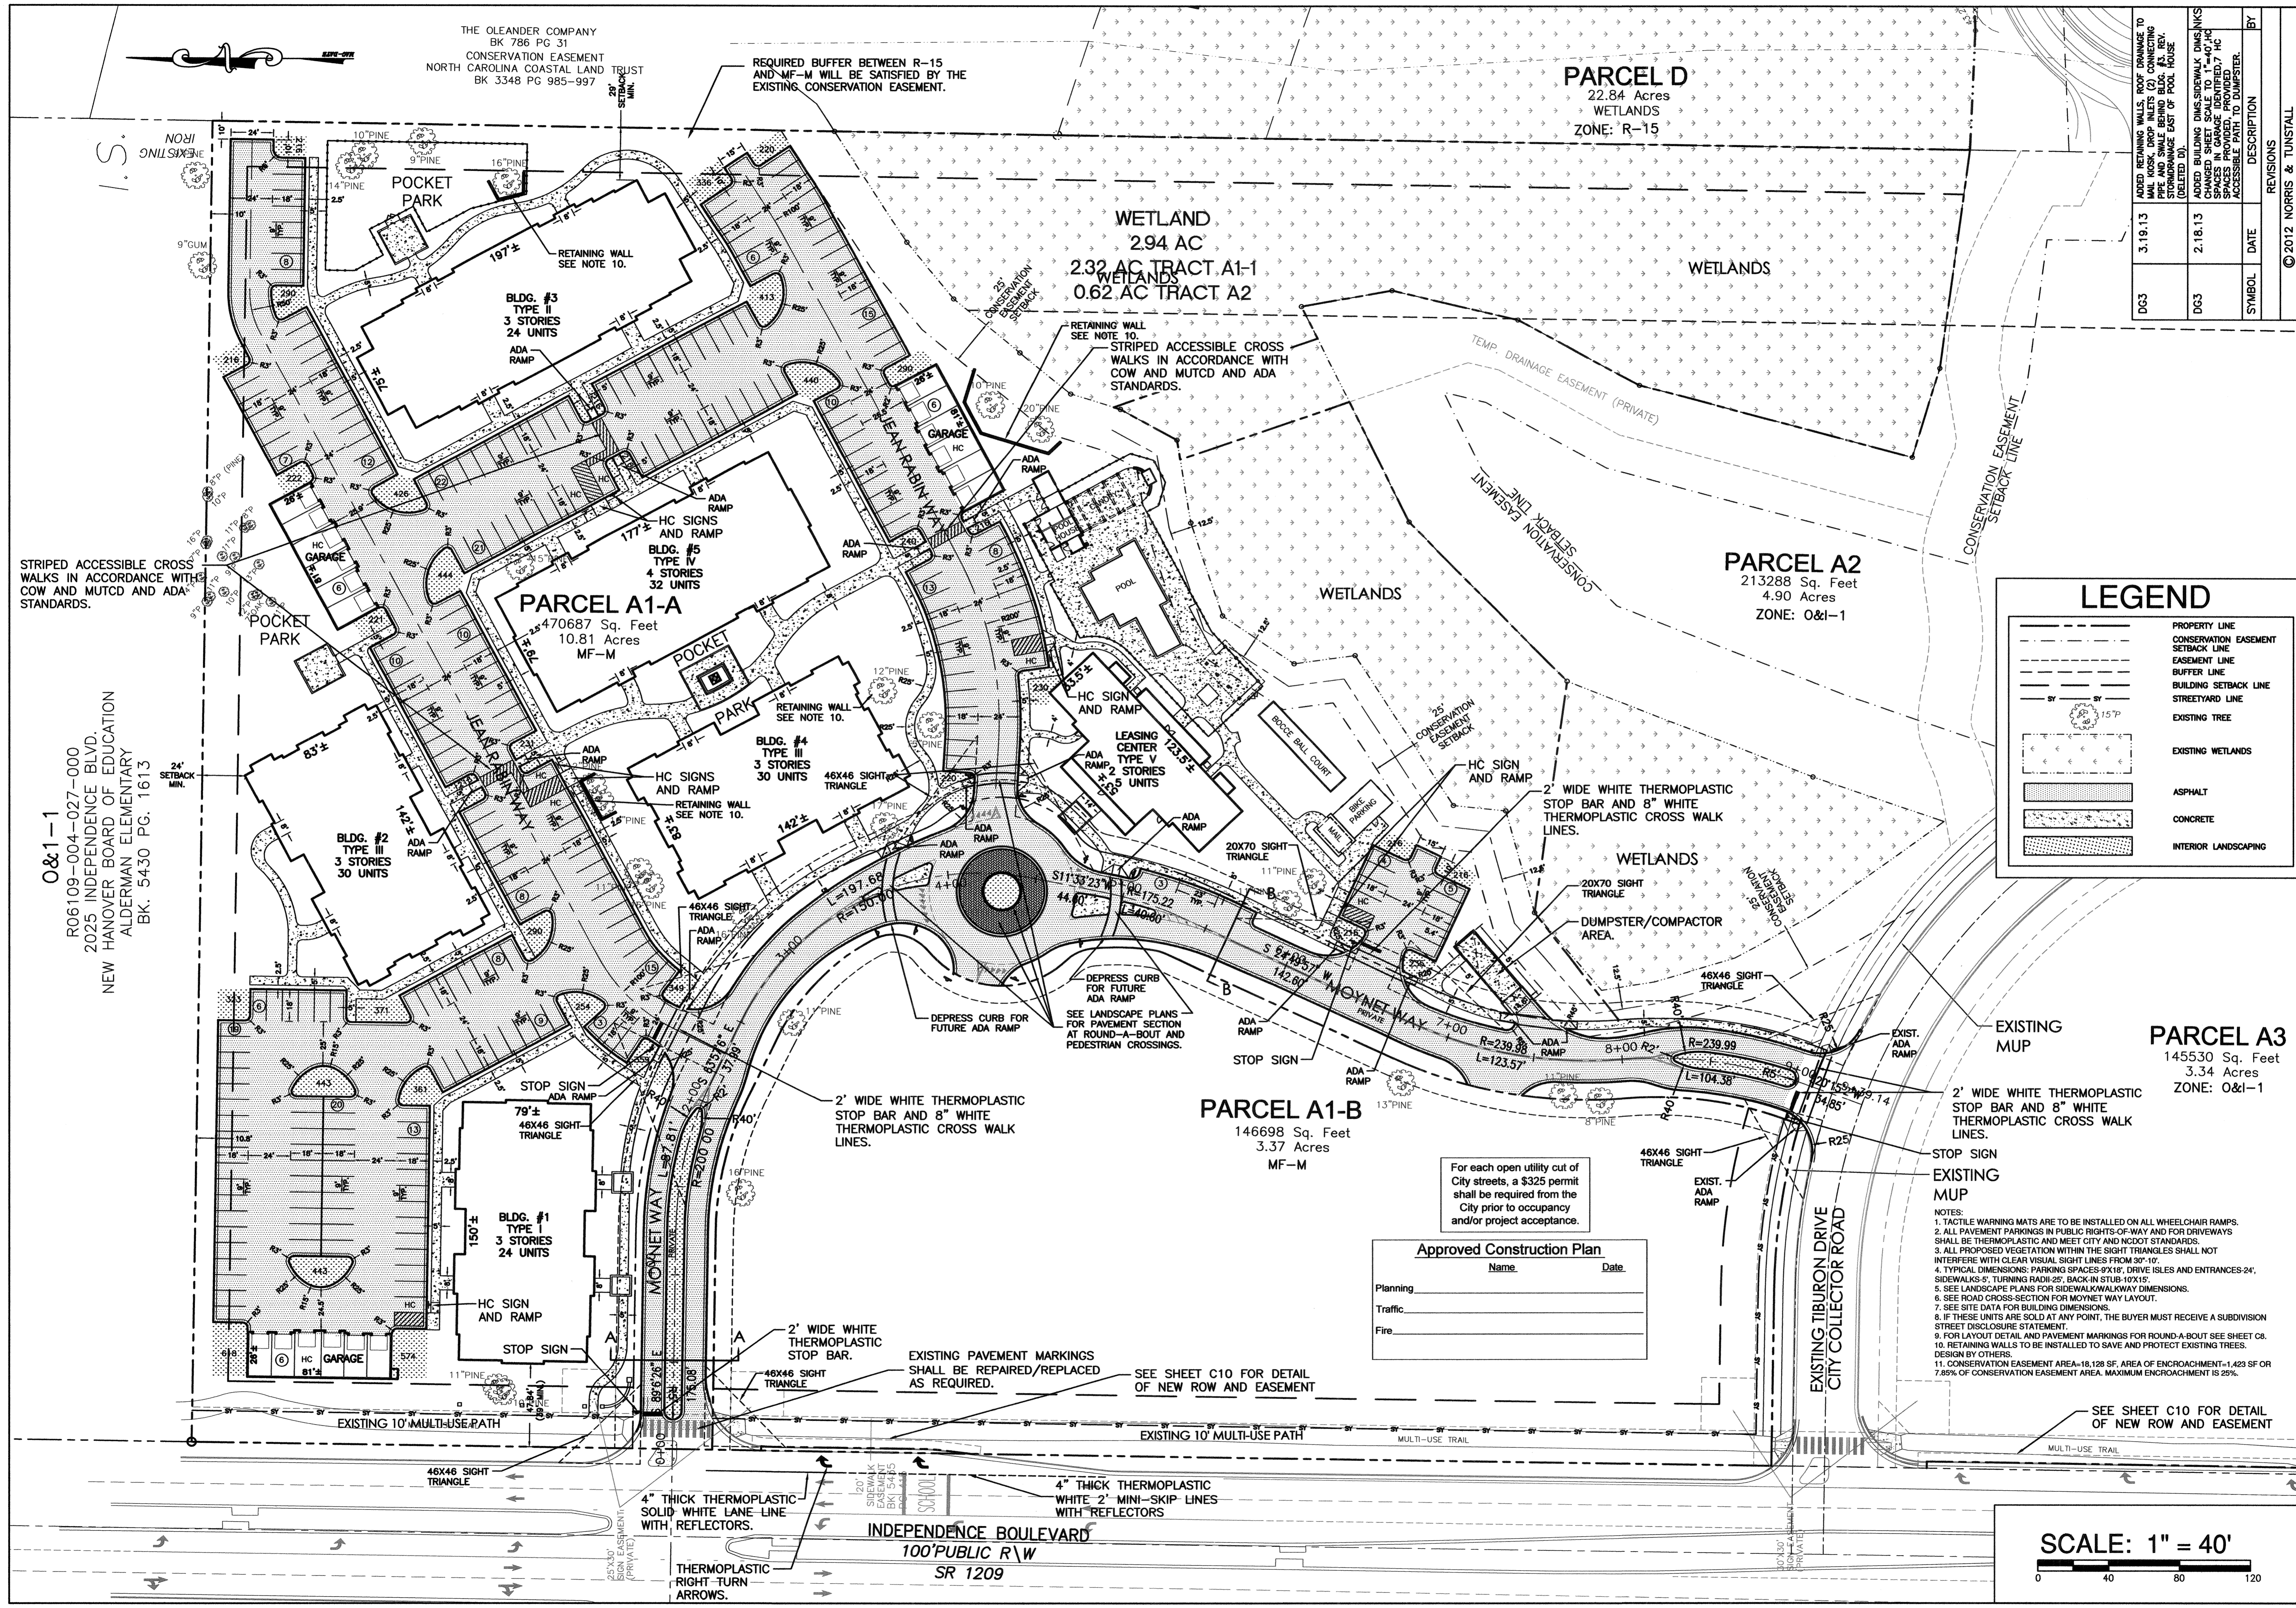LEGEND

	PROPERTY LINE
	CONSERVATION EASEMENT SETBACK LINE
	EASEMENT LINE
	BUFFER LINE
	BUILDING SETBACK LINE
	STREETYARD LINE
	EXISTING TREE
	EXISTING WETLANDS
	ASPHALT
	CONCRETE
	INTERIOR LANDSCAPING

Approved Construction Plan

Name _____ Date _____

Planning _____

Traffic _____

Fire _____

SCALE: 1" = 40'

0 40 80 120

LAYOUT PLAN
TIBURON PARC APARTMENTS
2945 MOYNET WAY
WILMINGTON, NORTH CAROLINA

OWNER:
NELSON MACRAE
MIDTOWN ONE, LLC
P.O. BOX 3145
WILMINGTON, N.C. 28406
910-392-3300

NORRIS & TUNSTALL
CONSULTING ENGINEERS, INC.
1127 FLORAL PARKWAY
SUITE 400
WILMINGTON, NC, 28403
PHONE (910) 343-8653
FAX (910) 343-8604
office@nteng.com
license #C-3641

HUD/PERMIT SET
12073

DES. JST
CKD. JPN
DRWL. NKS

DATE 5/2/13

C4

THE OLEANDER COMPANY
BK 786 PG 31
CONSERVATION EASEMENT
NORTH CAROLINA COASTAL LAND TRUST
BK 3348 PG 985-997

PARCEL D
22.84 Acres
WETLANDS
ZONE: R-15

WETLAND
2.94 AC
2.32 AC TRACT A1-1
0.62 AC TRACT A2


PARCEL A2
213288 Sq. Feet
4.90 Acres
ZONE: O&I-1

PARCEL A1-A
470687 Sq. Feet
10.81 Acres
MF-M

PARCEL A1-B
146698 Sq. Feet
3.37 Acres
MF-M

PARCEL A3
145530 Sq. Feet
3.34 Acres
ZONE: O&I-1

O&I-1
R06109-004-027-000
2025 INDEPENDENCE BLVD.
NEW HANOVER BOARD OF EDUCATION
ALDERMAN ELEMENTARY
BK. 54-30 PG. 1613

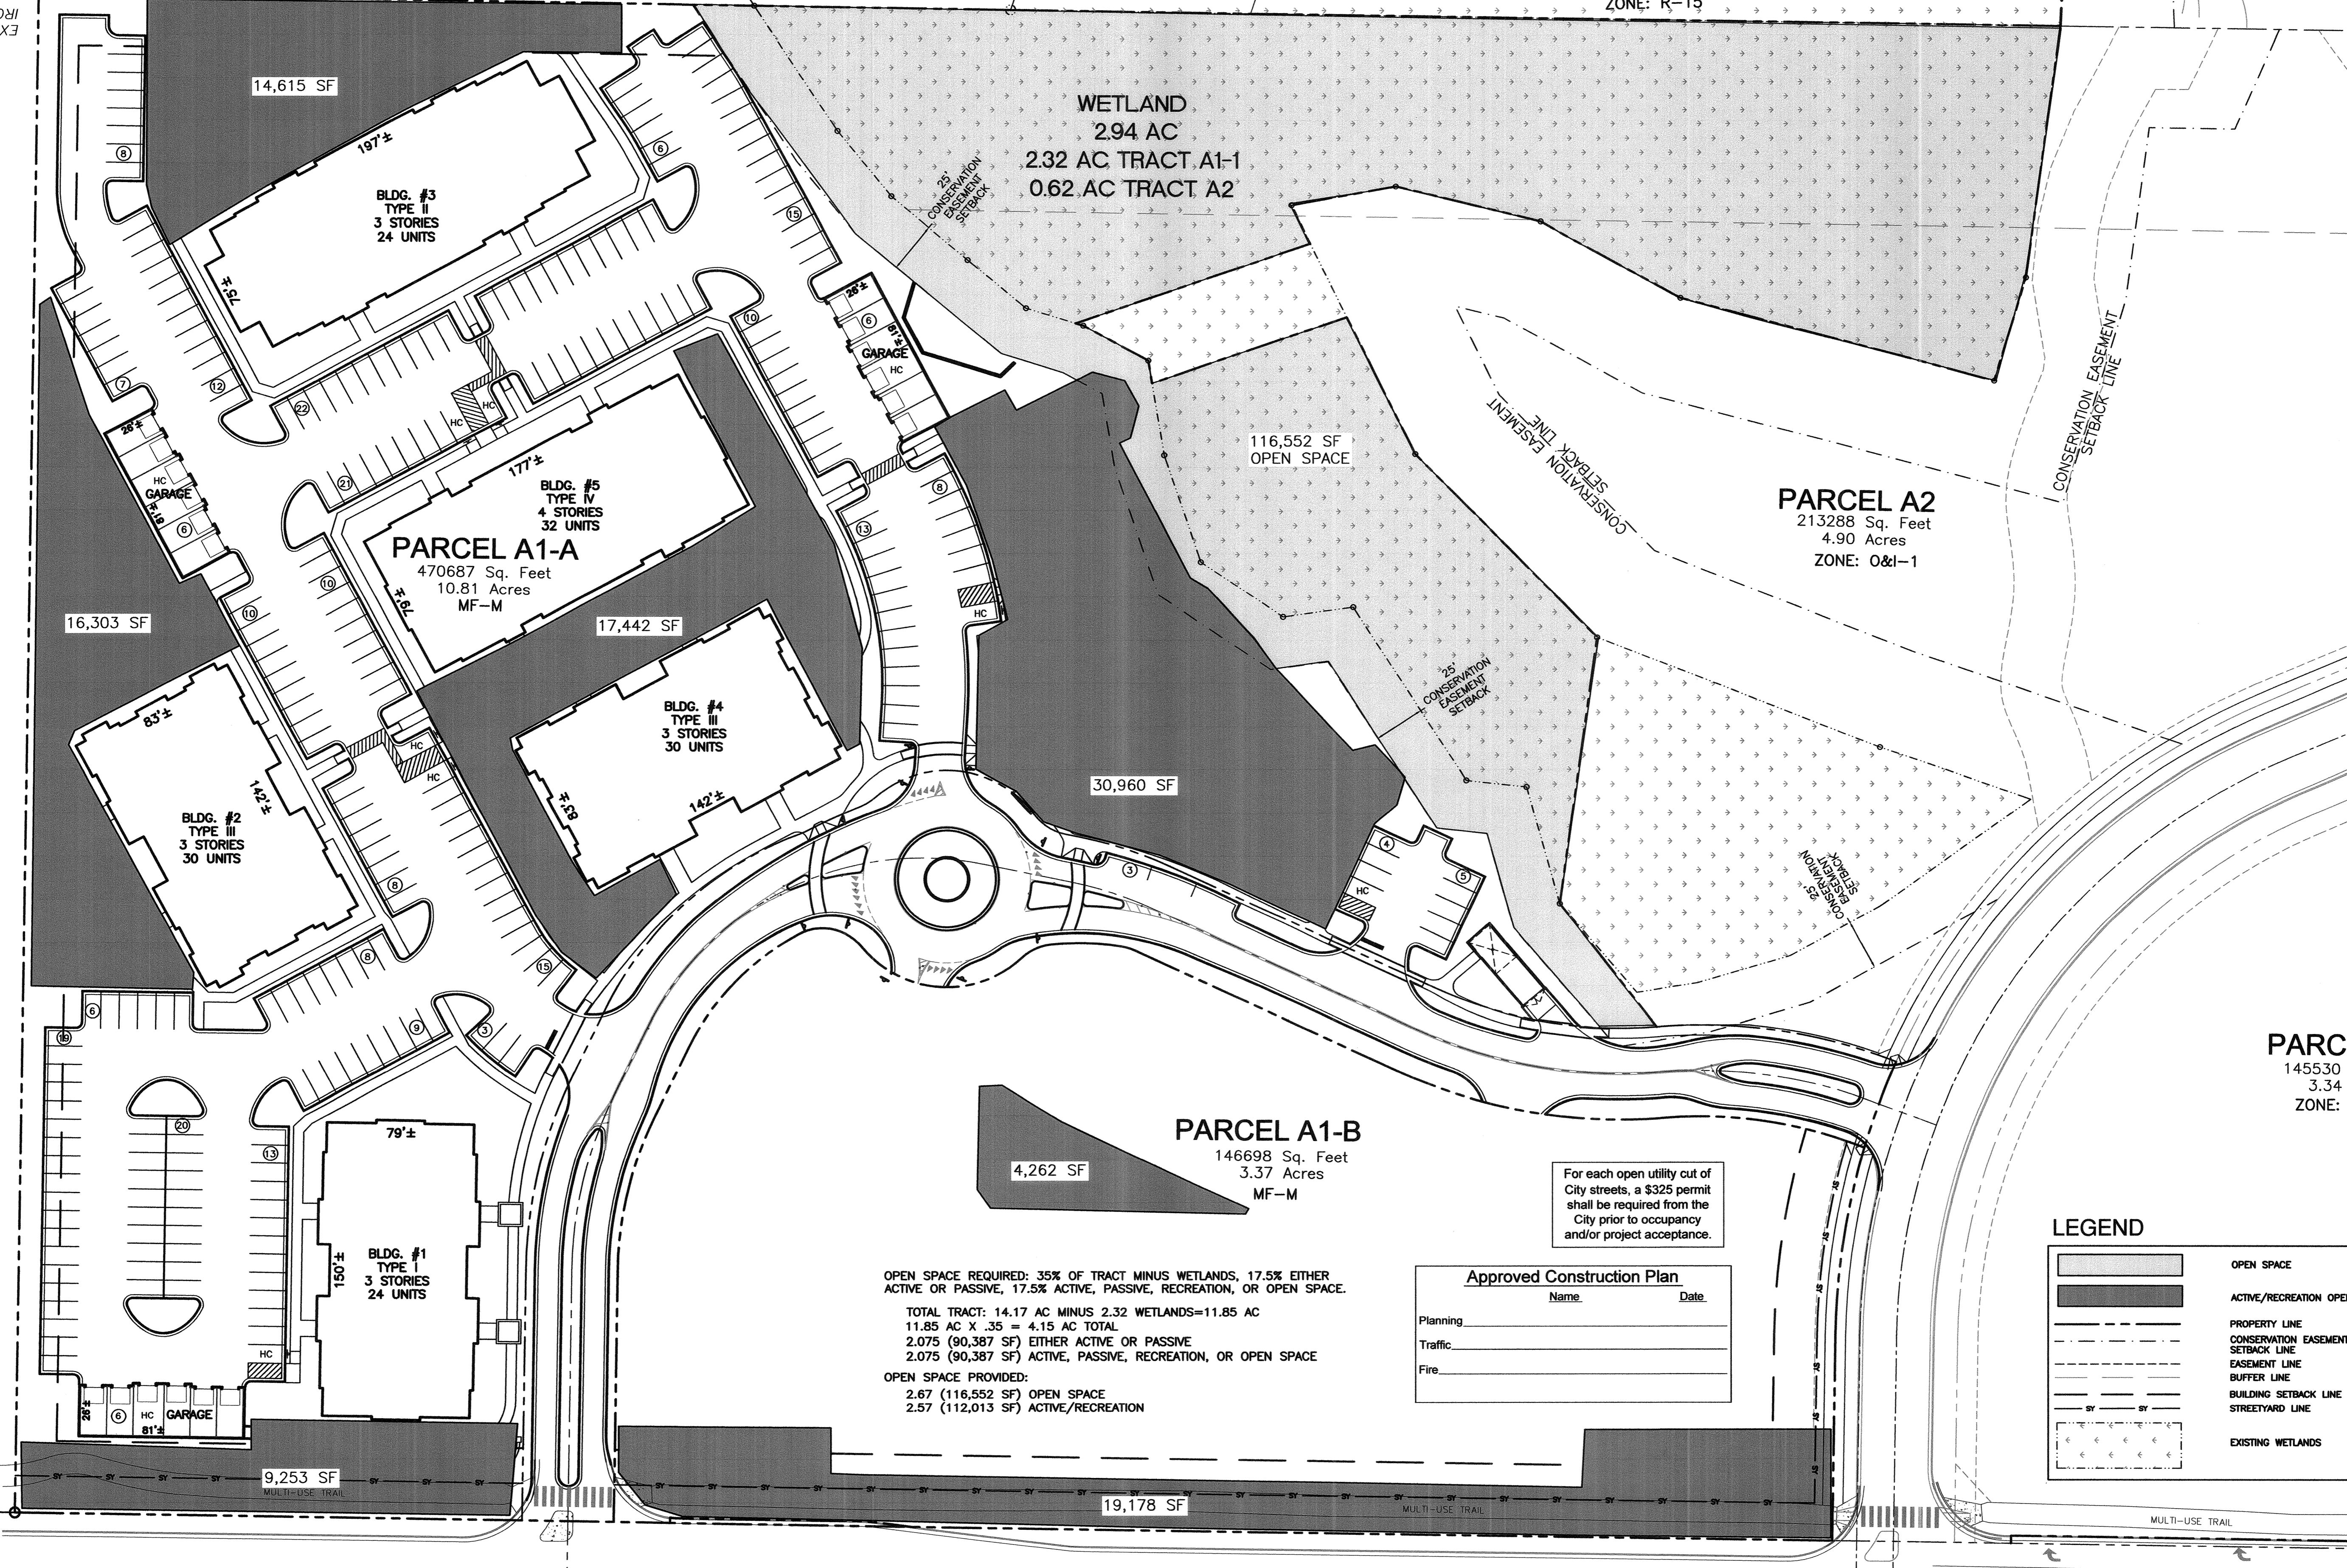

OPEN SPACE REQUIRED: 35% OF TRACT MINUS WETLANDS. 17.5% EITHER ACTIVE OR PASSIVE, 17.5% ACTIVE, PASSIVE, RECREATION, OR OPEN SPACE.
TOTAL TRACT: 14.17 AC MINUS 2.32 WETLANDS=11.85 AC
11.85 AC X .35 = 4.15 AC TOTAL
2.075 (90,387 SF) EITHER ACTIVE OR PASSIVE
2.075 (90,387 SF) ACTIVE, PASSIVE, RECREATION, OR OPEN SPACE
OPEN SPACE PROVIDED:
2.67 (116,552 SF) OPEN SPACE
2.57 (112,013 SF) ACTIVE/RECREATION

For each open utility cut of City streets, a \$325 permit shall be required from the City prior to occupancy and/or project acceptance.

Approved Construction Plan

Name	Date
Planning	
Traffic	
Fire	

LEGEND

[Symbol]	OPEN SPACE
[Symbol]	ACTIVE/RECREATION OPEN SPACE
[Symbol]	PROPERTY LINE
[Symbol]	CONSERVATION EASEMENT
[Symbol]	SETBACK LINE
[Symbol]	EASEMENT LINE
[Symbol]	BUFFER LINE
[Symbol]	BUILDING SETBACK LINE
[Symbol]	STREETYARD LINE
[Symbol]	EXISTING WETLANDS

INDEPENDENCE BOULEVARD
100' PUBLIC R\W
SR 1209

SCALE: 1" = 40'
0 40 80 120


BY	DESCRIPTION	DATE	REVISIONS

OPEN SPACE PLAN
TIBURON PARC APARTMENTS
2945 MOYNET WAY
WILMINGTON, NORTH CAROLINA

OWNER:
NELSON MACRAE
MIDTOWN ONE, LLC
P.O. BOX 3146
WILMINGTON, N.C. 28406
910-392-3300


NORRIS & TUNSTALL
CONSULTING ENGINEERS, INC.
1127 FLORAL PARKWAY
SUITE 400
WILMINGTON, NC, 28403
PHONE (910) 343-9653
FAX (910) 343-9604
office@ntkg.com
license #0-3641

12073
DES. JST
CHK. JPN
DRWN. NKS
DATE 5/2/13

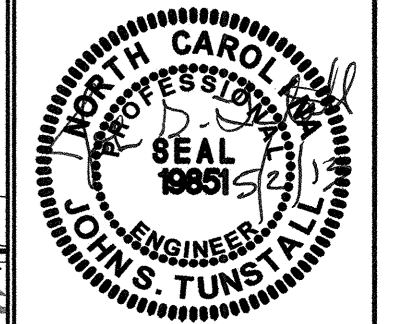

C4.1

THE OLEANDER COMPANY
BK 786 PG 31
CONSERVATION EASEMENT
NORTH CAROLINA COASTAL LAND TRUST
BK 3348 PG 985-997

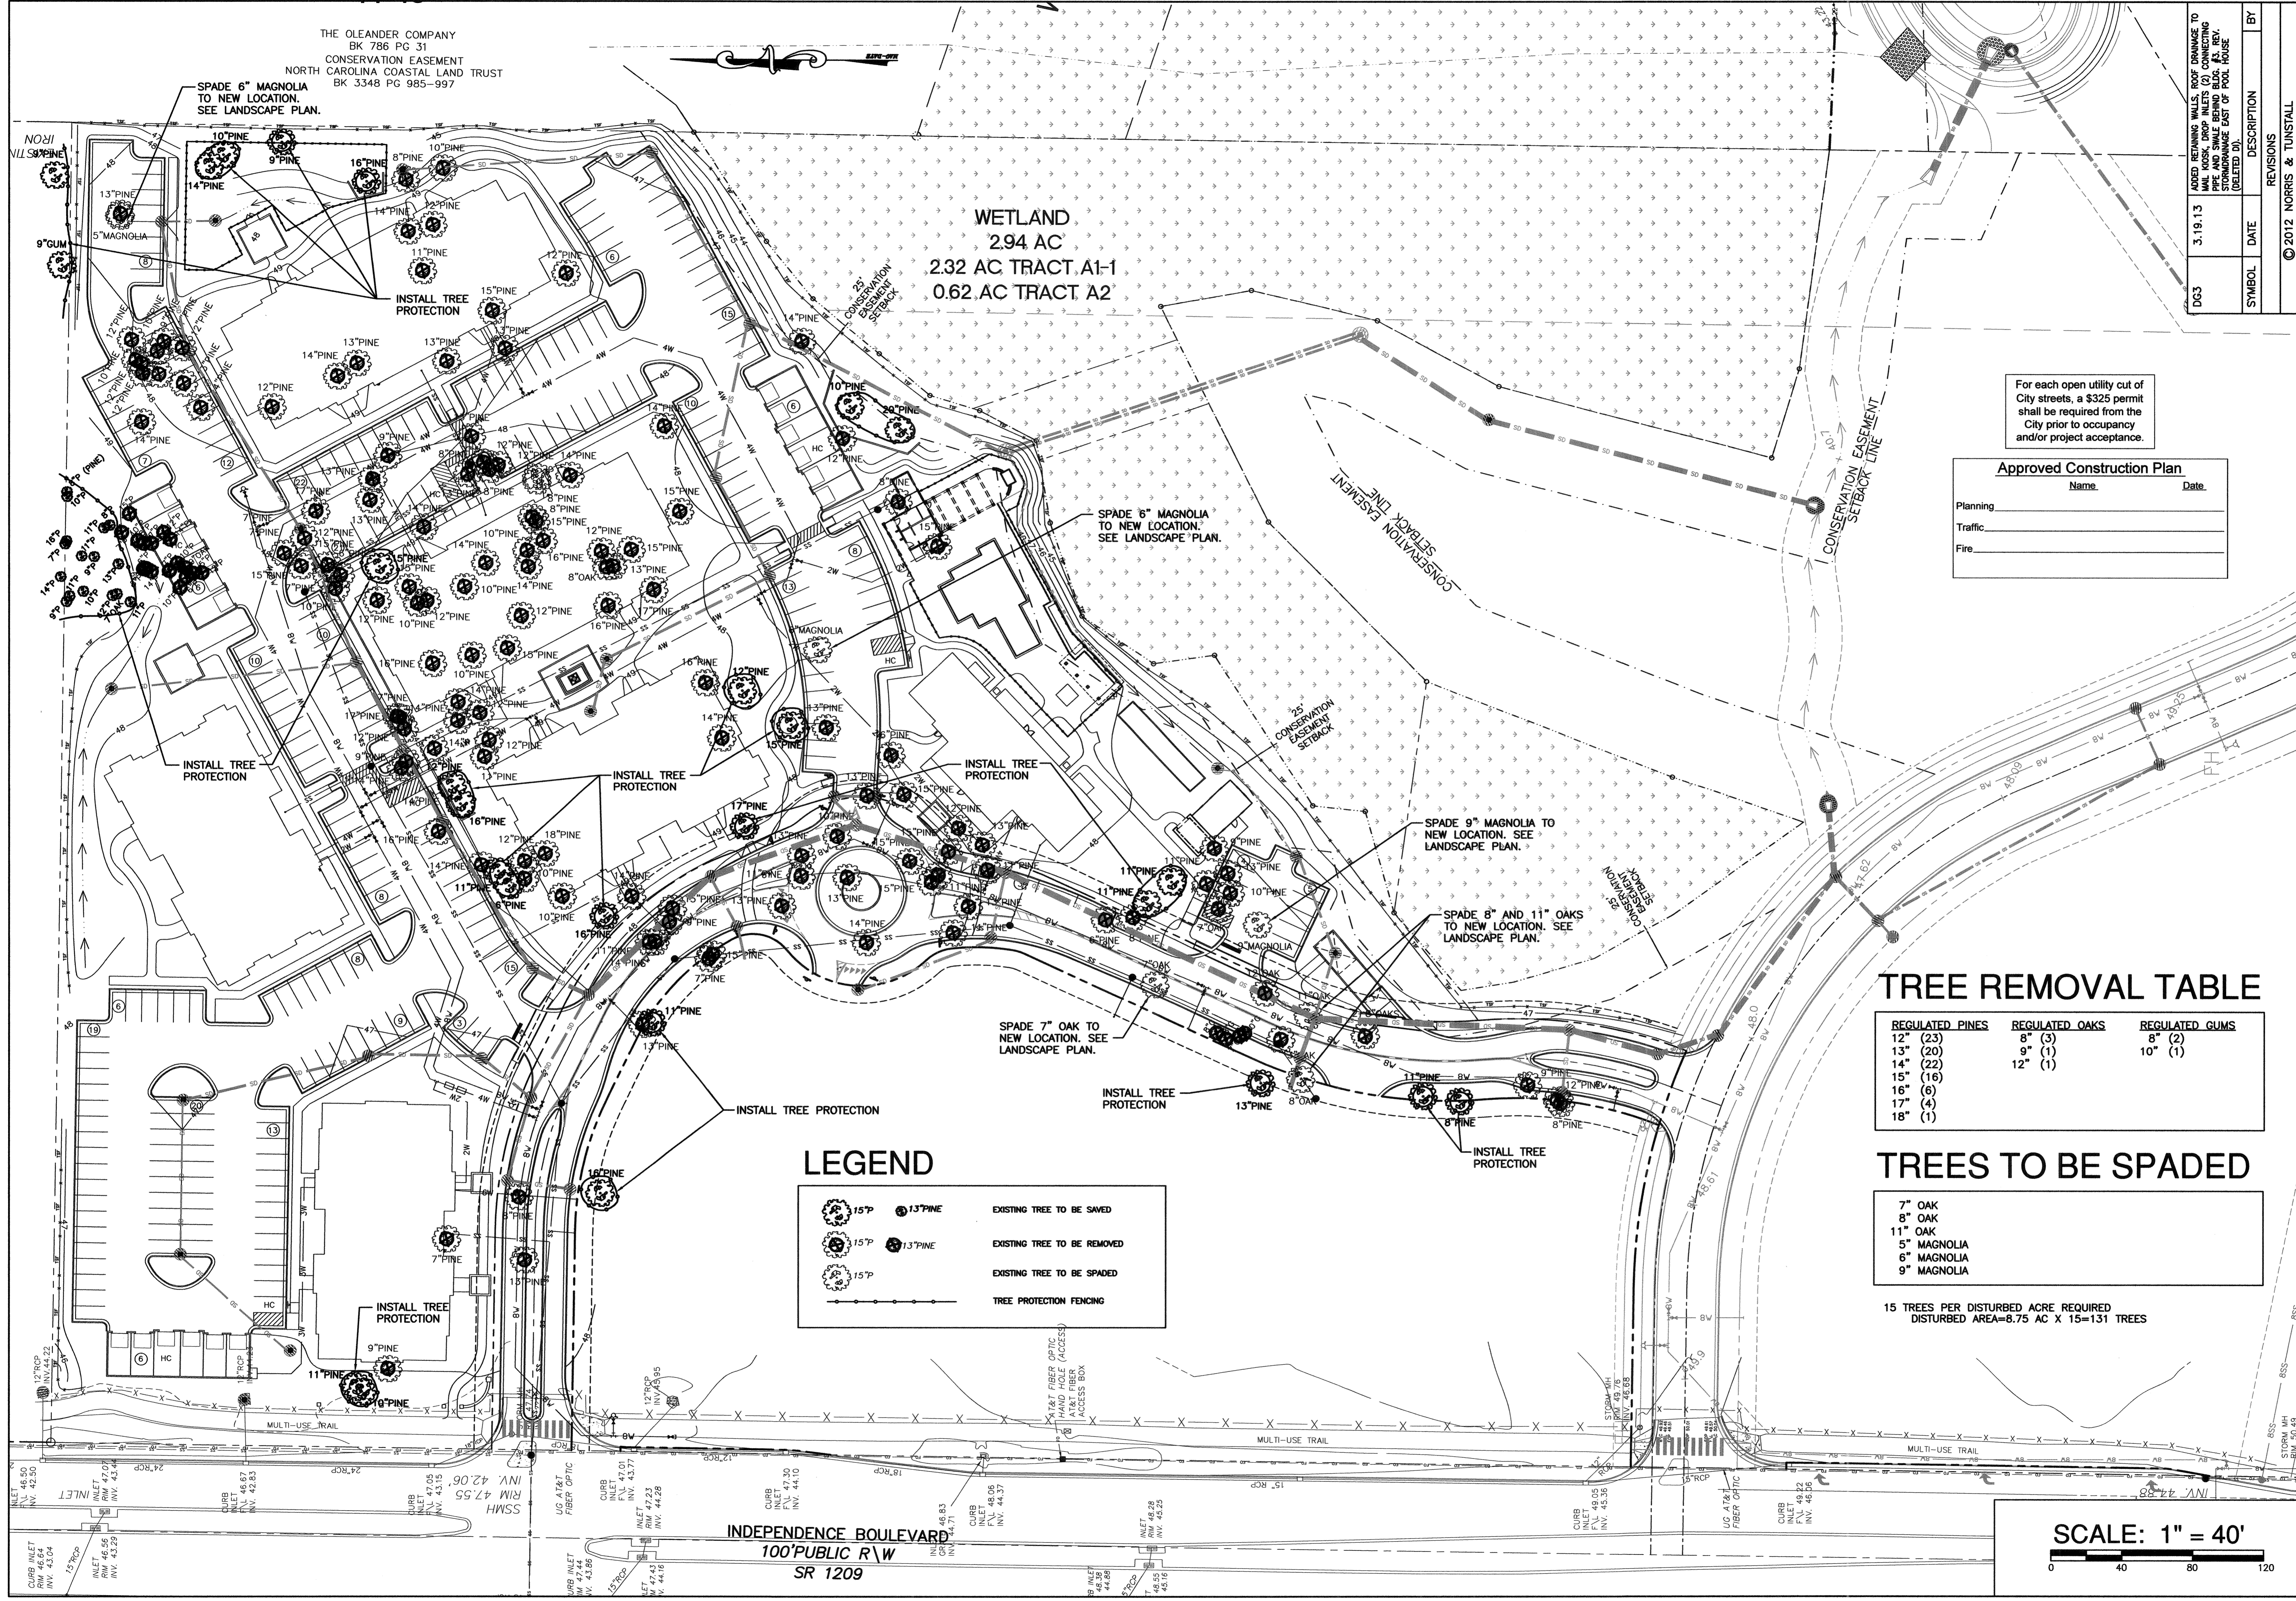

WETLAND
2.94 AC
2.32 AC TRACT A1-1
0.62 AC TRACT A2

SYMBOL	DATE	DESCRIPTION	BY
DC3	3.19.13	ADDED REMAINS W/UTILITY CUTS TO MAKE USE OF EXISTING PIPE AND SMALL BEING BLDG. FOR STORMWATER EAST OF POOL HOUSE (DELETED D)	

For each open utility cut of City streets, a \$325 permit shall be required from the City prior to occupancy and/or project acceptance.

Approved Construction Plan

Name	Date
Planning	
Traffic	
Fire	

TREE REMOVAL TABLE


REGULATED PINES	REGULATED OAKS	REGULATED GUMS
12" (23)	8" (3)	8" (2)
13" (20)	9" (1)	10" (1)
14" (22)	12" (1)	
15" (16)		
16" (6)		
17" (4)		
18" (1)		

TREES TO BE SPADED

- 7" OAK
- 8" OAK
- 11" OAK
- 5" MAGNOLIA
- 9" MAGNOLIA

15 TREES PER DISTURBED ACRE REQUIRED
DISTURBED AREA=8.75 AC X 15=131 TREES

LEGEND

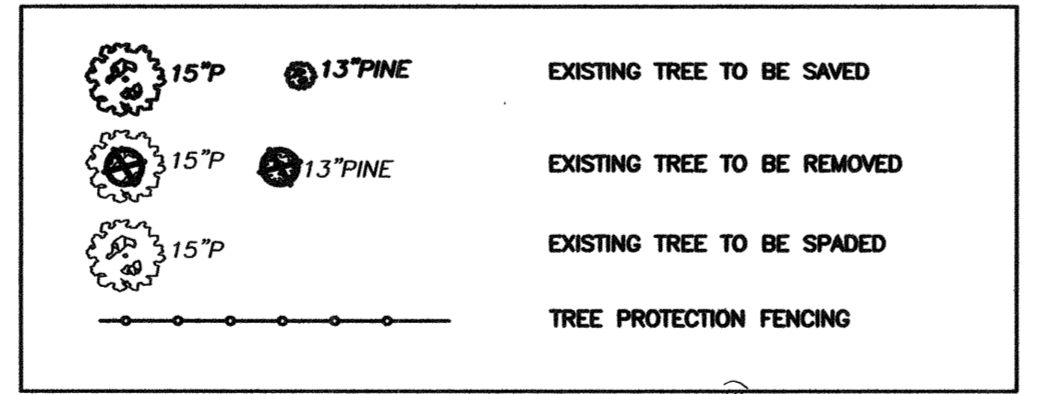


SCALE: 1" = 40'

TREE PLAN
TIBURON PARC APARTMENTS
2945 MOYNET WAY
WILMINGTON, NORTH CAROLINA










OWNER:
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CONSULTING ENGINEERS, INC.
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WILMINGTON, NC 28403
PHONE (910) 343-9853
FAX (910) 343-9804
office@nteng.com
license #C-3641

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CHK. JPN
DRWN. NKS
DATE 5/2/13

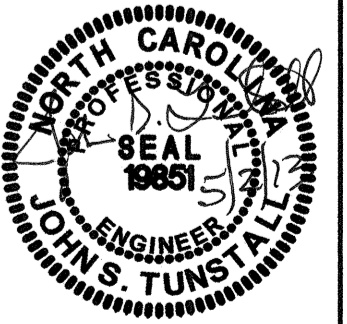

C5

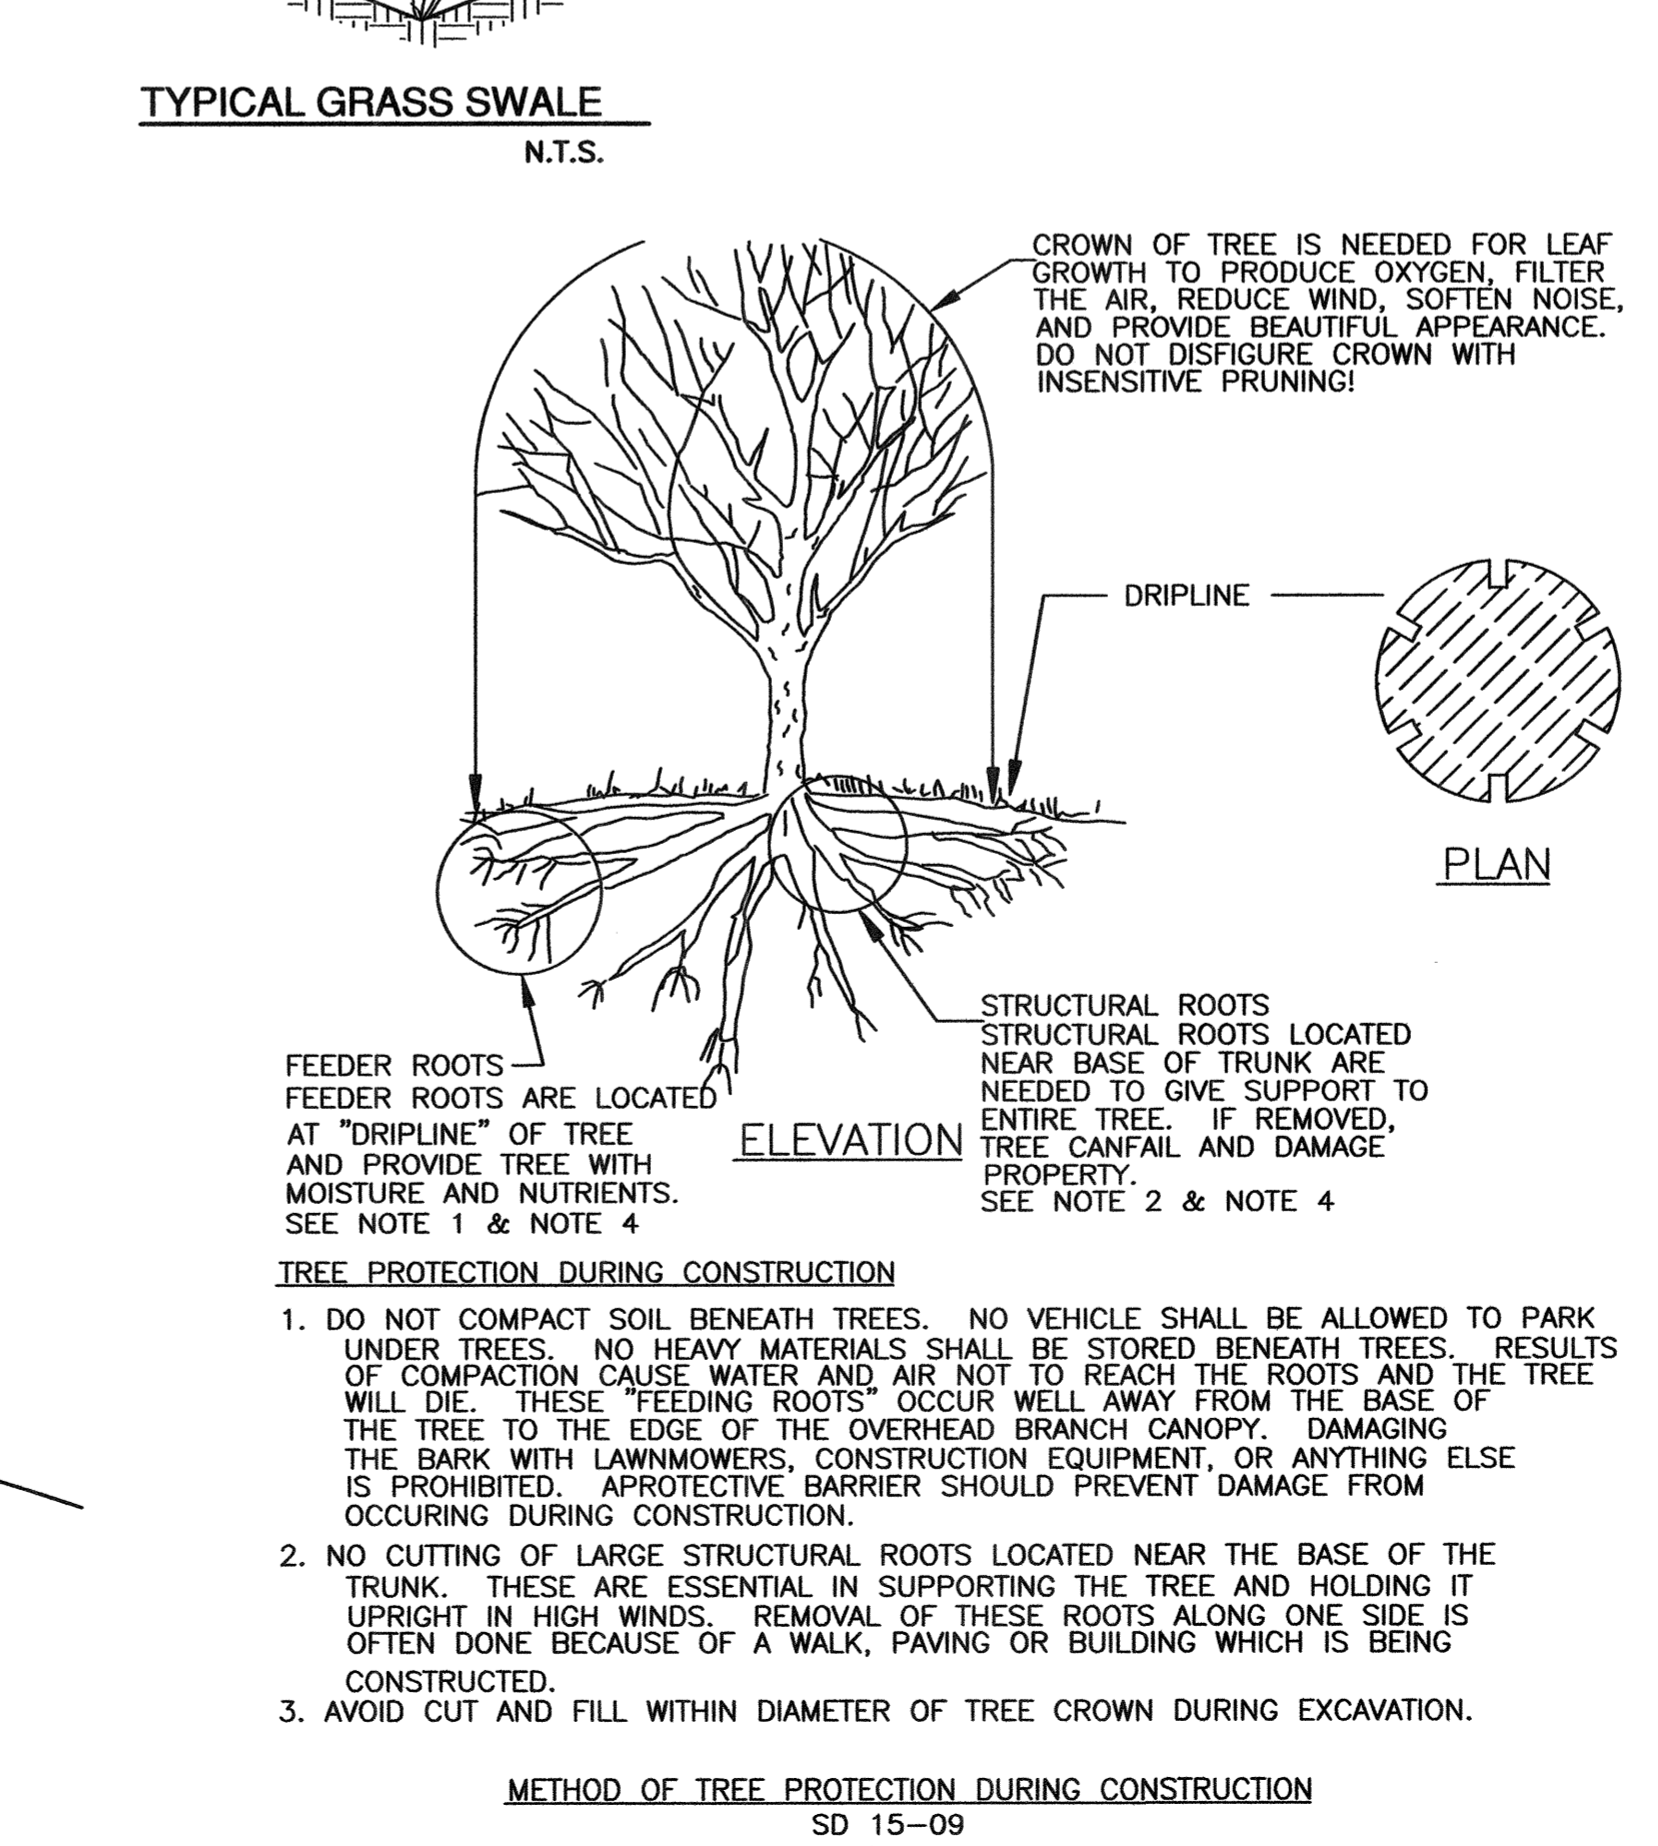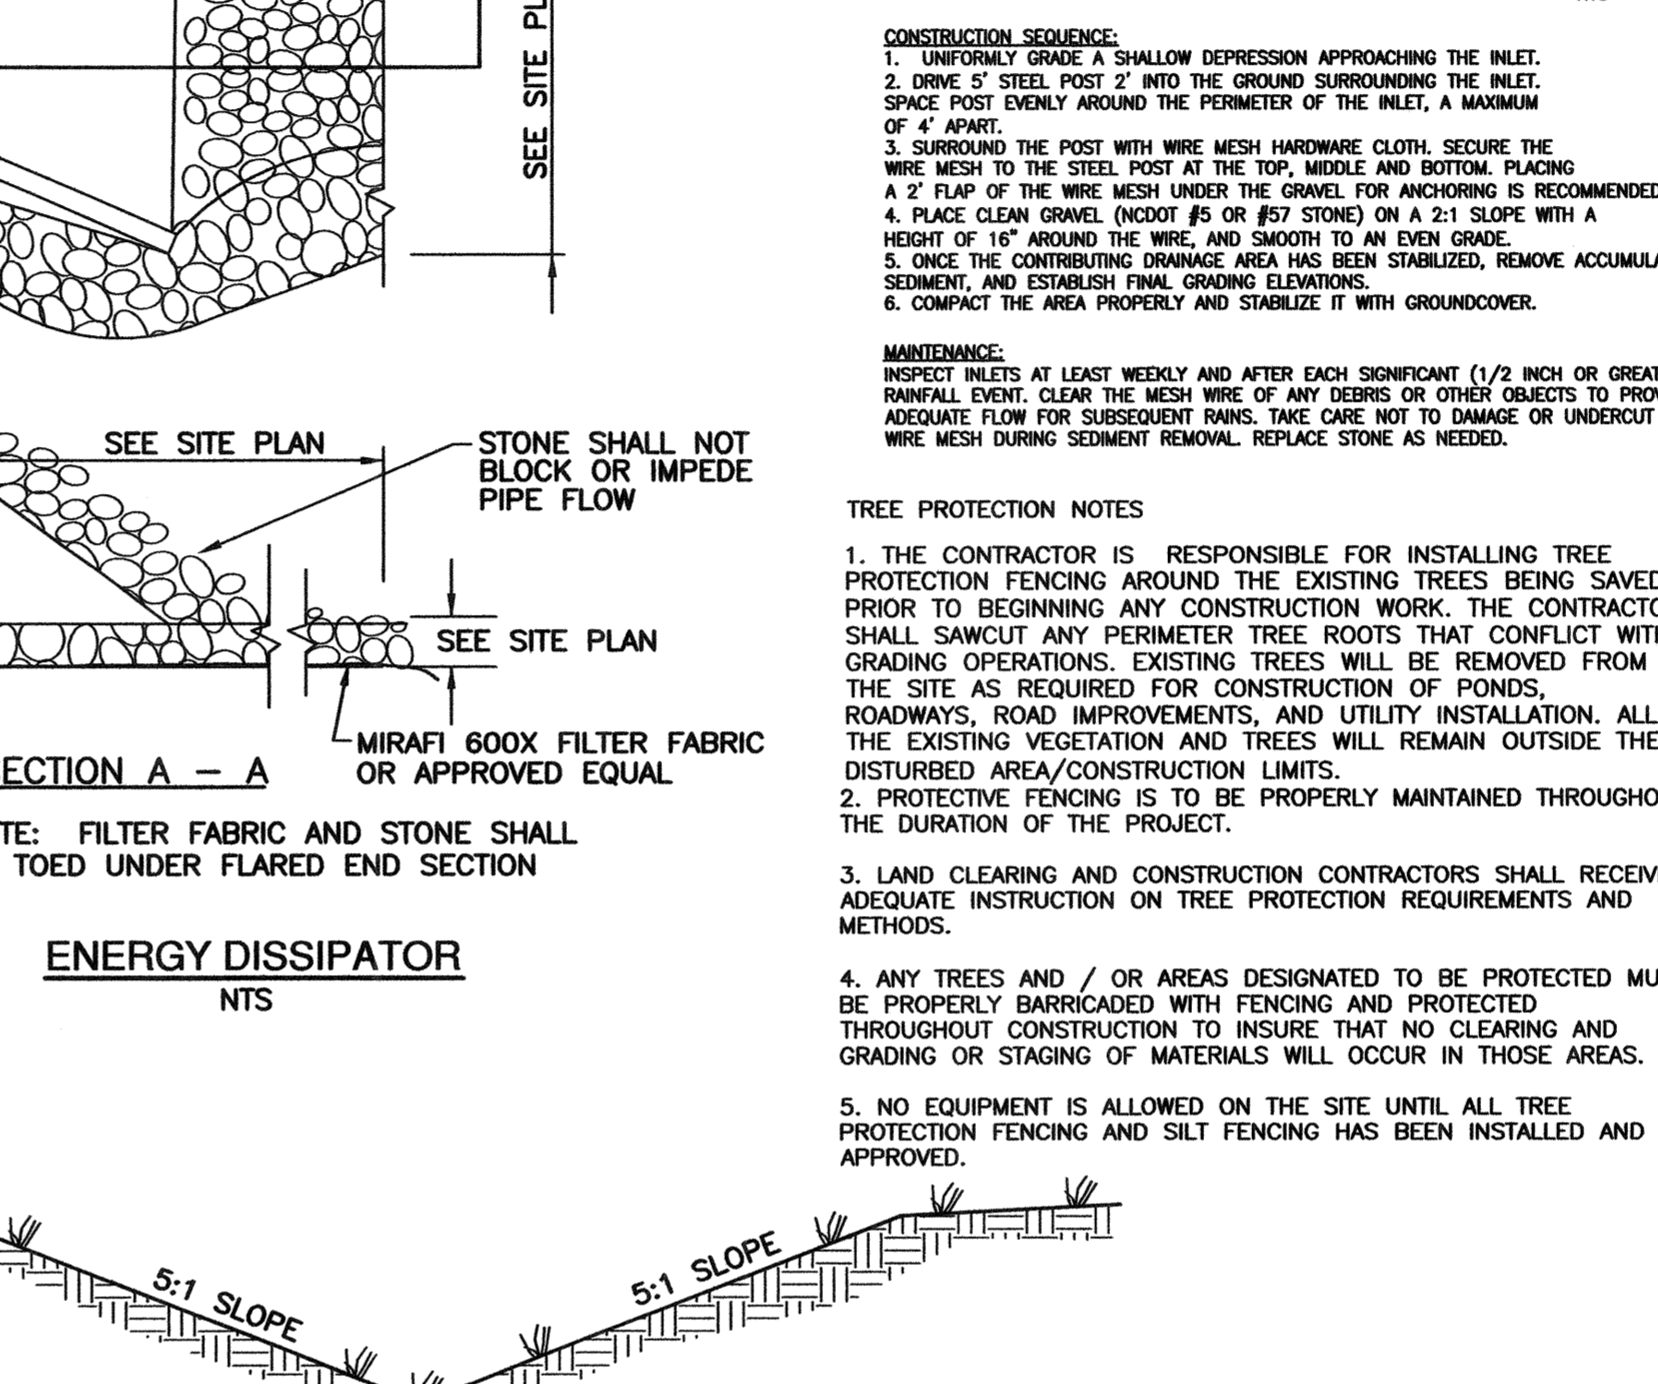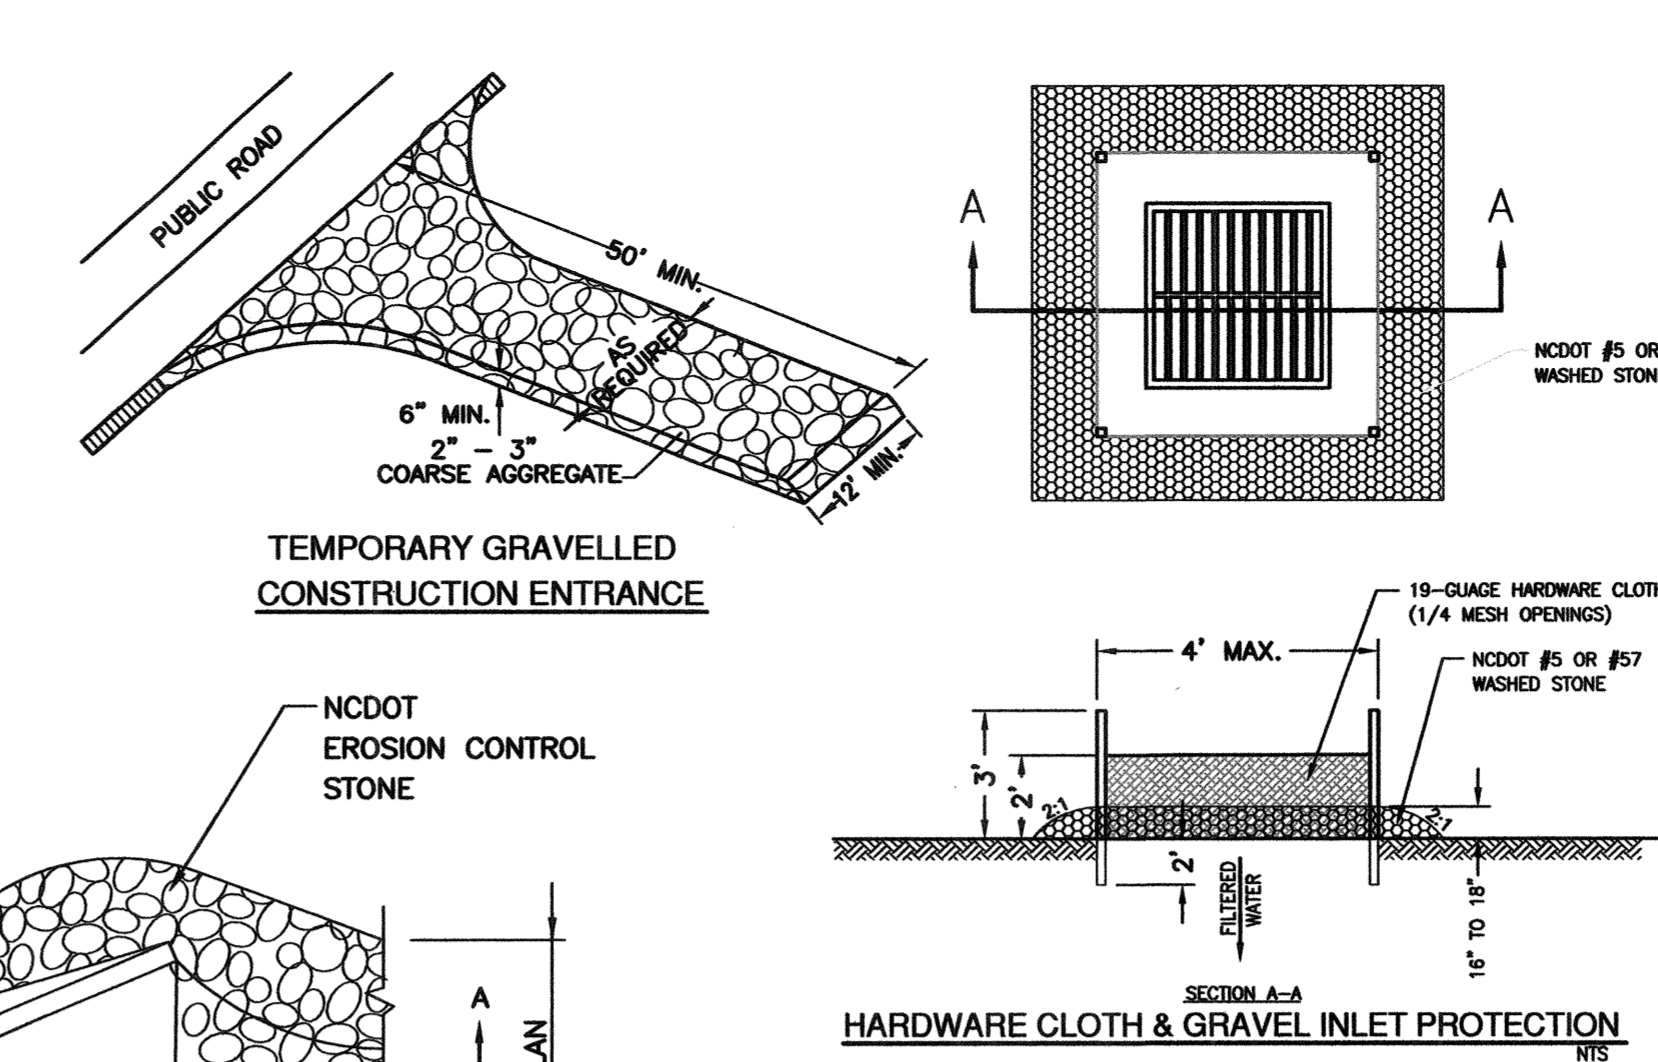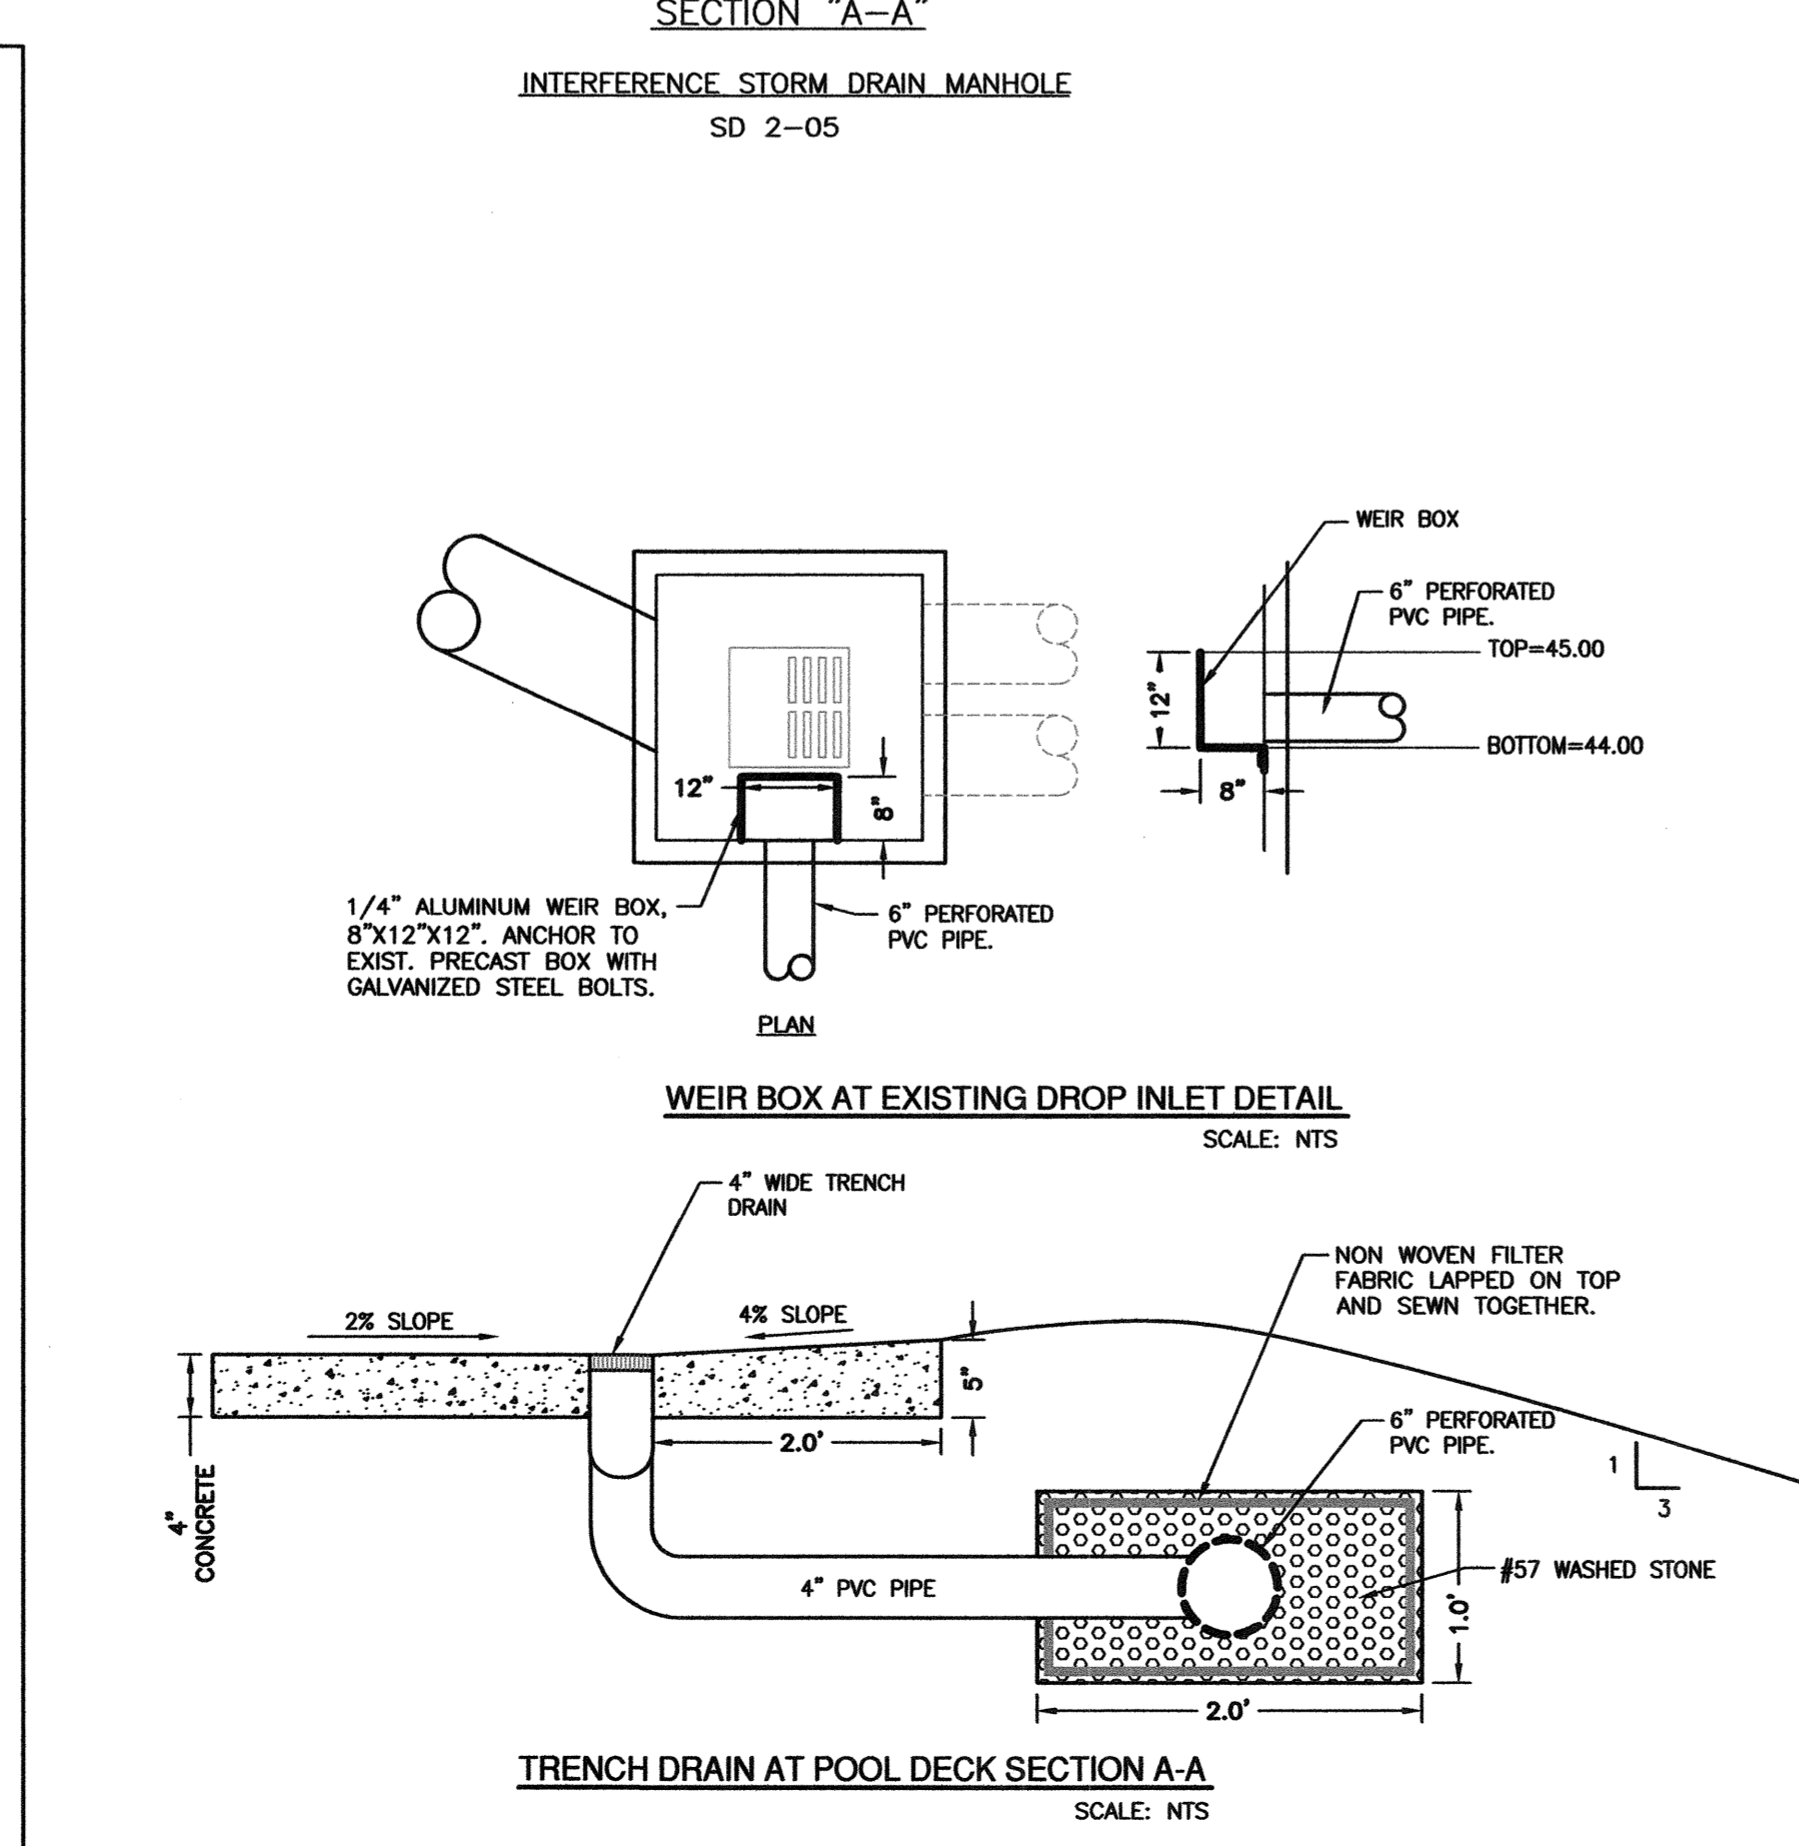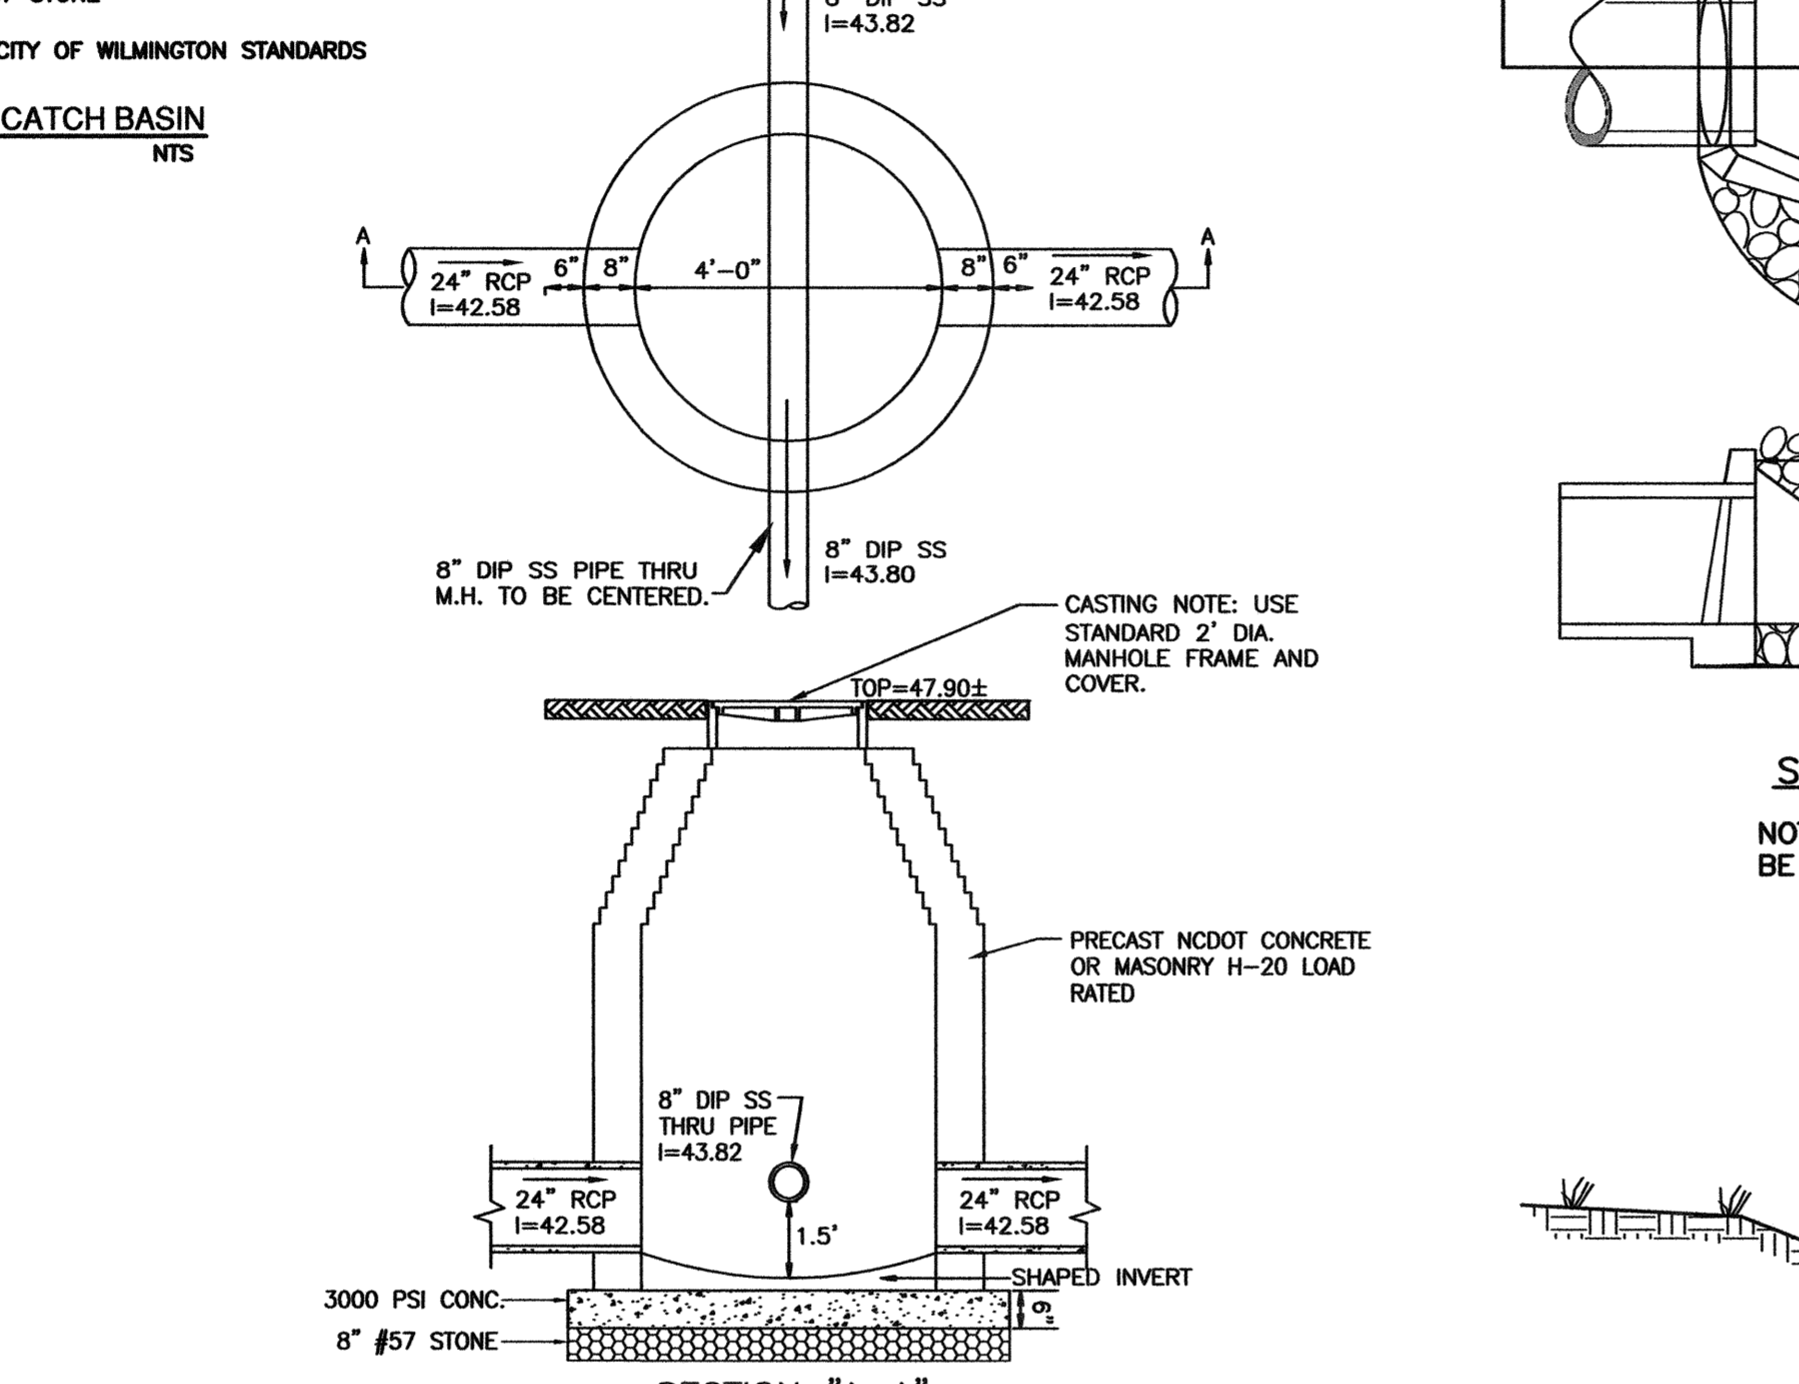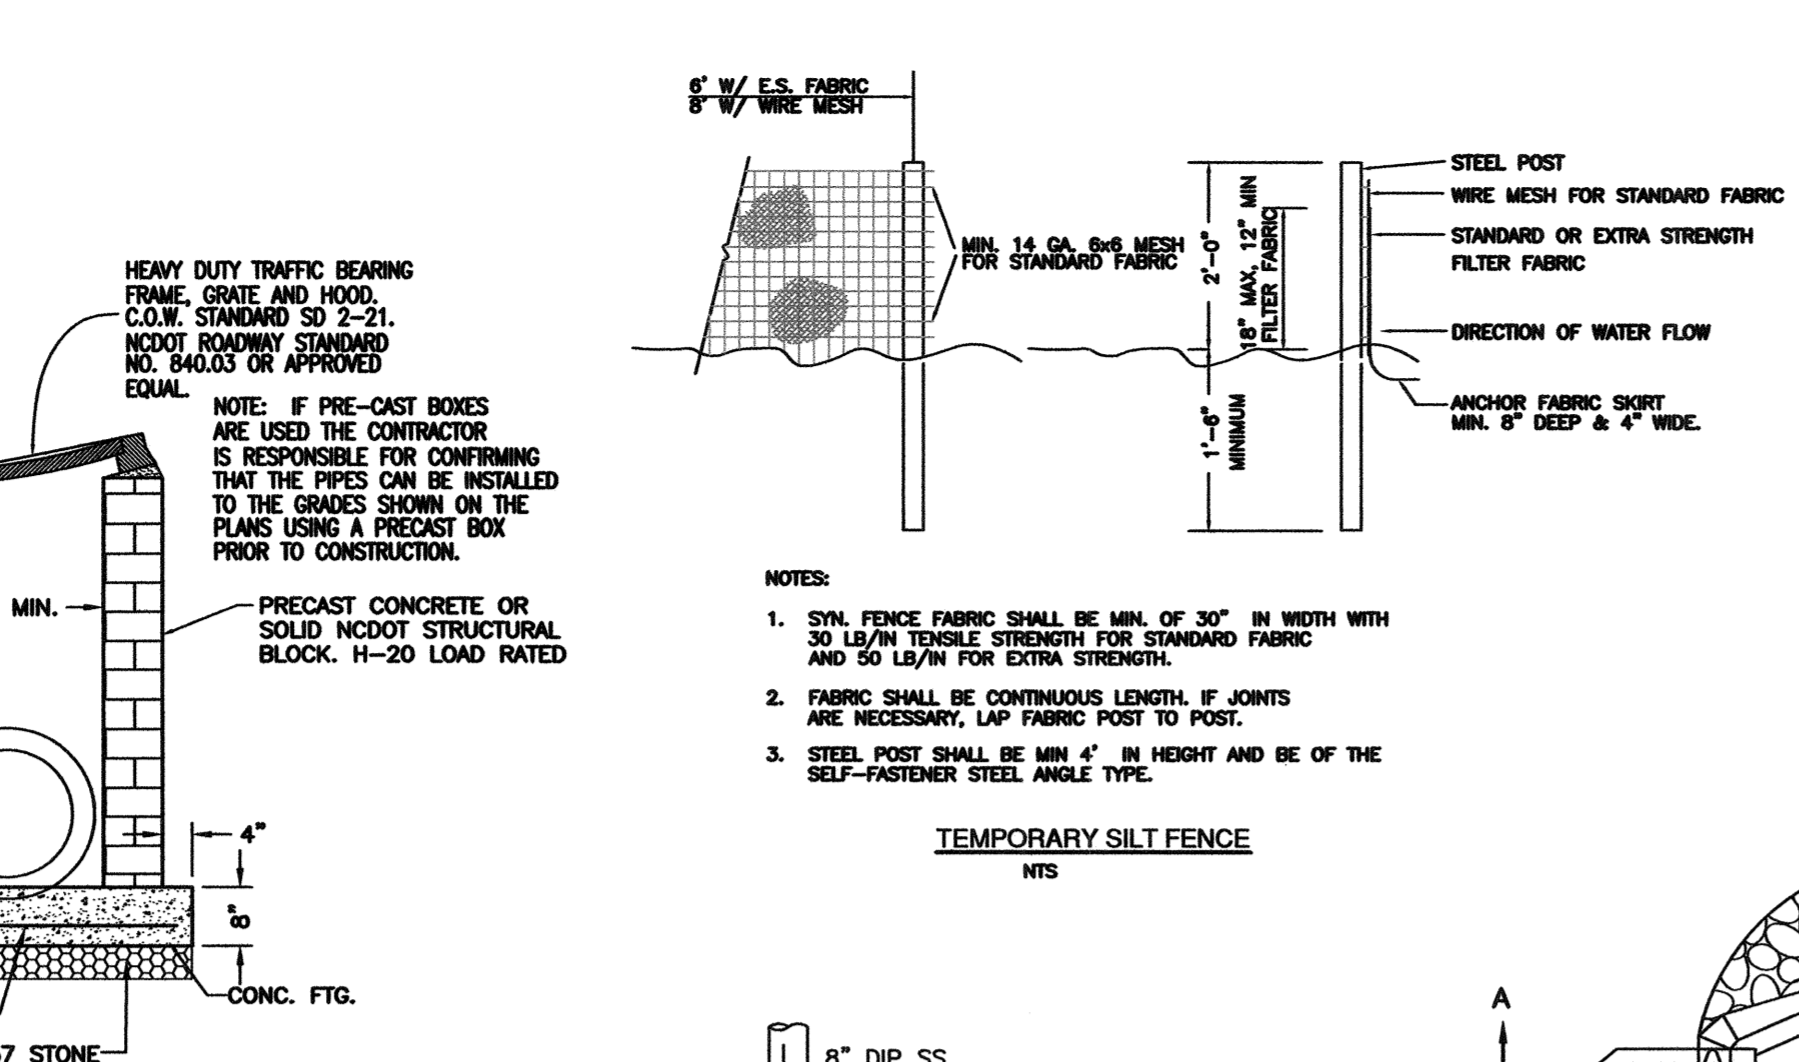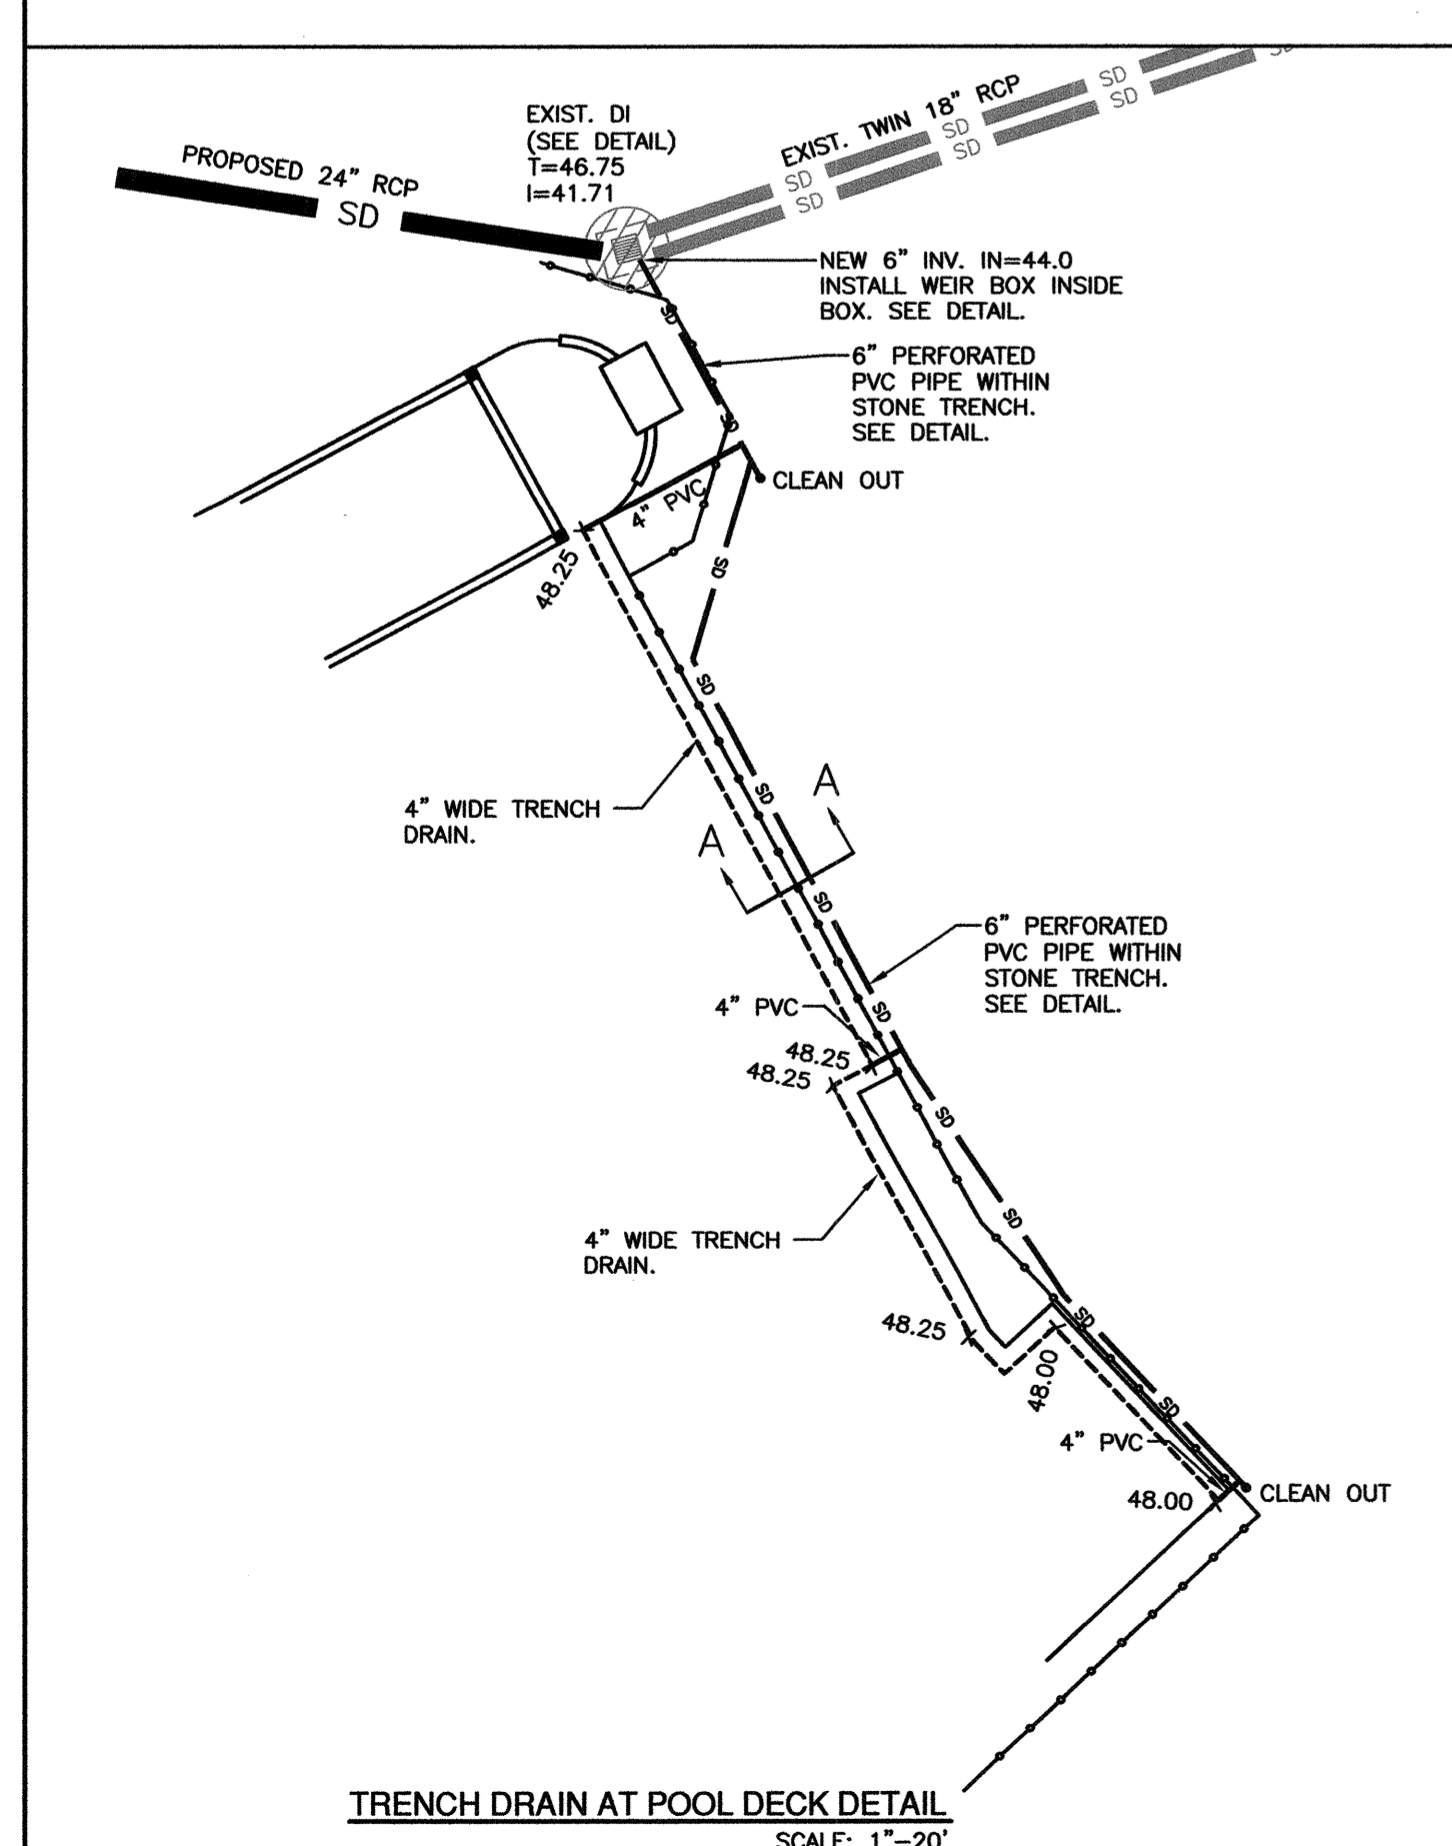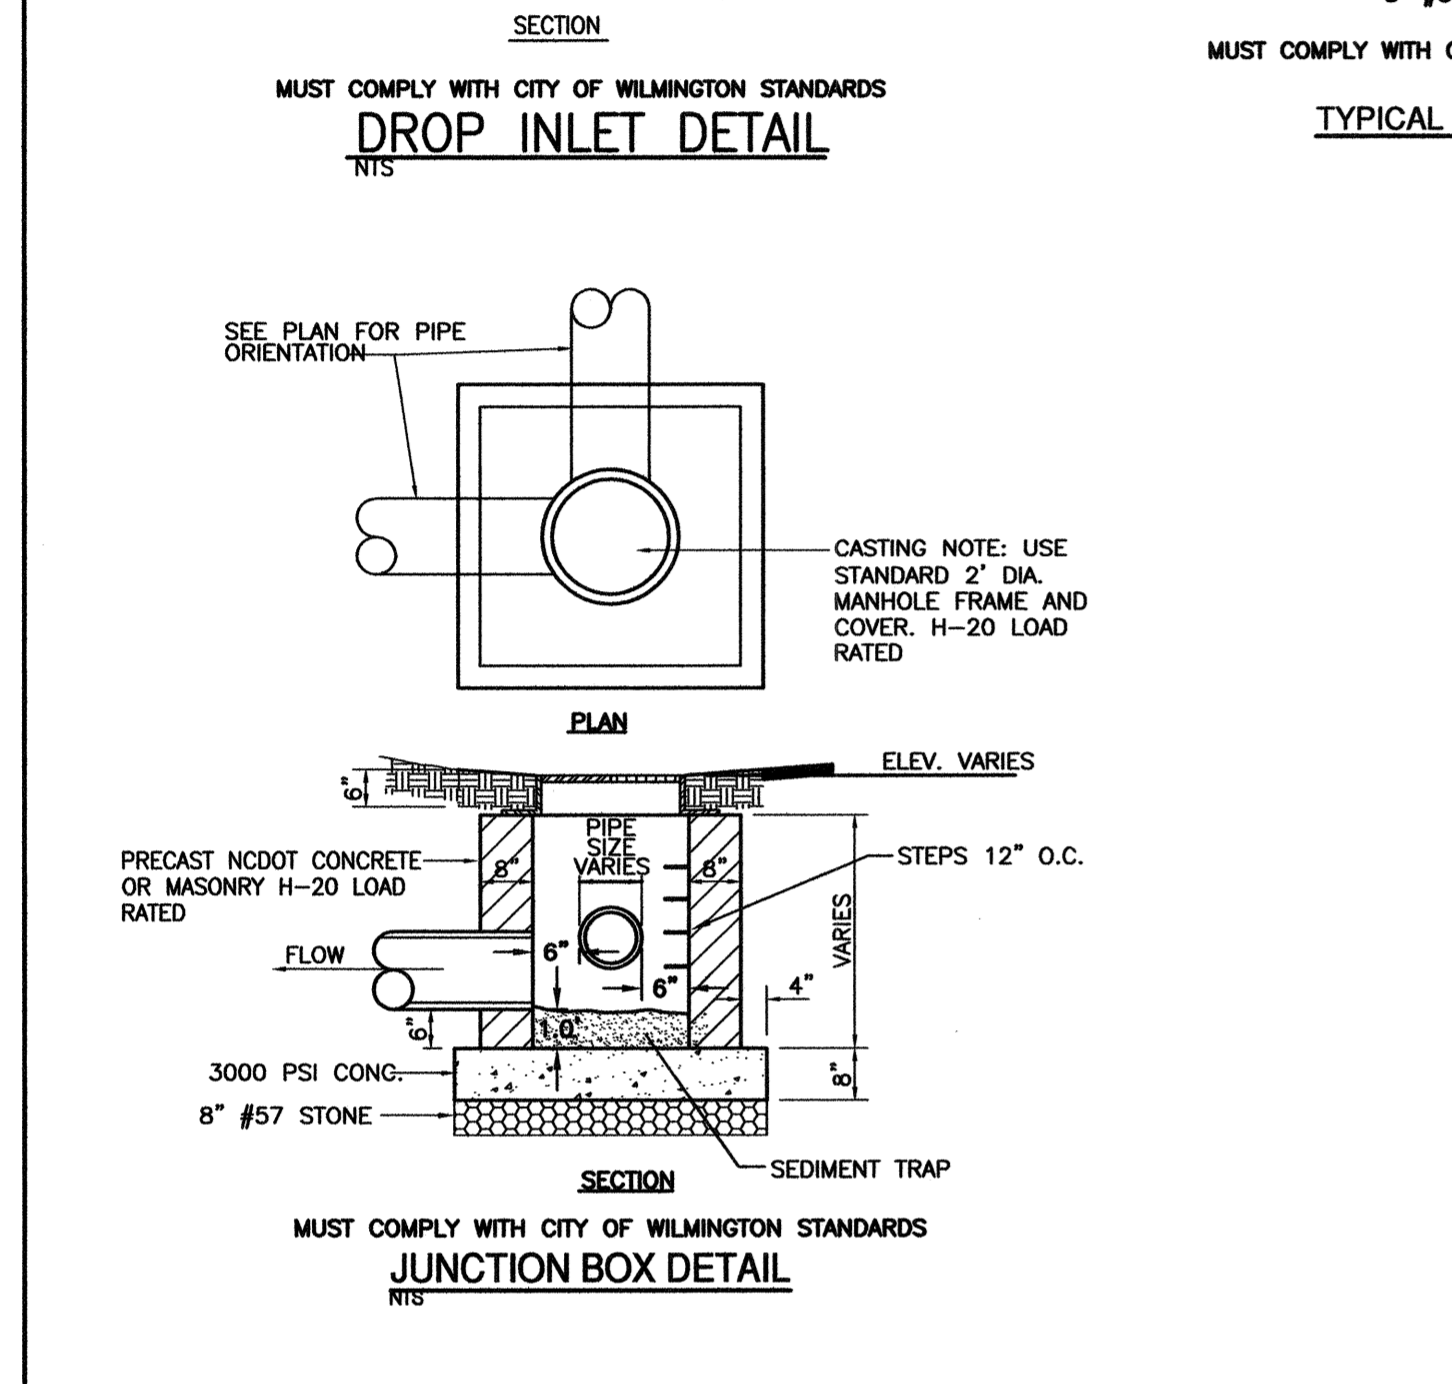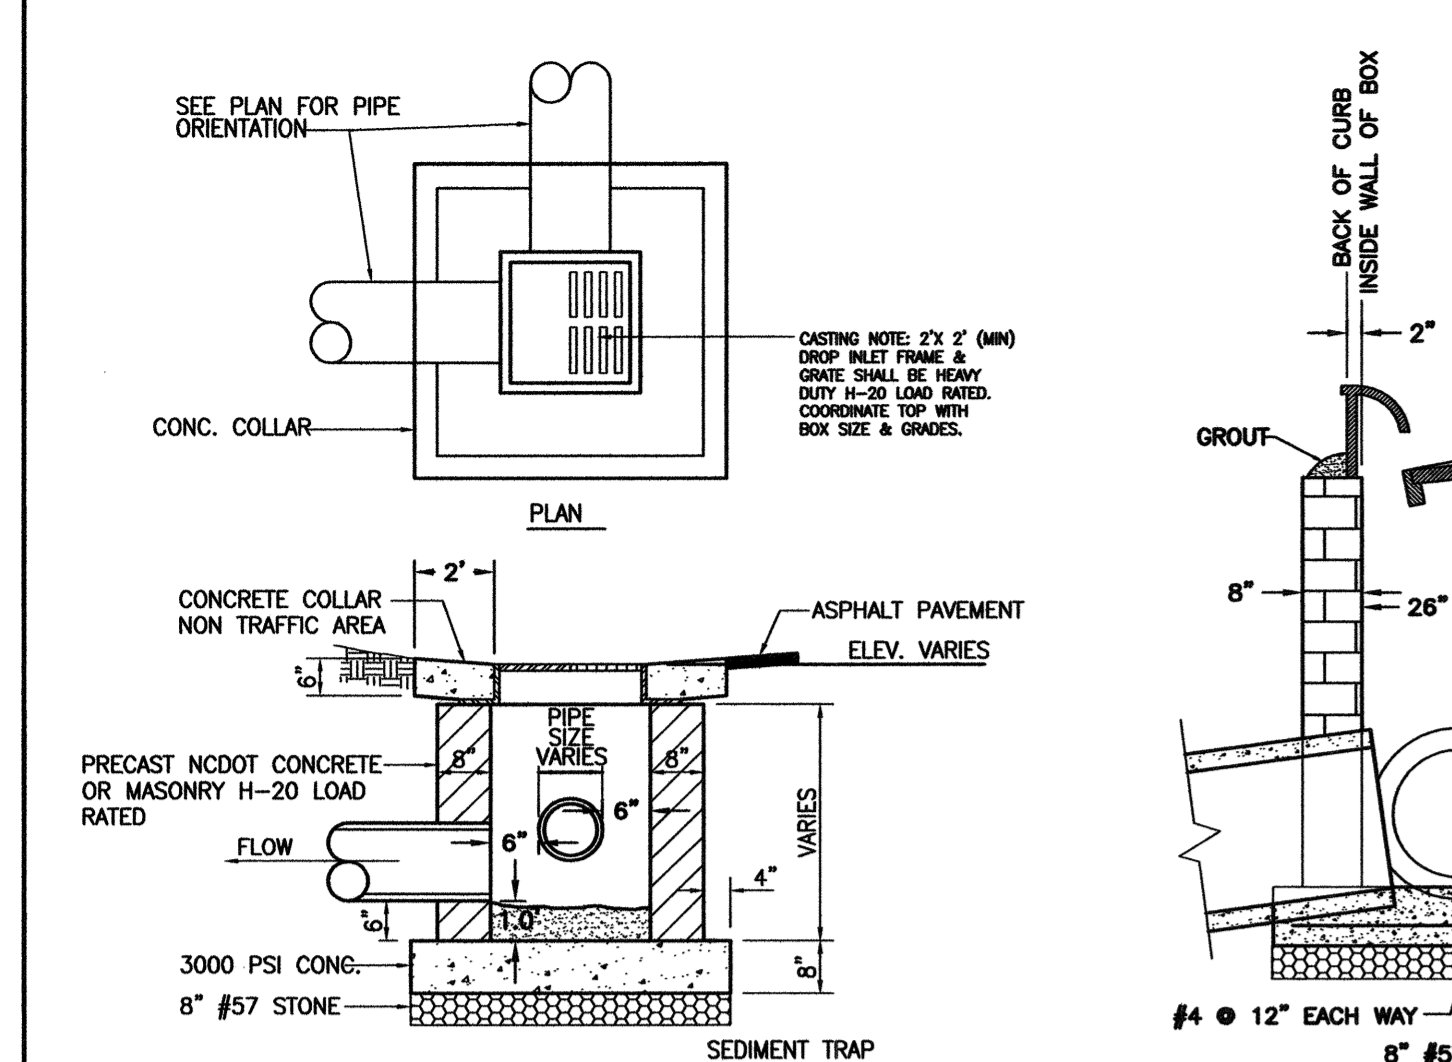

EROSION CONTROL NOTES AND MAINTENANCE PLAN

- ALL EROSION AND SEDIMENT CONTROL MEASURES WILL BE CHECKED FOR STABILITY AND OPERATION FOLLOWING EVERY RUNOFF-PRODUCING RAINFALL, BUT IN NO CASE, LESS THAN ONCE EVERY WEEK AND WITHIN 24 HOURS OF EVERY HALF-INCH RAINFALL.
- ALL POINTS OF EGRESS WILL HAVE CONSTRUCTION ENTRANCES THAT WILL BE PERIODICALLY TOP-DRESSED WITH AN ADDITIONAL 2 INCHES OF #4 STONE TO MAINTAIN PROPER DEPTH. THEY WILL BE MAINTAINED IN A CONDITION TO PREVENT MUD OR SEDIMENT FROM LEAVING THE SITE. IMMEDIATELY REMOVE OBSCURABLE MATERIAL SPILLED WASHED OR TRACKED ONTO THE CONSTRUCTION ENTRANCE OR ROADWAYS.
- SEDIMENT WILL BE REMOVED FROM HARDWARE CLOTH AND GRAVEL INLET PROTECTION, BLOCK AND GRAVEL INLET PROTECTION, ROCK DOUGHNUT INLET PROTECTION AND ROCK PIPE INLET PROTECTION WHEN THE DESIGNED STORAGE CAPACITY HAS BEEN HALF FILLED WITH SEDIMENT. ROCK WILL BE CLEANED OR REPLACED WHEN THE SEDIMENT POOL NO LONGER DRAINS AS DESIGNED. DEBRIS WILL BE REMOVED FROM THE ROCK AND HARDWARE CLOTH TO ALLOW PROPER DRAINAGE. SILT SACKS WILL BE EMPTIED ONCE A WEEK AND AFTER EVERY RAIN EVENT. SEDIMENT WILL BE REMOVED FROM AROUND BEAVER DAMS, DANDY SACKS AND SOCKS ONCE A WEEK AND AFTER EVERY RAIN EVENT.
- DIVERSION DITCHES WILL BE CLEANED OUT IMMEDIATELY TO REMOVE SEDIMENT OR OBSTRUCTIONS FROM THE FLOW AREA. THE DIVERSION RIDGES WILL ALSO BE REPAIRED. SWALES WILL BE TEMPORARILY STABILIZED WITHIN 21 CALENDAR DAYS OF CEASE OF ANY PHASE OF ACTIVITY ASSOCIATED WITH A SWALE.
- SEDIMENT WILL BE REMOVED FROM BEHIND THE SEDIMENT FENCE WHEN IT BECOMES HALF FILLED. THE SEDIMENT FENCE WILL BE REPAIRED AS NECESSARY TO MAINTAIN A BARRIER. STAKES MUST BE STEEL. STAKE SPACING WILL BE 6 FEET MAX. WITH THE USE OF EXTRA STRENGTH FABRIC, WITHOUT WIRE BACKING. STAKE SPACING WILL BE 8 FEET MAX. WHEN STANDARD STRENGTH FABRIC AND WIRE BACKING ARE USED. IF ROCK FILTERS ARE DESIGNED AT LOW POINTS IN THE SEDIMENT FENCE, THE ROCK WILL BE REPLACED IF IT BECOMES HALF-FULL OF SEDIMENT, NO LONGER DRAINS AS DESIGNED OR IS DAMAGED.
- SEDIMENT WILL BE REMOVED FROM SEDIMENT TRAPS WHEN THE DESIGN STORAGE CAPACITY HAS BEEN HALF FILLED WITH SEDIMENT. THE ROCK WILL BE CLEANED OR REPLACED WHEN THE SEDIMENT POOL NO LONGER DRAINS OR WHEN THE ROCK IS DISLODGED. BAFFLES WILL BE REPAIRED OR REPLACED IF THEY COLLAPSE, TEAR, DECOMPOSE OR BECOME INEFFECTIVE. THEY WILL BE REPLACED PROMPTLY. SEDIMENT WILL BE REMOVED WHEN DEPOSITS REACH HALF THE HEIGHT OF THE 1ST BAFFLE. FLOATING SKIMMERS WILL BE INSPECTED AND KEPT CLEAN WEEKLY.
- SEDIMENT WILL BE REMOVED FROM THE SEDIMENT BASIN WHEN THE DESIGN STORAGE CAPACITY HAS BEEN HALF FILLED WITH SEDIMENT. ROCK WILL BE CLEANED OR REPLACED WHEN THE SEDIMENT POOL NO LONGER DRAINS OR IF THE ROCK IS DISLODGED. BAFFLES WILL BE REPAIRED OR REPLACED IF THEY COLLAPSE, TEAR, DECOMPOSE OR BECOME INEFFECTIVE. THEY WILL BE REPLACED PROMPTLY. SEDIMENT WILL BE REMOVED FROM BAFFLES WHEN DEPOSITS REACH HALF THE HEIGHT OF THE 1ST BAFFLE. FLOATING SKIMMERS WILL BE INSPECTED WEEKLY AND WILL BE KEPT CLEAN.
- LAND QUALITY REQUIRES:**
ALL SEEDED AREAS WILL BE FERTILIZED, RESEED AS NECESSARY, AND MULCHED, ACCORDING TO SPECIFICATIONS IN THE VEGETATIVE PLAN, TO MAINTAIN A VIGOROUS, DENSE VEGETATIVE COVER. ALL PERIMETER DIKES, SWALES, DITCHES, PERIMETER SLOPES, ALL SLOPES STEEPER THAN 3' HORIZONTAL TO 1' VERTICAL (3:1) AND ALL HIGH QUALITY WATER (HOW) ZONES SHALL BE PROVIDED TEMPORARY OR PERMANENT STABILIZATION WITH GROUND COVER AS SOON AS PRACTICABLE BUT IN ANY EVENT WITHIN SEVEN (7) CALENDAR DAYS FROM THE LAST LAND-DISTURBING ACTIVITY. ALL OTHER DISTURBED AREAS SHALL BE PROVIDED TEMPORARY OR PERMANENT STABILIZATION WITH GROUND COVER AS SOON AS PRACTICABLE BUT IN ANY EVENT WITHIN FOURTEEN (14) CALENDAR DAYS FROM THE LAST LAND-DISTURBING ACTIVITY.
- FLOCCULANTS WILL BE USED TO ADDRESS TURBIDITY ISSUES. THE PUMPS, TANKS, HOSES AND INJECT SYSTEMS WILL BE CHECKED FOR PROBLEMS OR TURBID DISCHARGES DAILY.
- BASIN OUTLET STRUCTURES AND SKIMMERS SHALL WITHDRAW WATER FROM THE SURFACE.

CONSTRUCTION SEQUENCE:

- UNIFORMLY GRADE A SHALLOW DEPRESSION APPROACHING THE INLET.
- DRIVE 5" STEEL POST 2" INTO THE GROUND SURROUNDING THE INLET. SPACE POSTS EVENLY AROUND THE PERIMETER OF THE INLET, A MAXIMUM OF 4' APART.
- SURROUND THE POST WITH WIRE MESH HARDWARE CLOTH. SECURE THE WIRE MESH TO THE STEEL POST AT THE TOP, MIDDLE AND BOTTOM, PLACING A 2" FLAP OF THE WIRE MESH UNDER THE GRAVEL FOR ANCHORING IS RECOMMENDED.
- PLACE CLEAN GRAVEL (NCDOT #5 OR #57 STONE) ON A 2:1 SLOPE WITH A HEIGHT OF 18" AROUND THE WIRE, AND SMOOTH TO AN EVEN GRADE.
- ONCE THE CONTRIBUTING DRAINAGE AREA HAS BEEN STABILIZED, REMOVE ACCUMULATED SEDIMENT, AND ESTABLISH FINAL GRADING ELEVATIONS.
- COMPACT THE AREA PROPERLY AND STABILIZE IT WITH GROUND COVER.

MAINTENANCE:

INSPECT INLETS AT LEAST WEEKLY AND AFTER EACH SIGNIFICANT (1/2 INCH OR GREATER) RAINFALL EVENT. CLEAR THE MESH WIRE OF ANY DEBRIS OR OTHER OBJECTS TO PROMOTE ACCURATE FLOW FOR SUBSEQUENT RAINS. TAKE CARE NOT TO DAMAGE OR UNDERCUT THE WIRE MESH DURING SEDIMENT REMOVAL. REPLACE STONE AS NEEDED.

TREE PROTECTION NOTES

- THE CONTRACTOR IS RESPONSIBLE FOR INSTALLING TREE PROTECTION FENCING AROUND THE EXISTING TREES BEING SAVED PRIOR TO BEGINNING ANY CONSTRUCTION WORK. THE CONTRACTOR SHALL SAWCUT ANY PERIMETER TREE ROOTS THAT CONFLICT WITH GRADING OPERATIONS. EXISTING TREES WILL BE REMOVED FROM THE SITE AS REQUIRED FOR CONSTRUCTION OF PONDS, ROADWAYS, ROAD IMPROVEMENTS, AND UTILITY INSTALLATION. ALL THE EXISTING VEGETATION AND TREES WILL REMAIN OUTSIDE THE DISTURBED AREA/CONSTRUCTION LIMITS.
- PROTECTIVE FENCING IS TO BE PROPERLY MAINTAINED THROUGHOUT THE DURATION OF THE PROJECT.
- LAND CLEARING AND CONSTRUCTION CONTRACTORS SHALL RECEIVE ADEQUATE INSTRUCTION ON TREE PROTECTION REQUIREMENTS AND METHODS.
- ANY TREES AND / OR AREAS DESIGNATED TO BE PROTECTED MUST BE PROPERLY BARRICADED WITH FENCING AND PROTECTED THROUGHOUT CONSTRUCTION TO INSURE THAT NO CLEARING AND GRADING OR STAGING OF MATERIALS WILL OCCUR IN THOSE AREAS.
- NO EQUIPMENT IS ALLOWED ON THE SITE UNTIL ALL TREE PROTECTION FENCING AND SILT FENCING HAS BEEN INSTALLED AND APPROVED.

CROWN OF TREE IS NEEDED FOR LEAF GROWTH TO PRODUCE OXYGEN, FILTER THE AIR, REDUCE WIND, SOFTEN NOISE, AND PROVIDE BEAUTIFUL APPEARANCE. DO NOT DISFIGURE CROWN WITH INSENSITIVE PRUNING!

STRUCTURAL ROOTS LOCATED NEAR BASE OF TRUNK ARE NEEDED TO GIVE SUPPORT TO ENTIRE TREE. IF REMOVED, TREE CAN FAIL AND DAMAGE PROPERTY. SEE NOTE 2 & NOTE 4

FEEDER ROOTS ARE LOCATED AT "DRIPLINE" OF TREE AND PROVIDE TREE WITH MOISTURE AND NUTRIENTS. SEE NOTE 1 & NOTE 4

UNDER TREES, NO HEAVY MATERIALS SHALL BE STORED BENEATH TREES. RESULTS OF COMPACTION CAUSE WATER AND AIR NOT TO REACH THE ROOTS AND THE TREE WILL DIE. THESE "FEEDING ROOTS" OCCUR WELL AWAY FROM THE BASE OF THE TREE TO THE EDGE OF THE OVERHEAD BRANCH CANOPY. DAMAGING THE BARK WITH LAWNMOWERS, CONSTRUCTION EQUIPMENT, OR ANYTHING ELSE IS PROHIBITED. A PROTECTIVE BARRIER SHOULD PREVENT DAMAGE FROM OCCURRING DURING CONSTRUCTION.

NO CUTTING OF LARGE STRUCTURAL ROOTS LOCATED NEAR THE BASE OF THE TRUNK. THESE ARE ESSENTIAL IN SUPPORTING THE TREE AND HOLDING IT UPRIGHT IN HIGH WINDS. REMOVAL OF THESE ROOTS ALONG ONE SIDE IS OFTEN DONE BECAUSE OF A WALK, PAVING OR BUILDING WHICH IS BEING CONSTRUCTED.

AVOID CUT AND FILL WITHIN DIAMETER OF TREE CROWN DURING EXCAVATION.

METHOD OF TREE PROTECTION
NTS

Existing Tree
Dripline
3' Minimum Stake Height Above Grade
Protective Barrier

METHOD OF TREE PROTECTION DURING CONSTRUCTION
SD 15-09
nts

Clearly mark the trees to be saved prior to construction and erect a protective barrier at the dripline.

Dripline-The area of soil directly beneath the tree extending out to the tips of the outermost branches.

BY	
REVISIONS	
DESCRIPTION	
DATE	
SYMBOL	

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NOTES AND DETAILS
TIBURON PARC APARTMENTS
2945 MOYNET WAY
WILMINGTON, NORTH CAROLINA

OWNER:
NELSON MACRAE
MIDTOWN ONE LLC
P.O. BOX 3145
WILMINGTON, N.C. 28406
910-392-3300

NORRIS & TUNSTALL
CONSULTING ENGINEERS, INC.
1127 FLORAL PARKWAY
SUITE 400
WILMINGTON, NC, 28403
PHONE (910) 343-8653
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office@ntsteng.com
license #C-3641

HUD/PERMIT SET
12073
DES. JST
CKD. JPN
DRWL. NKS
DATE 5/2/13


APPROVED STORMWATER MANAGEMENT PLAN
Date: _____ Permit # _____
Signed: _____

Approved Construction Plan


Planning	Name	Date
Traffic		
Fire		

WILMINGTON NORTH CAROLINA
SEAL
1985
NORRIS & TUNSTALL
REGISTERED PROFESSIONAL ENGINEERS

C7

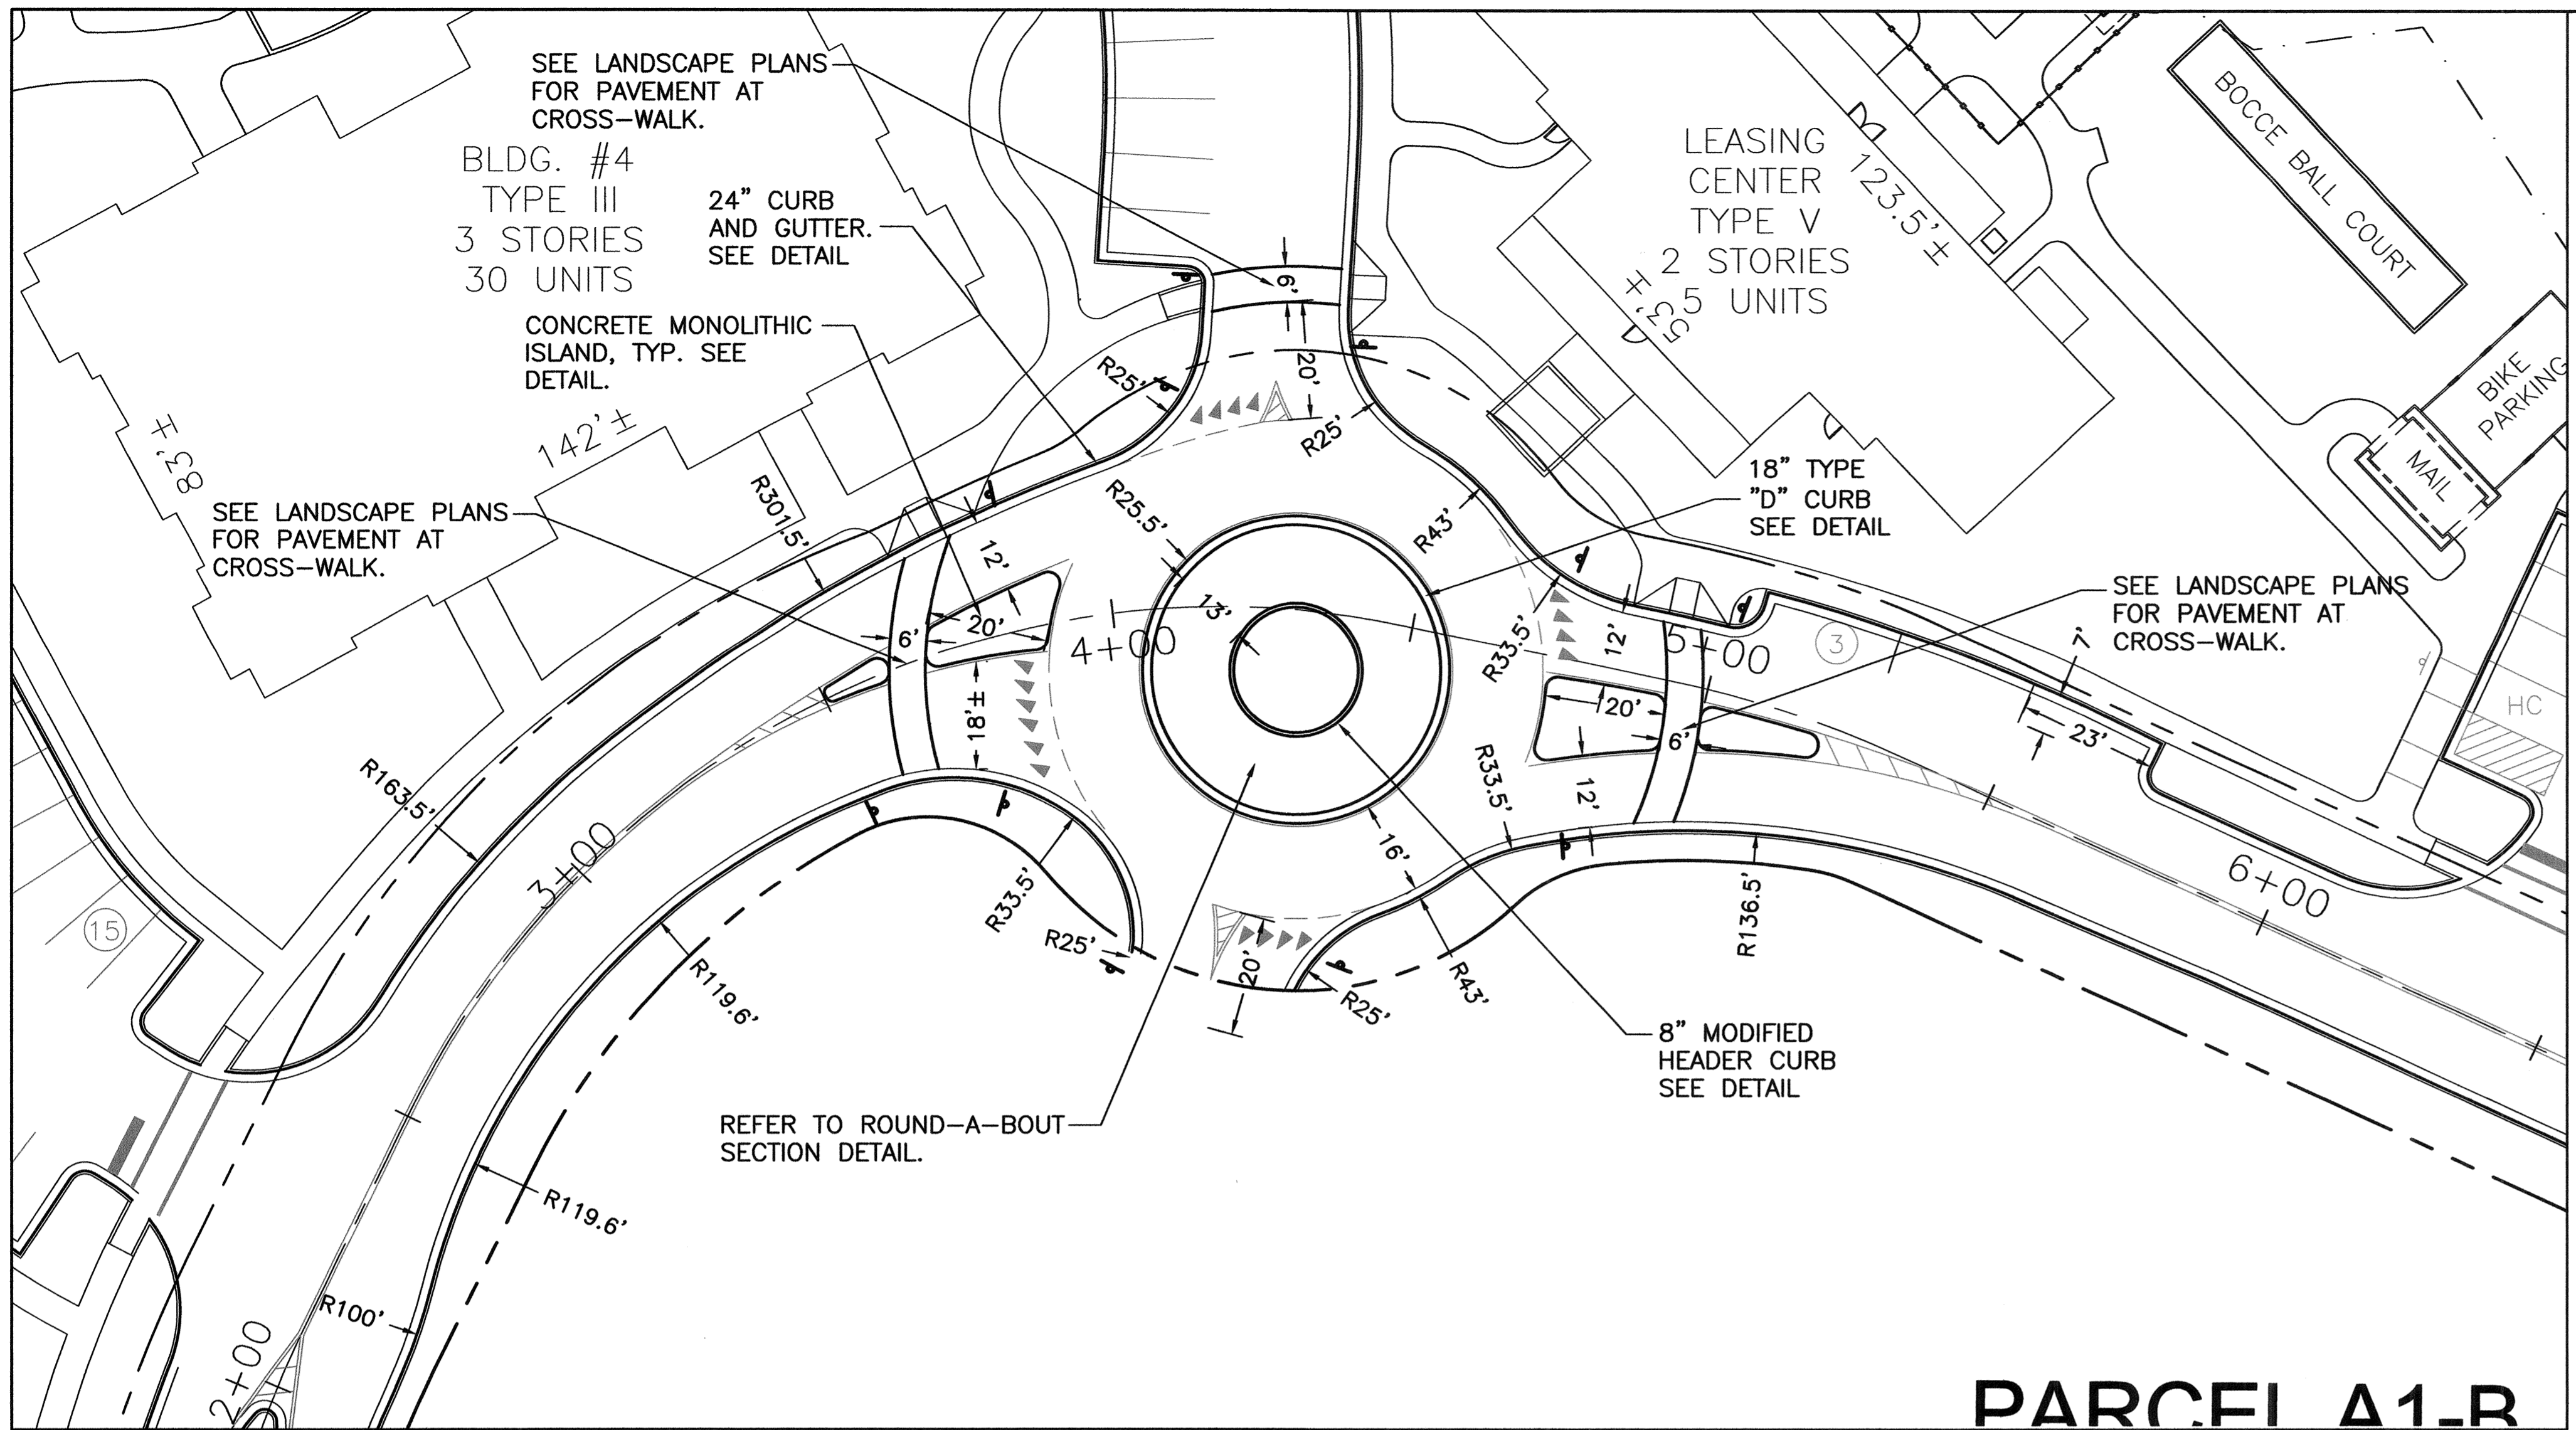

ROUND-A-BOUT LAYOUT DETAIL PLAN
SCALE: 1"=20'

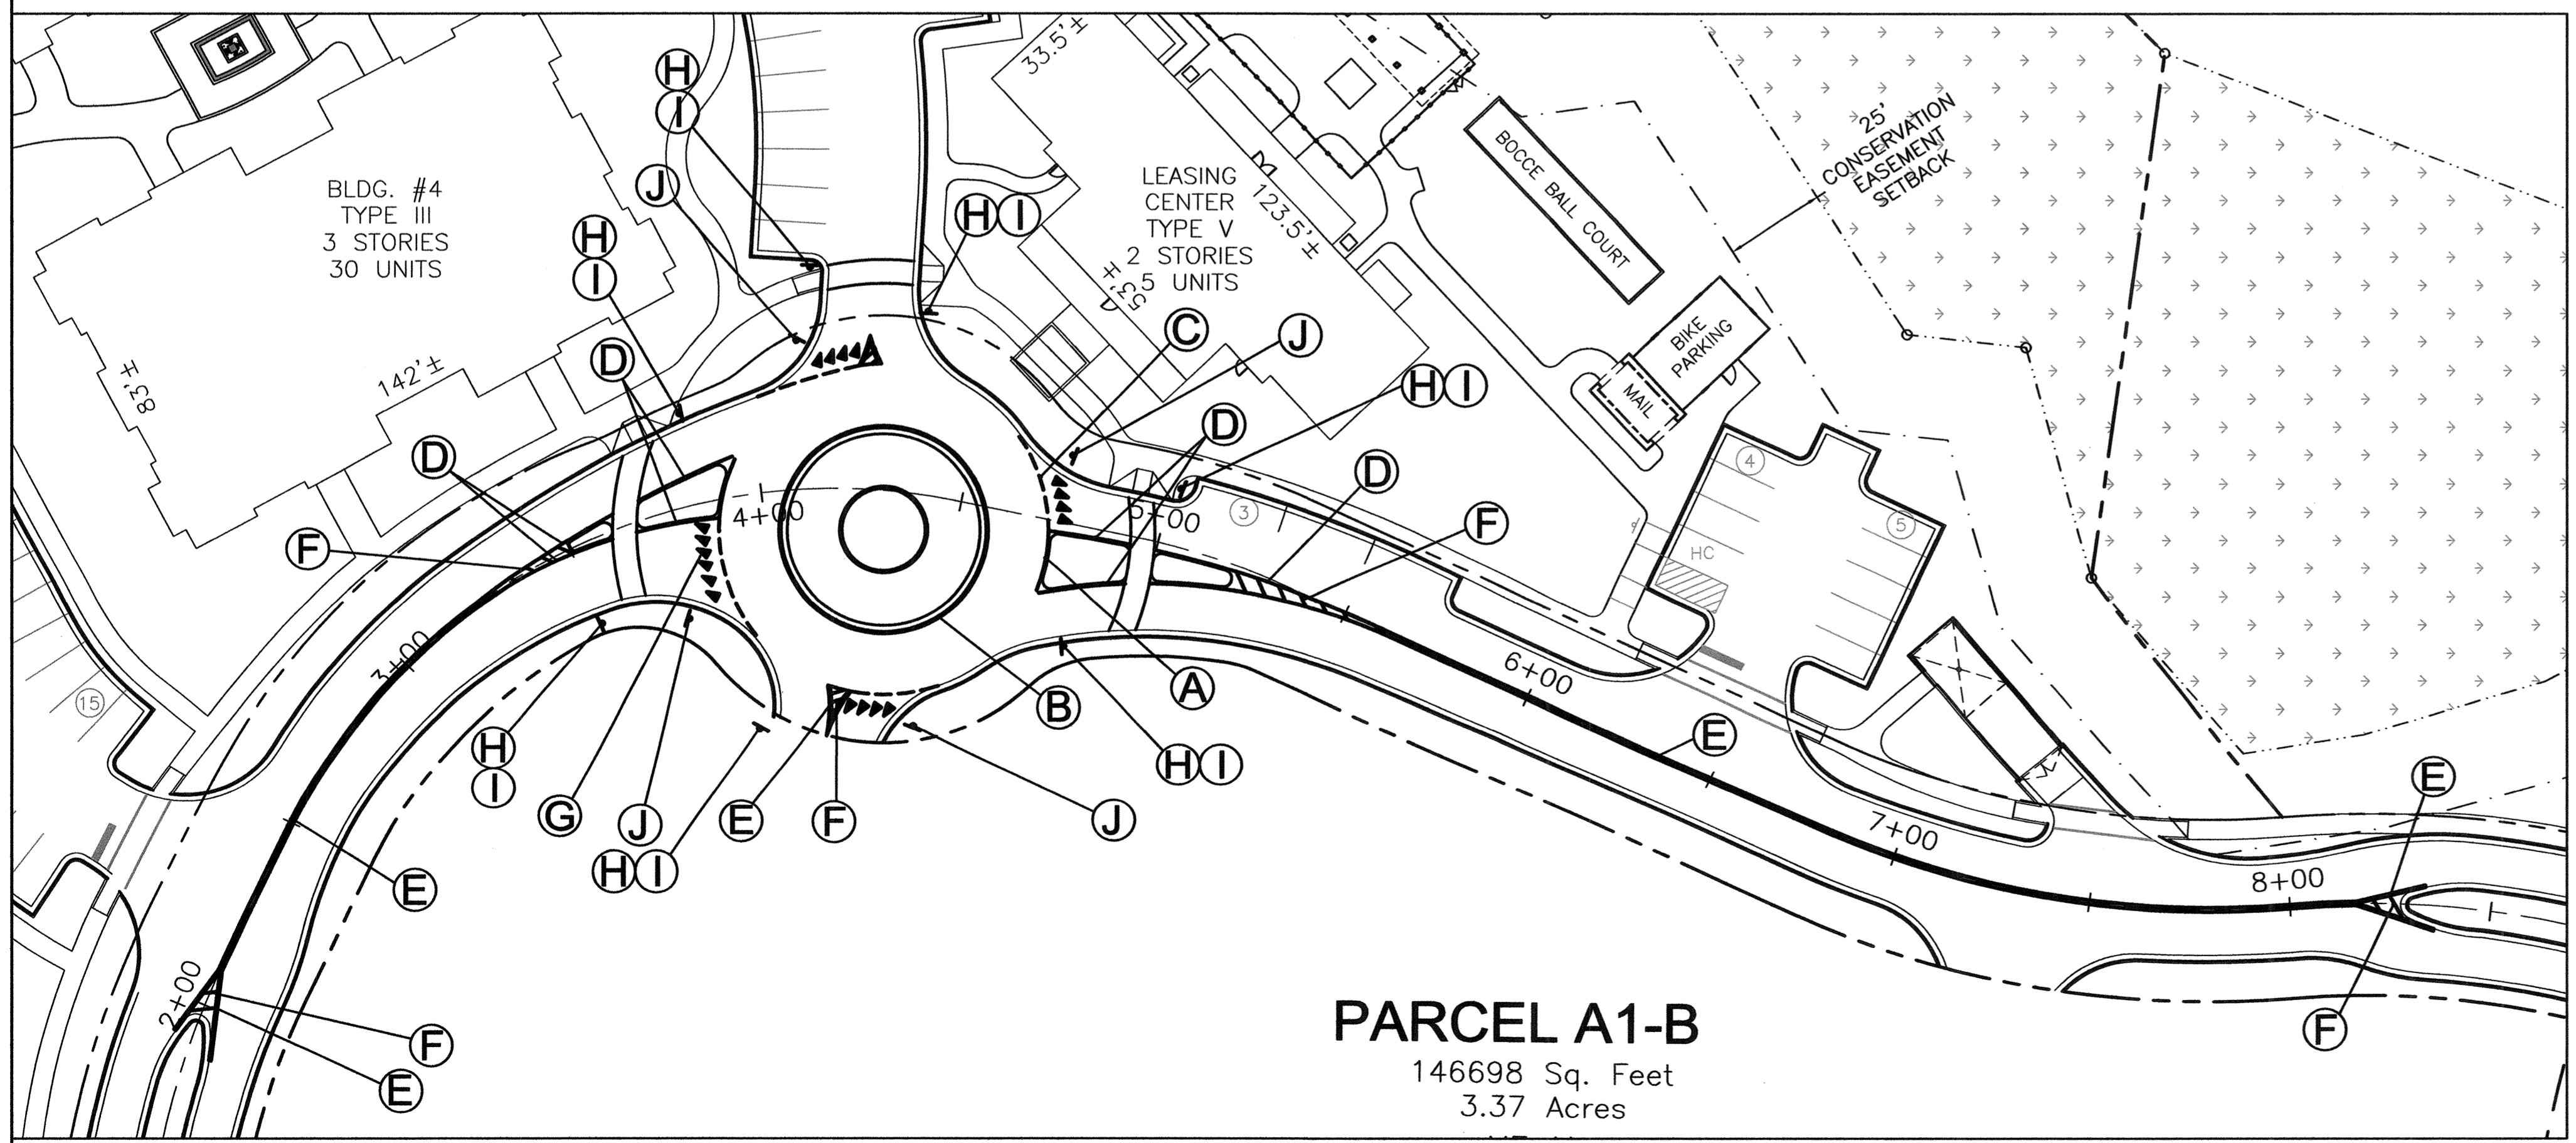


ROUND-A-BOUT PAVEMENT MARKING PLAN
SCALE: 1"=30'

PARCEL A1-B
146698 Sq. Feet
3.37 Acres

PARCEL A1-B

- LEGEND**
- (A) 4" WHITE EDGE LINE
 - (B) 4" YELLOW EDGE LINE
 - (C) 4" 2 FT. WHITE MINI SKIP WITH 4 FT. GAP
 - (D) 4" YELLOW SINGLE CENTER LINE
 - (E) 4" YELLOW DOUBLE CENTER LINE
 - (F) 8" YELLOW DIAGONAL LINE
 - (G) WHITE TRIANGLES
 - (H) W11-2
 - (I) W16-7P
 - (J) R1-2

- NOTES:**
- All pavement markings shall be to NCDOT Standards.
 - All pavement markings shall be thermoplastic.

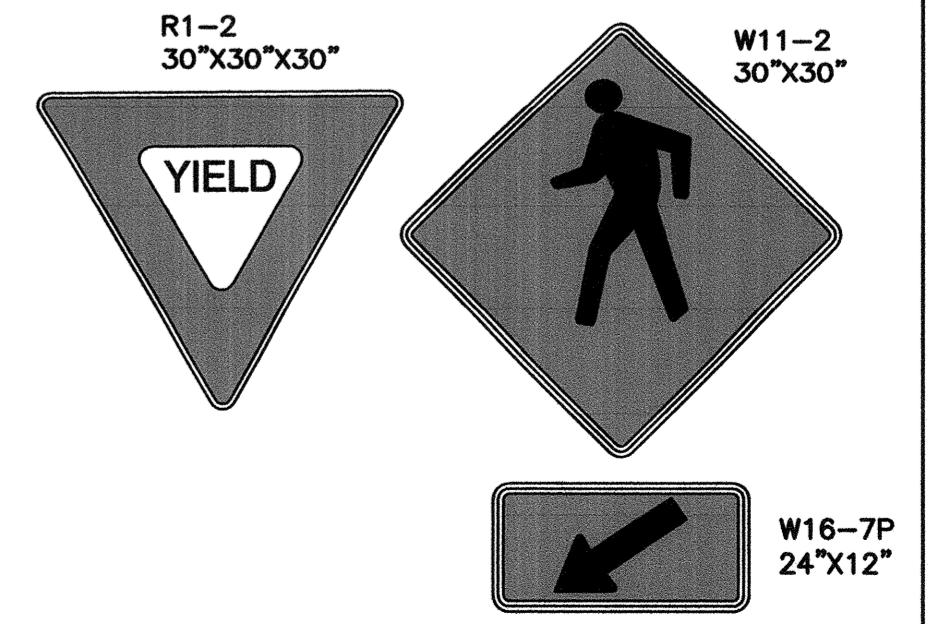

Approved Construction Plan

Name _____ Date _____

Planning _____

Traffic _____

Fire _____

SYMBOL	DATE	DESCRIPTION	BY
		REVISIONS	

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ROUND-A-BOUT DETAILS
TIBURON PARC APARTMENTS
2945 MOYNET WAY
WILMINGTON, NORTH CAROLINA


OWNER:
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1127 FLORAL PARKWAY
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WILMINGTON, NC, 28403
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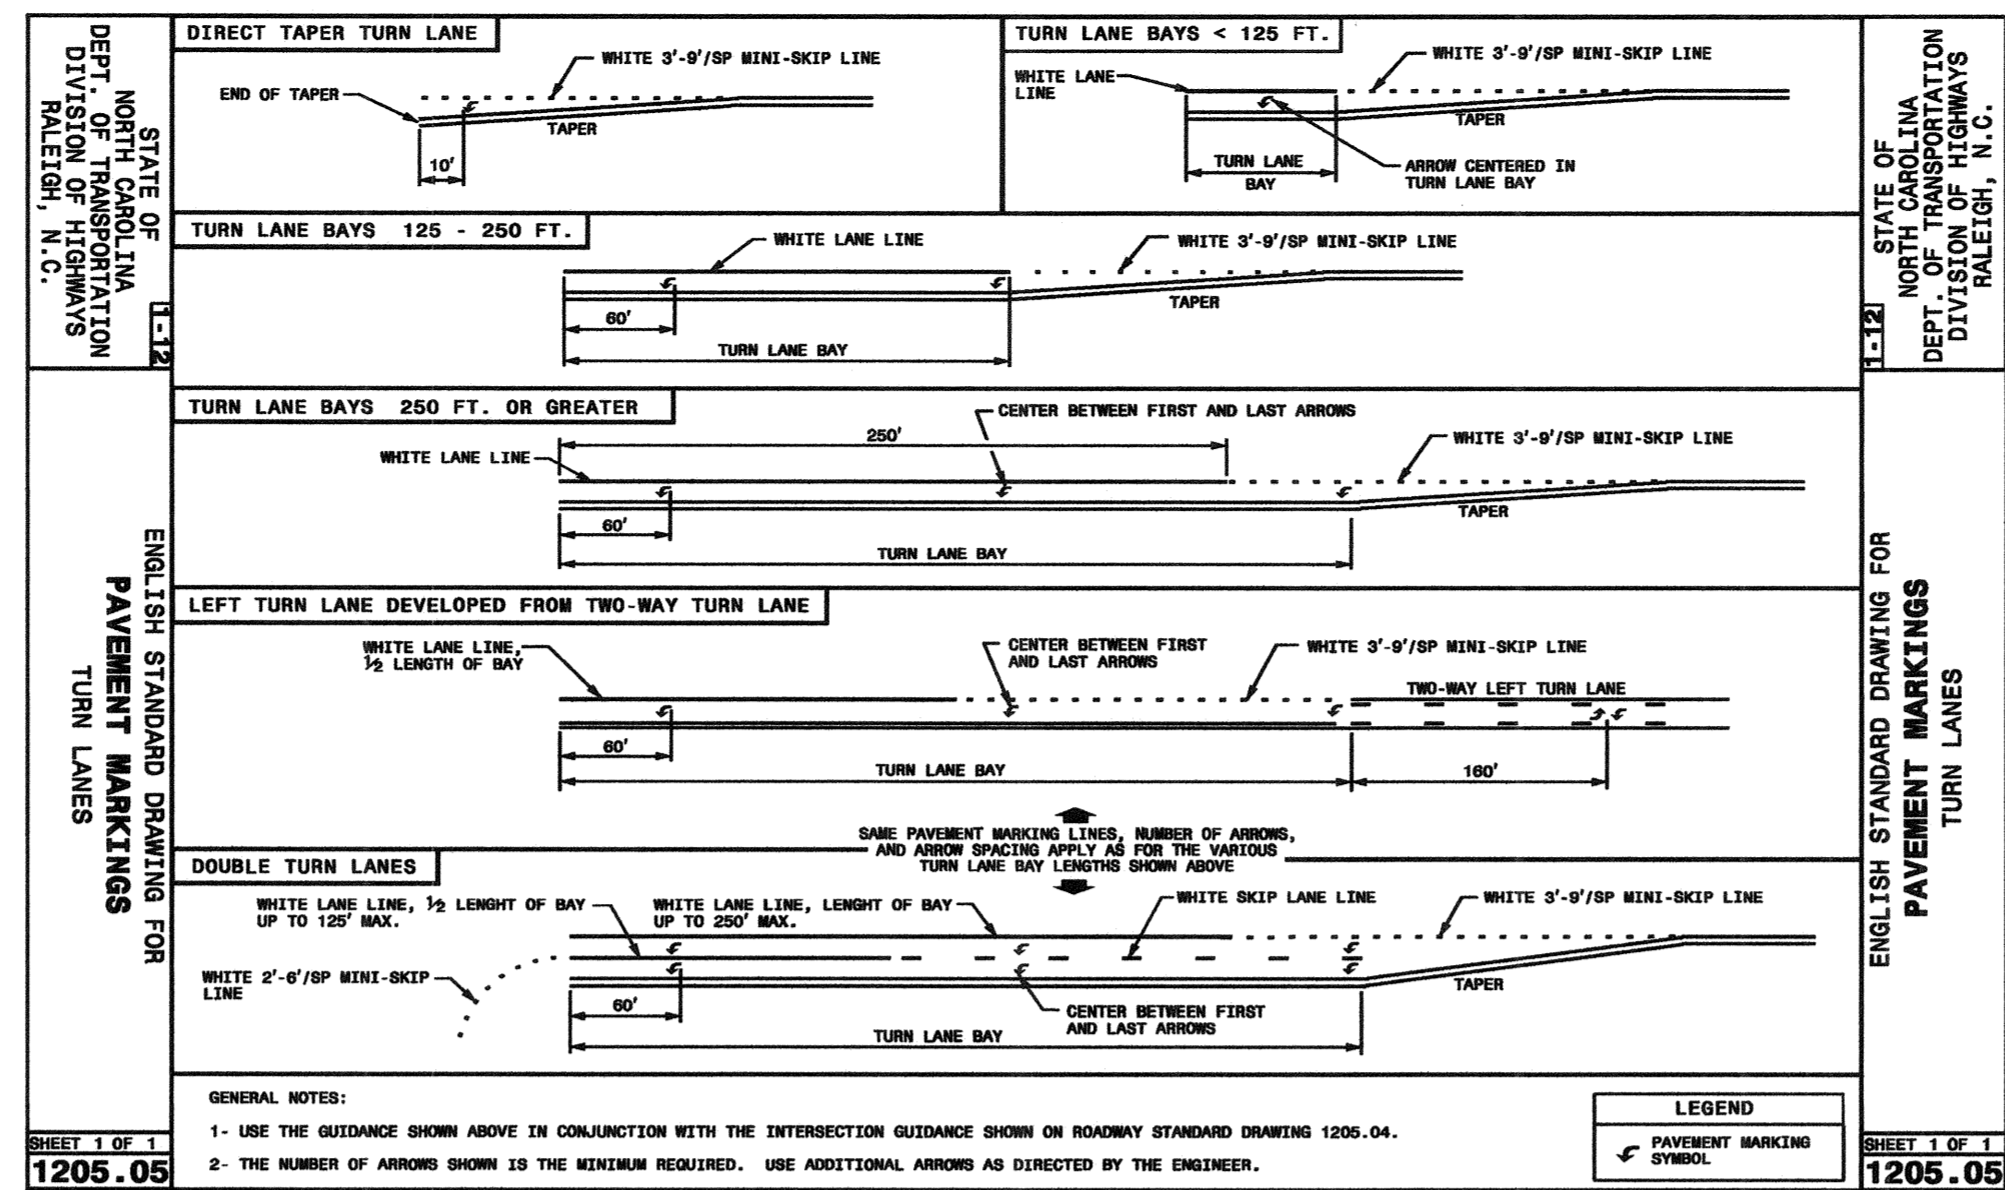
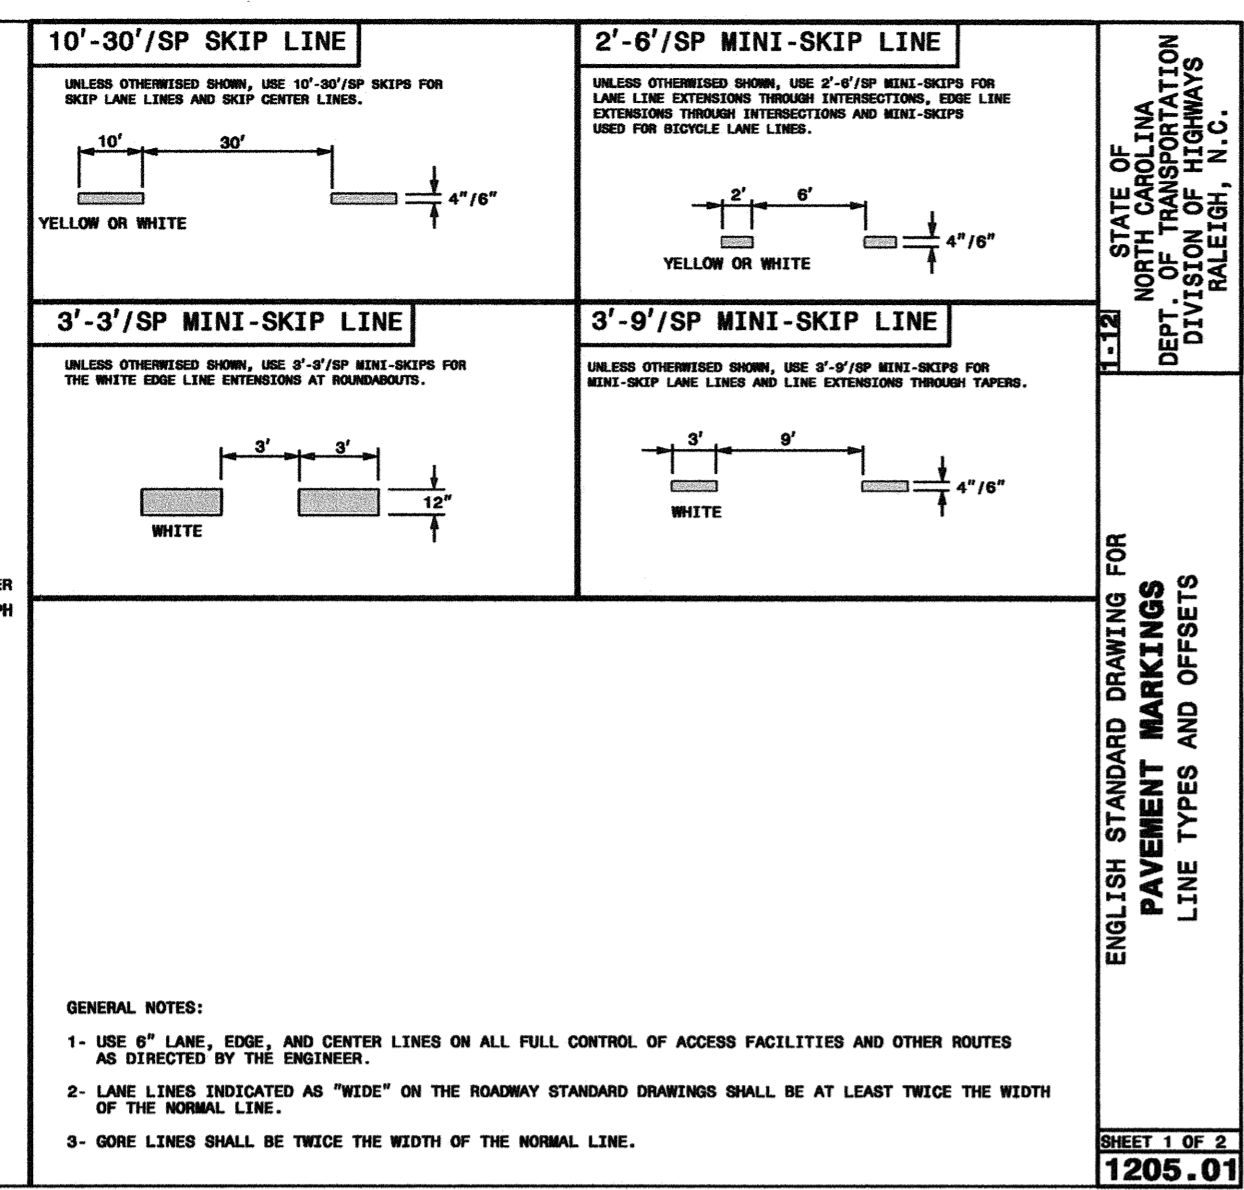
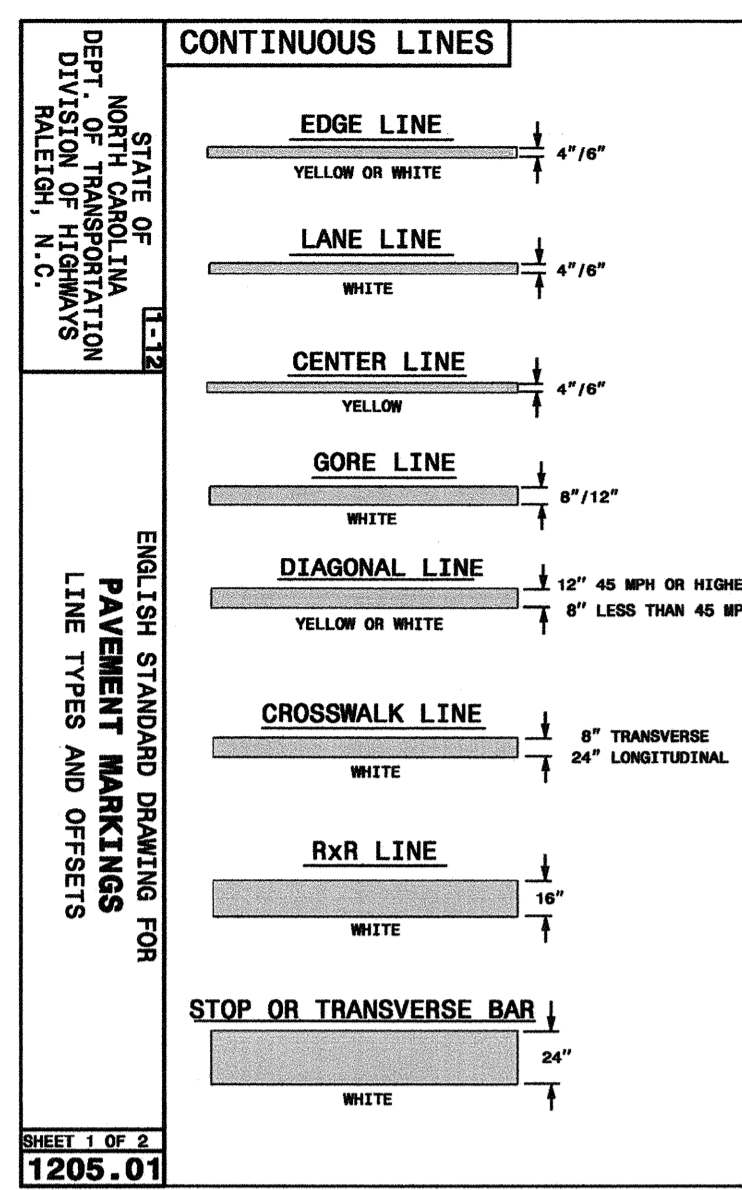
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DES. JST
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DRWN. NKS
DATE 5/2/13



C8



PAVEMENT MARKER SPACING CHART

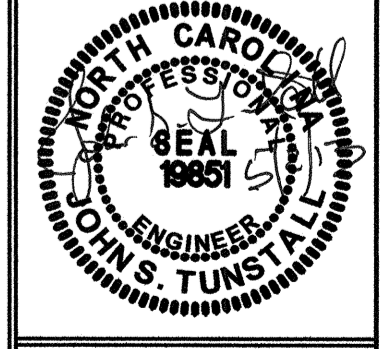
TYPE OF PAVEMENT MARKING	TYPICAL SPACING (FT)
SKIP LINES AND CENTER LINES ALONG THRU LANES:	
ALONG TANGENT SECTIONS AND HORIZONTAL CURVES LESS THAN 6'	80
HORIZONTAL CURVES ≥ 6'	40
TURN LANES:	
MINI-SKIP LINES	24
SKIP LINES	40
SOLID LINES	20
CENTER LINES	20
MINI-SKIP LINES AT LANE DROP APPROACHES	24
TWO-WAY RAMP CENTER LINES	40
EDGE LINES	20
PAINTED ISLANDS:	
WHITE	20
YELLOW	40
RAISED MEDIAN ISLANDS	40
WRONG WAY RAMP ARROW	5
TAPERS	40
NARROW BRIDGES:	
EDGE LINE	20
CENTER LINE	40
ONE LANE BRIDGES:	
EDGE LINE	20
WORK ZONE APPLICATIONS	
2 LANE, 2-WAY ON-SITE DIVERSION	20 FT. FOR CENTER LINE
ALL OTHER DIVERSIONS	1/2 NORMAL SPACING

GENERAL NOTES:
1- MARKERS ARE GENERALLY NOT REQUIRED ALONG EDGE LINES EXCEPT IF DESIGNATED IN THE PLANS OR DIRECTED BY THE ENGINEER. WHEN THEY ARE REQUIRED, SPACE THEM ON 20 FT., CENTERS, AND OFFSET 2 INCHES FROM THE EDGE LINE ON THE TRAFFIC SIDE.
2- PLACE CRYSTAL/RED MARKERS AT INTERSECTIONS AND INTERCHANGES WHERE WIDING-WAY MOVEMENTS ARE POSSIBLE. POSITION THE RED SIDE OF THE MARKER TO FACE "WIDING-WAY" TRAFFIC. WHEN USED, PLACE CRYSTAL/RED MARKERS ALONG THE ENTIRE LENGTH OF THE PROJECT.
3- DO NOT PLACE PAVEMENT MARKERS CLOSER THAN 3 INCHES TO A PAVEMENT CONSTRUCTION JOINT (AS FEASIBLE). EXCEPT WHEN PLACED BETWEEN DOUBLE YELLOW CENTER LINES, AND ALONG YELLOW SKIP LINES ON TWO-LANE, TWO-WAY ROADWAYS WHERE PASSING IS ALLOWED IN BOTH DIRECTIONS.
4- DO NOT PLACE PAVEMENT MARKERS DIRECTLY ON PAVEMENT.
5- PLACE PAVEMENT MARKERS USED IN CONJUNCTION WITH DOUBLE YELLOW CENTER LINES MID-WAY BETWEEN THE LINES. PROVIDE A GAP BETWEEN THE LINES AND THE MARKER TO REDUCE OVERLAPPING THE MARKER DURING REPAINTING OPERATIONS.
6- MARKERS ARE NOT REQUIRED ALONG MINI-SKIP LINES IN TAPERS.

STATE OF NORTH CAROLINA
DEPT. OF TRANSPORTATION
DIVISION OF HIGHWAYS
RALEIGH, N.C.

ENGLISH STANDARD DRAWING FOR
RAISED PAVEMENT MARKERS
INSTALLATION SPACING

SHEET 1 OF 3
1250.01

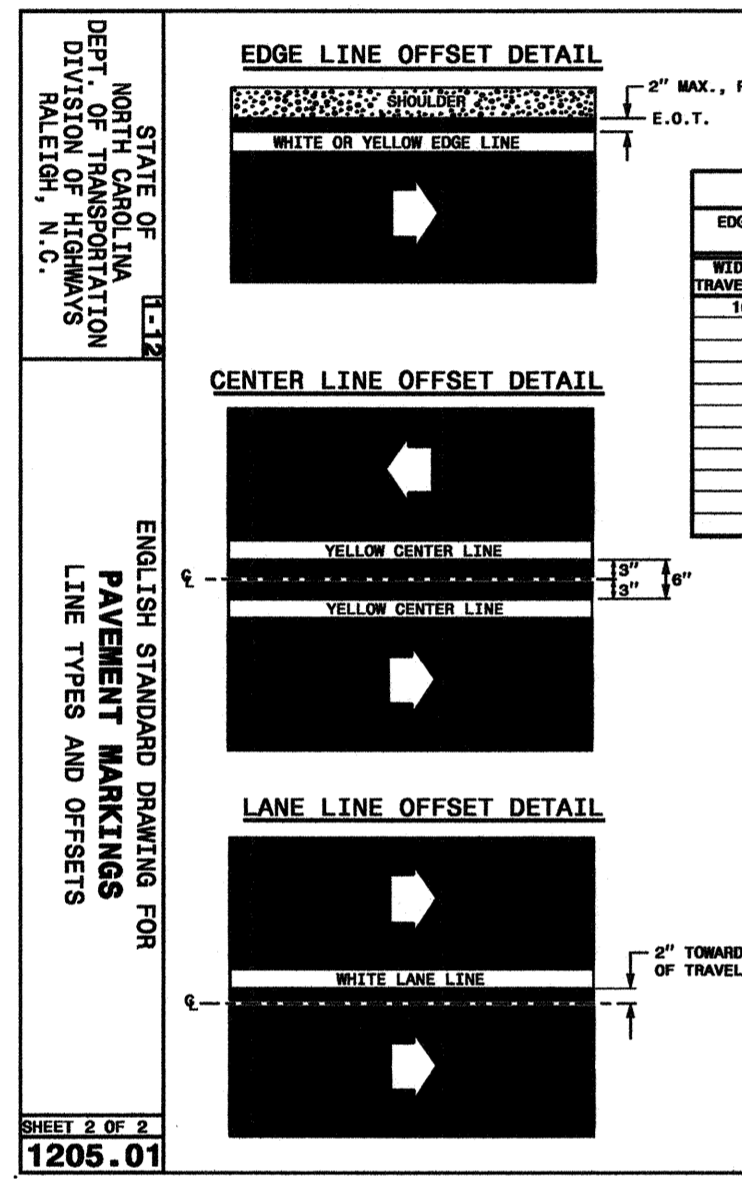

TWO-WAY UNDIVIDED ROADWAY

TWO-WAY UNDIVIDED ROADWAY WITH TWO-WAY LEFT TURN LANE

MULTI-LANE ROADWAY

TABLE 1







EDGE LINE OFFSET FROM TRAVEL LANE (MIN. OFFSET)	MINIMUM LANE WIDTH (FT)	MINIMUM LANE WIDTH (FT)
10'	10'	10'
12'	12'	12'
15'	15'	15'
18'	18'	18'
20'	20'	20'
22'	22'	22'
24'	24'	24'
26'	26'	26'
28'	28'	28'
30'	30'	30'
32'	32'	32'

LEGEND:
W = WIDTH OF TRAVEL LANE
E.O.T. = EDGE OF TRAVEL
• = CENTER OF TRAFFIC FLOW

STATE OF NORTH CAROLINA
DEPT. OF TRANSPORTATION
DIVISION OF HIGHWAYS
RALEIGH, N.C.

ENGLISH STANDARD DRAWING FOR
PAVEMENT MARKINGS
LINE TYPES AND OFFSETS

SHEET 2 OF 2
1205.01

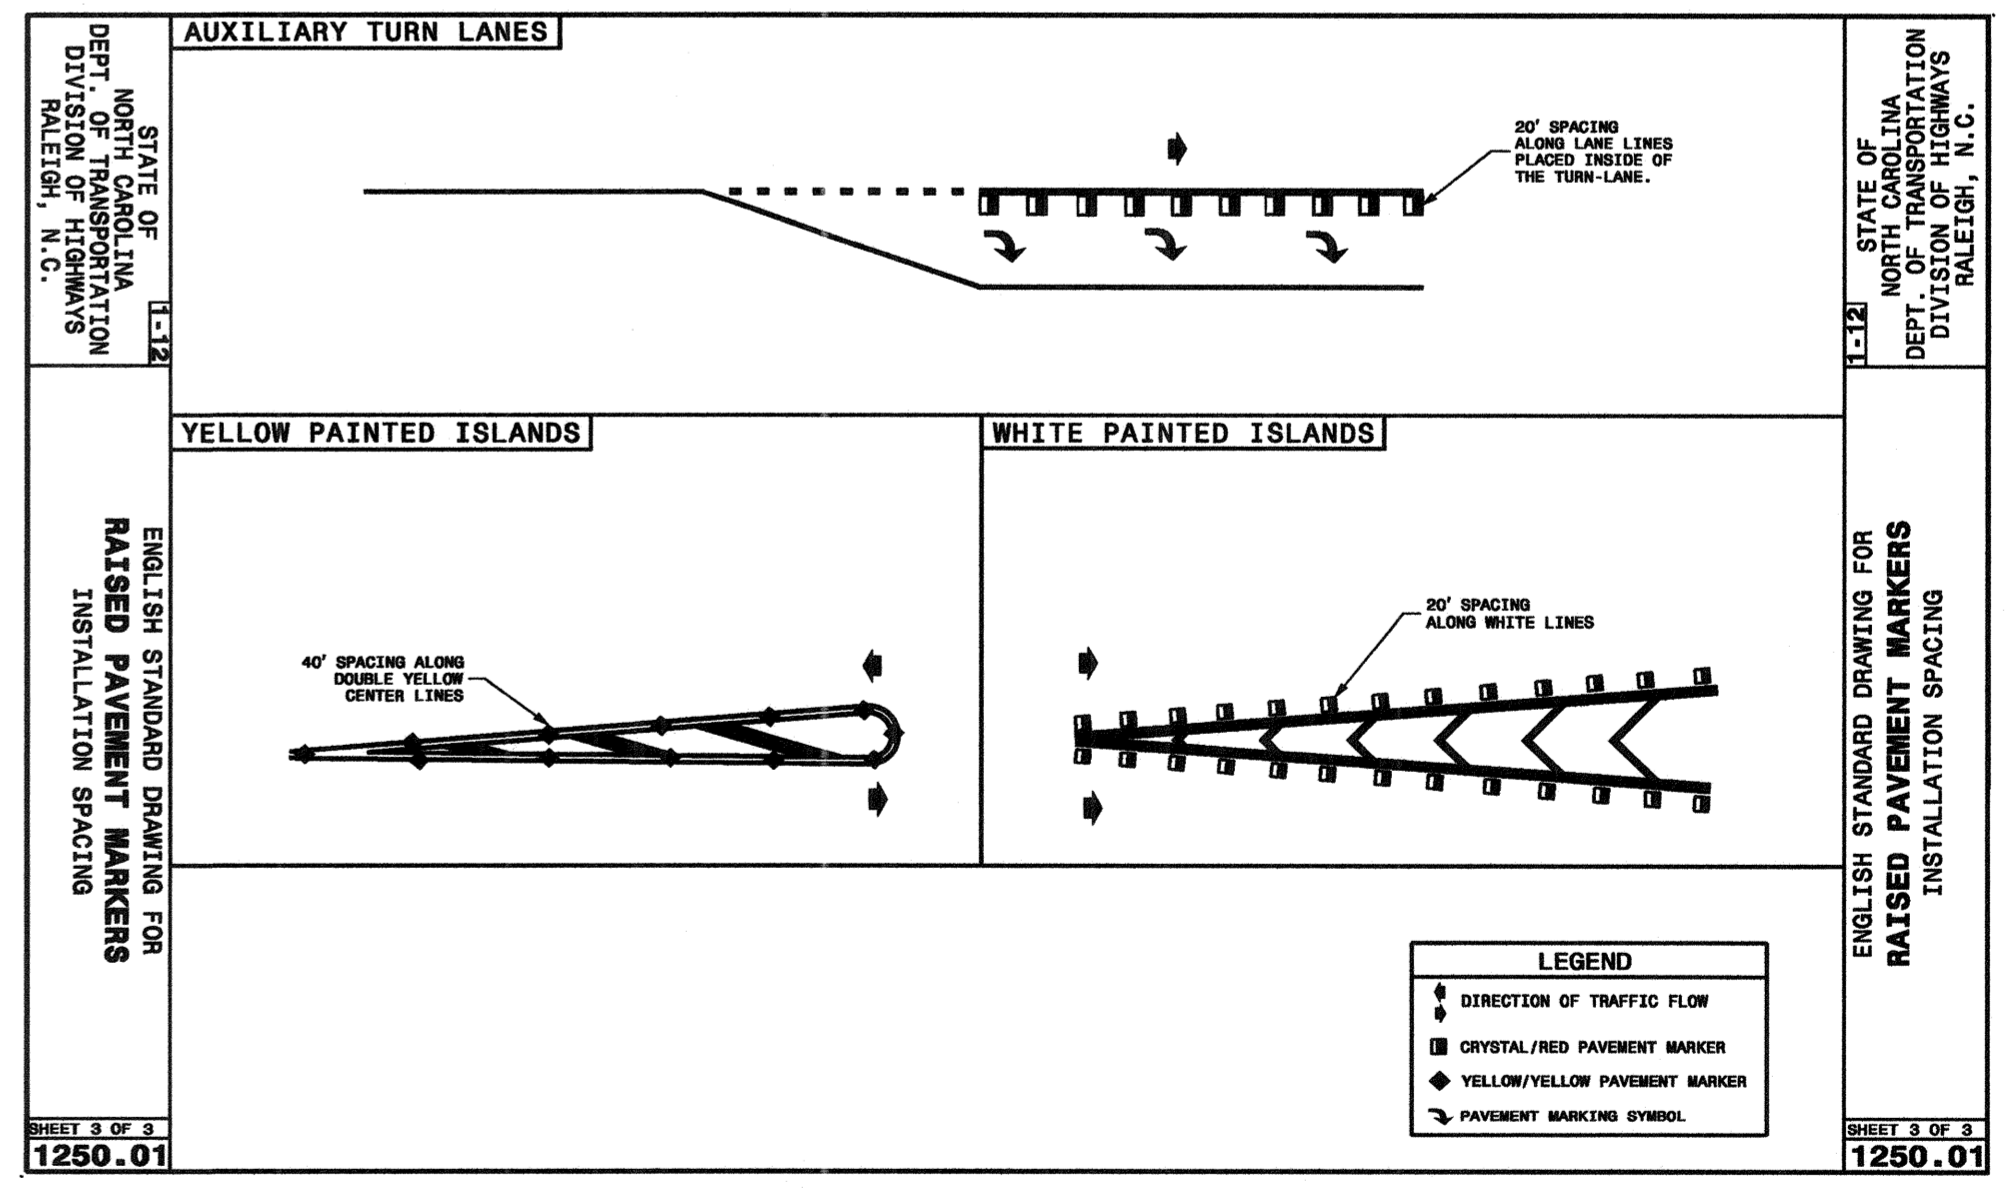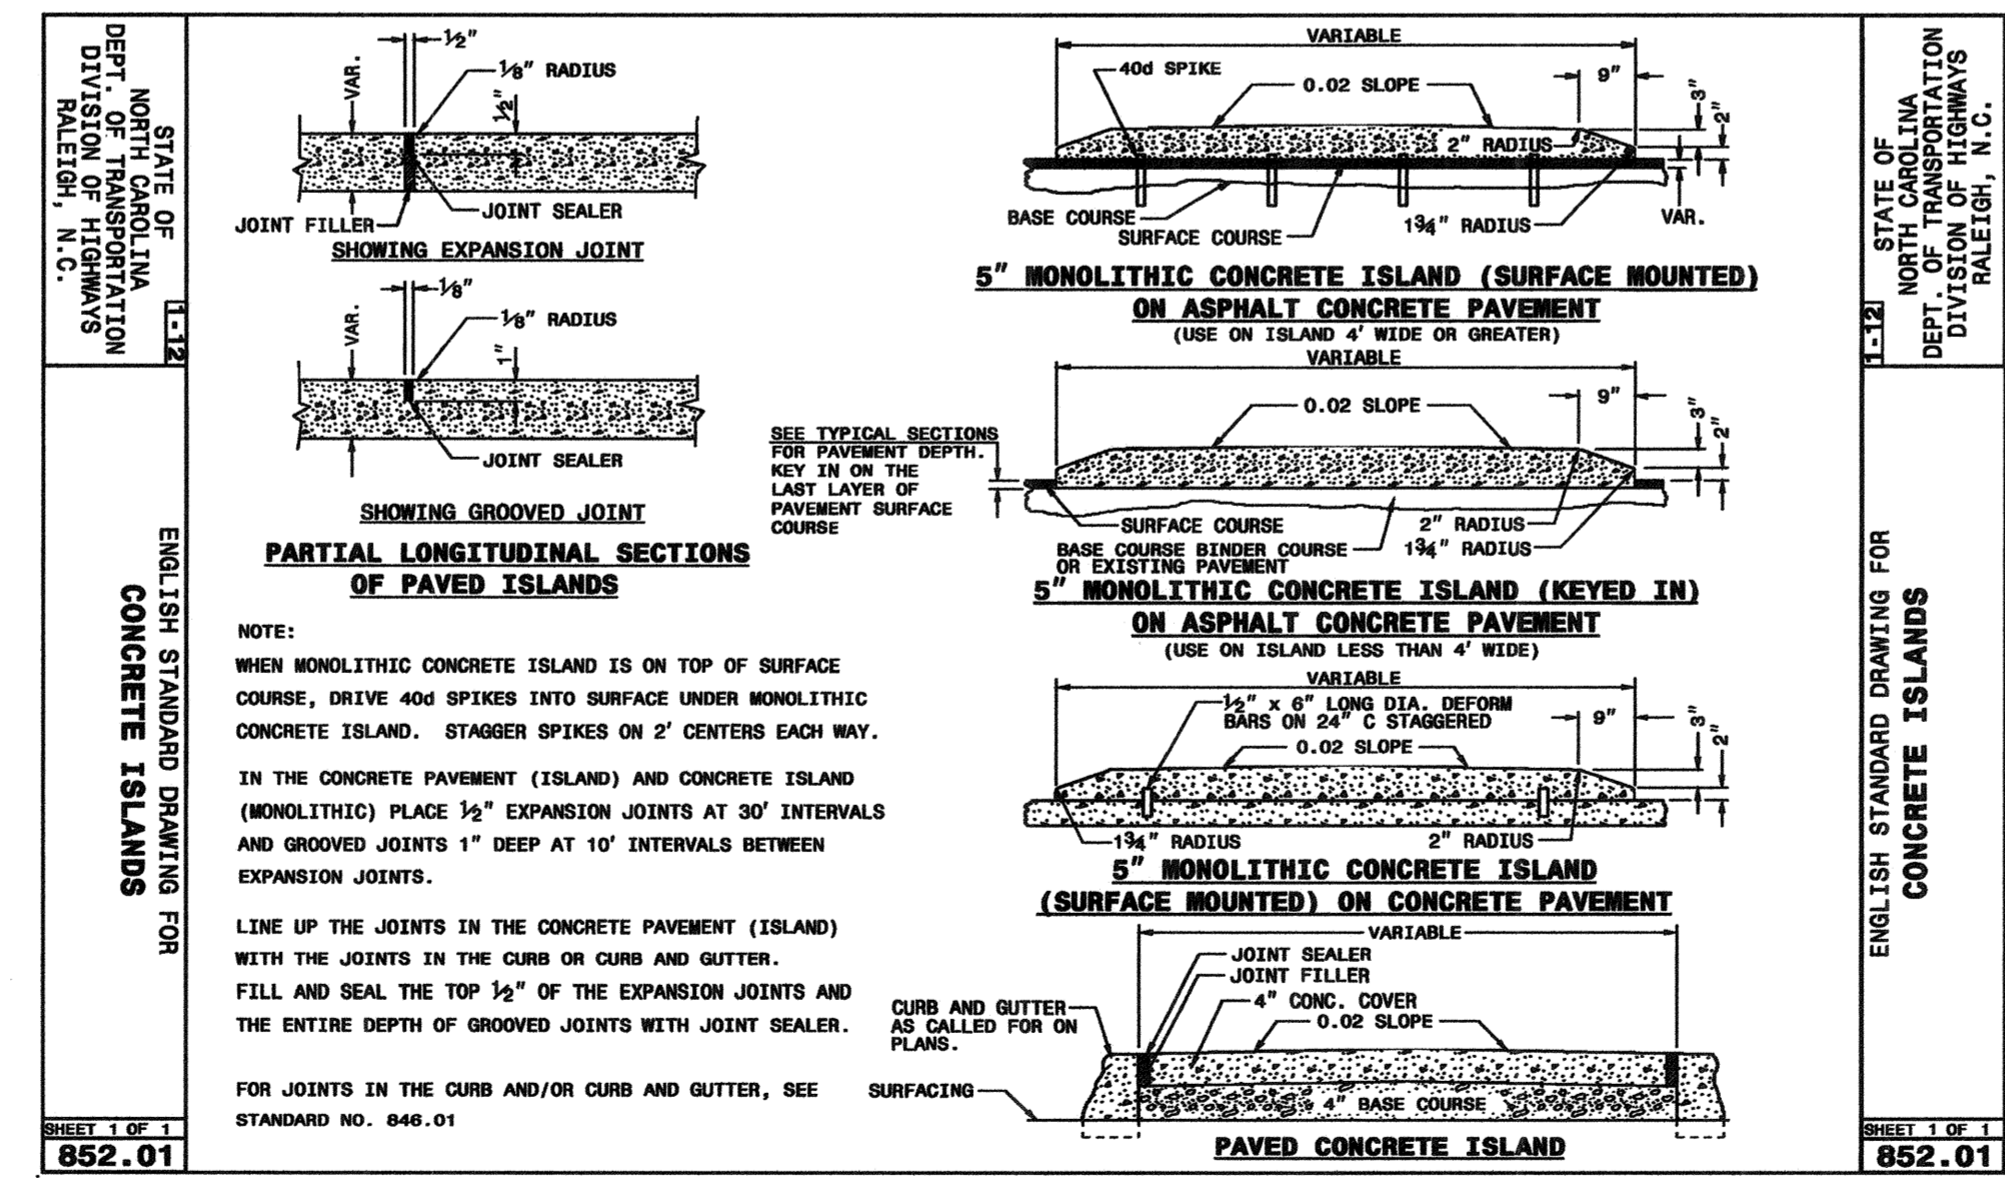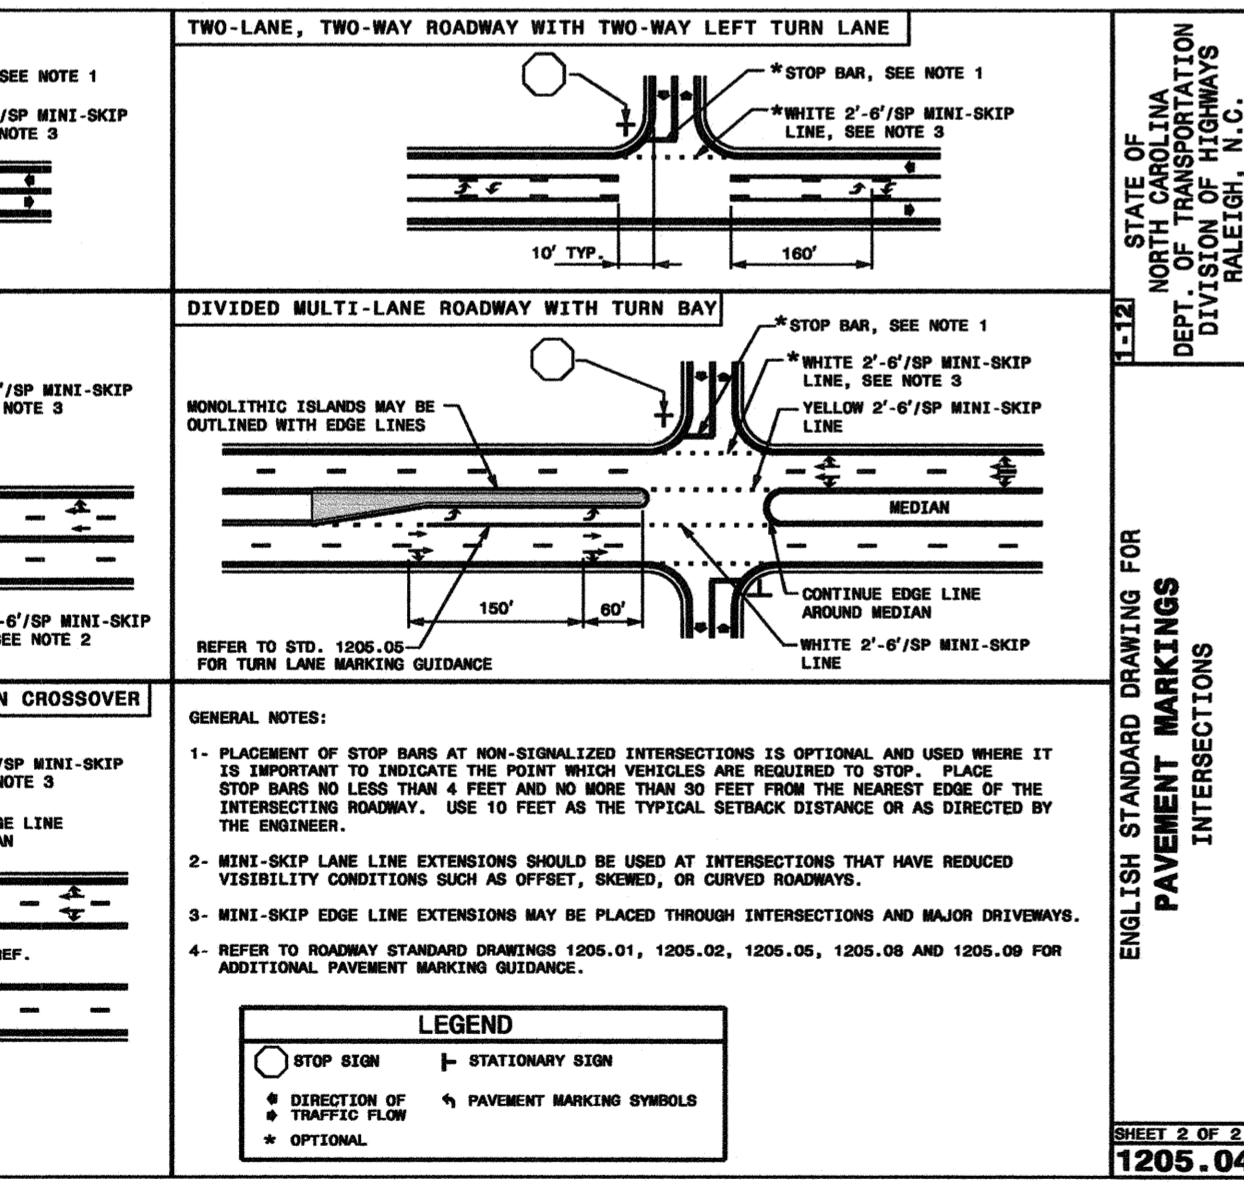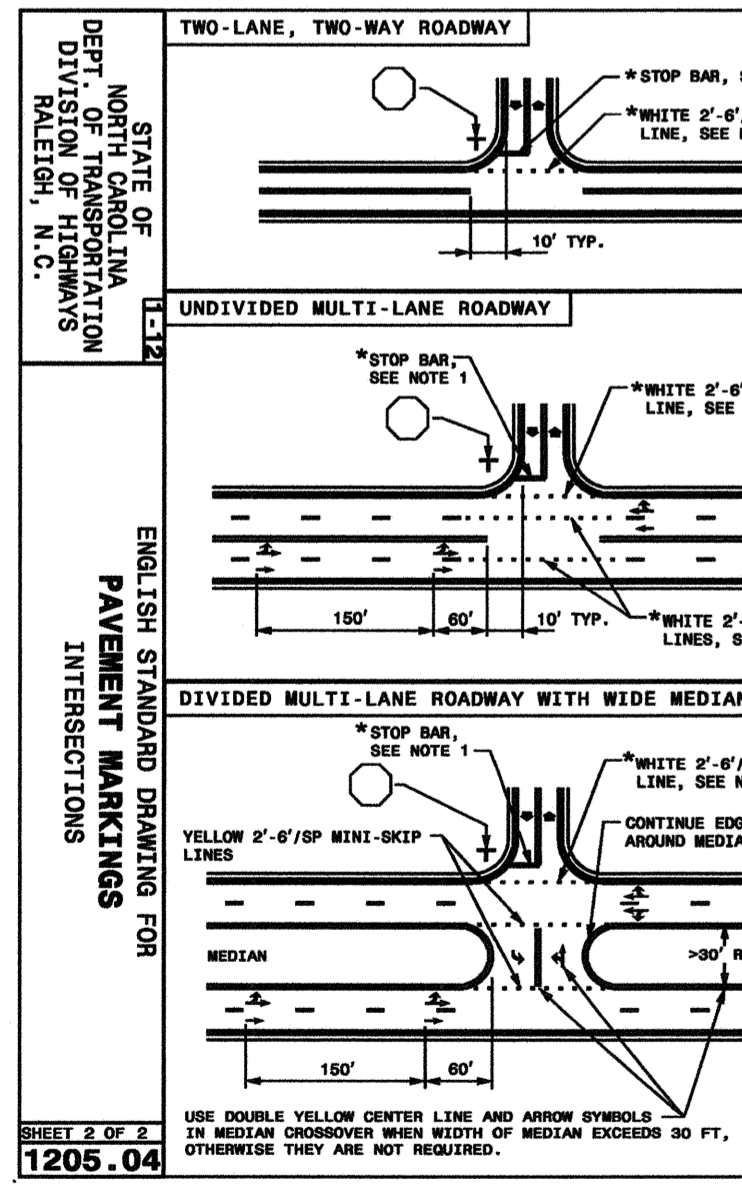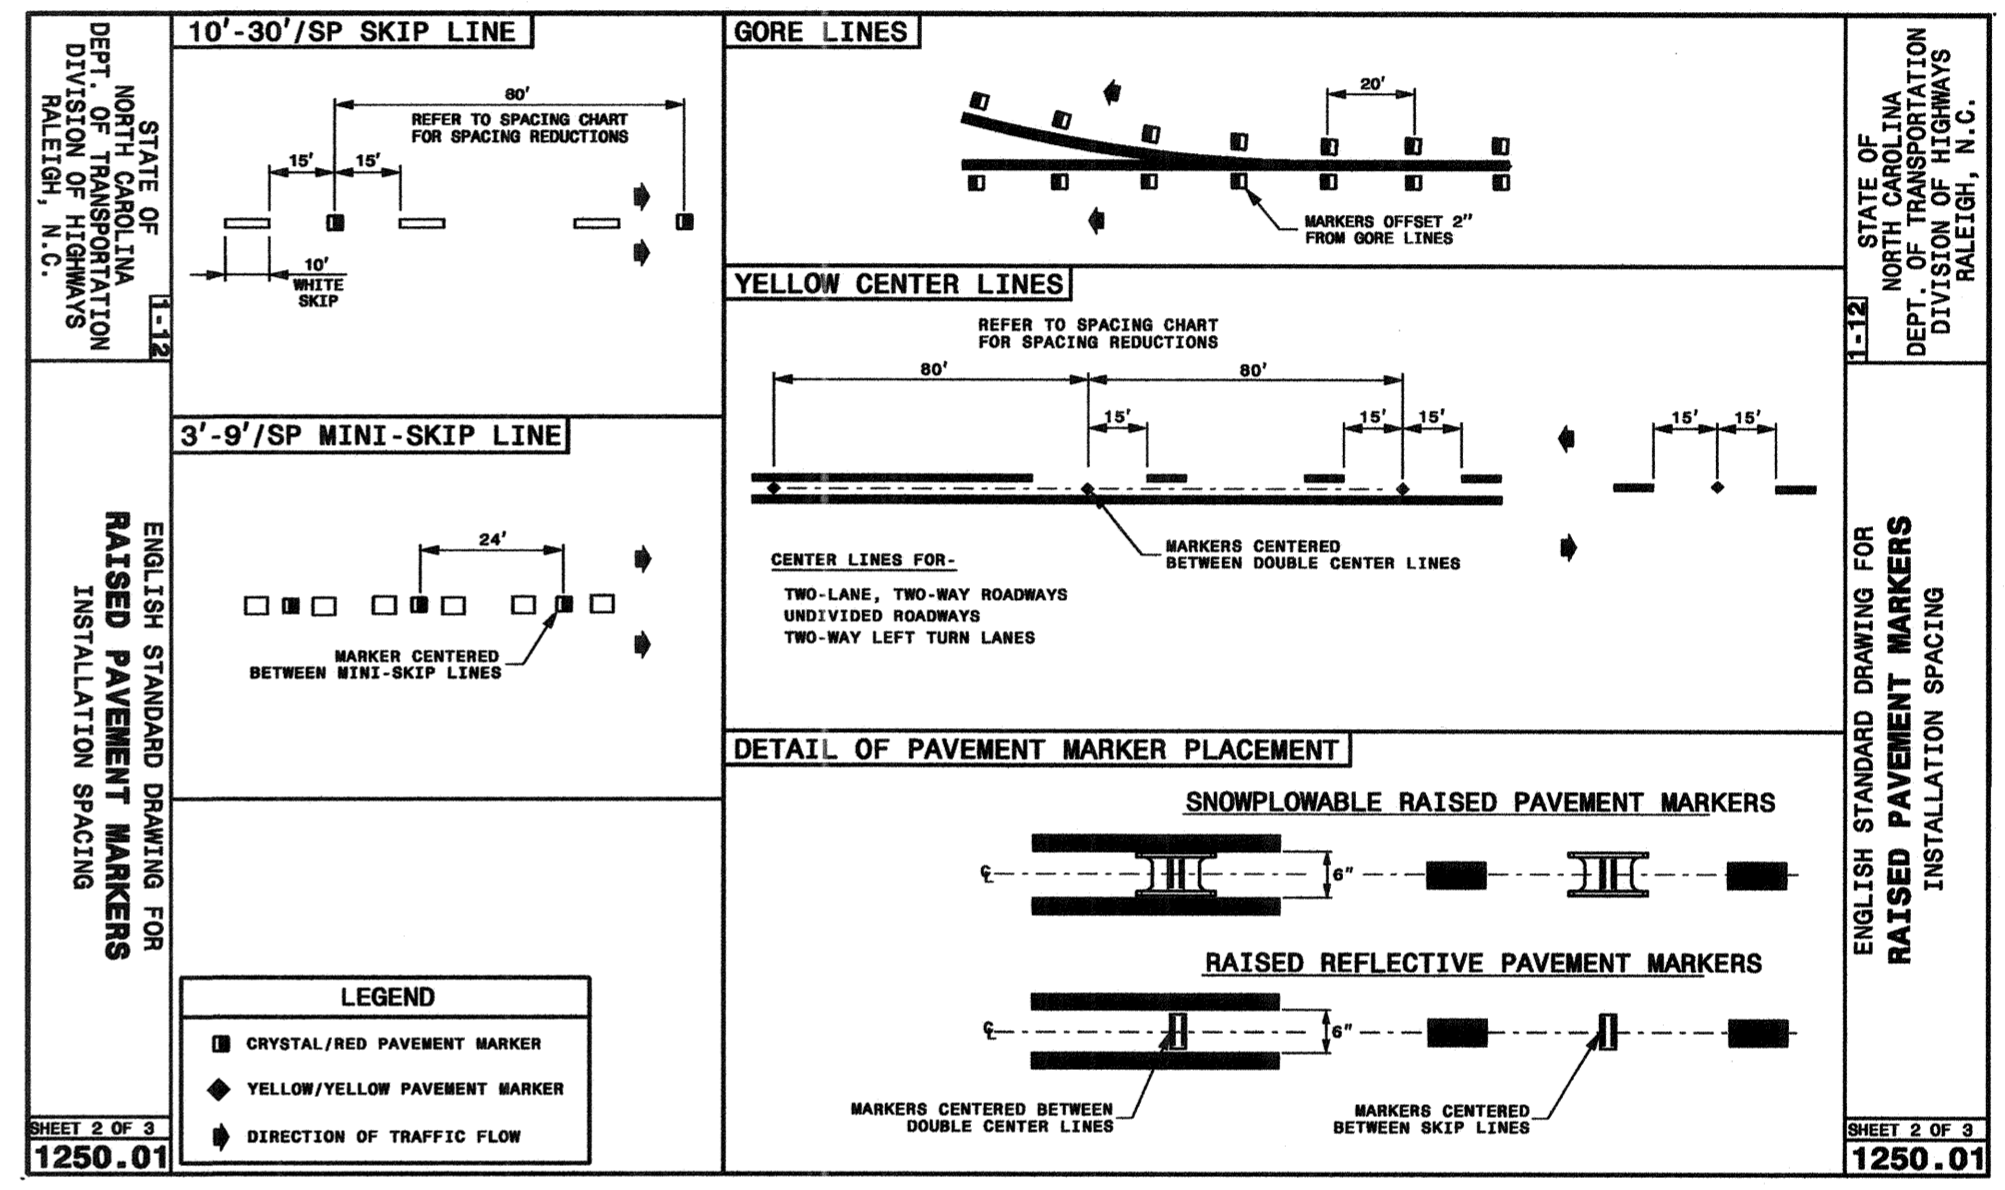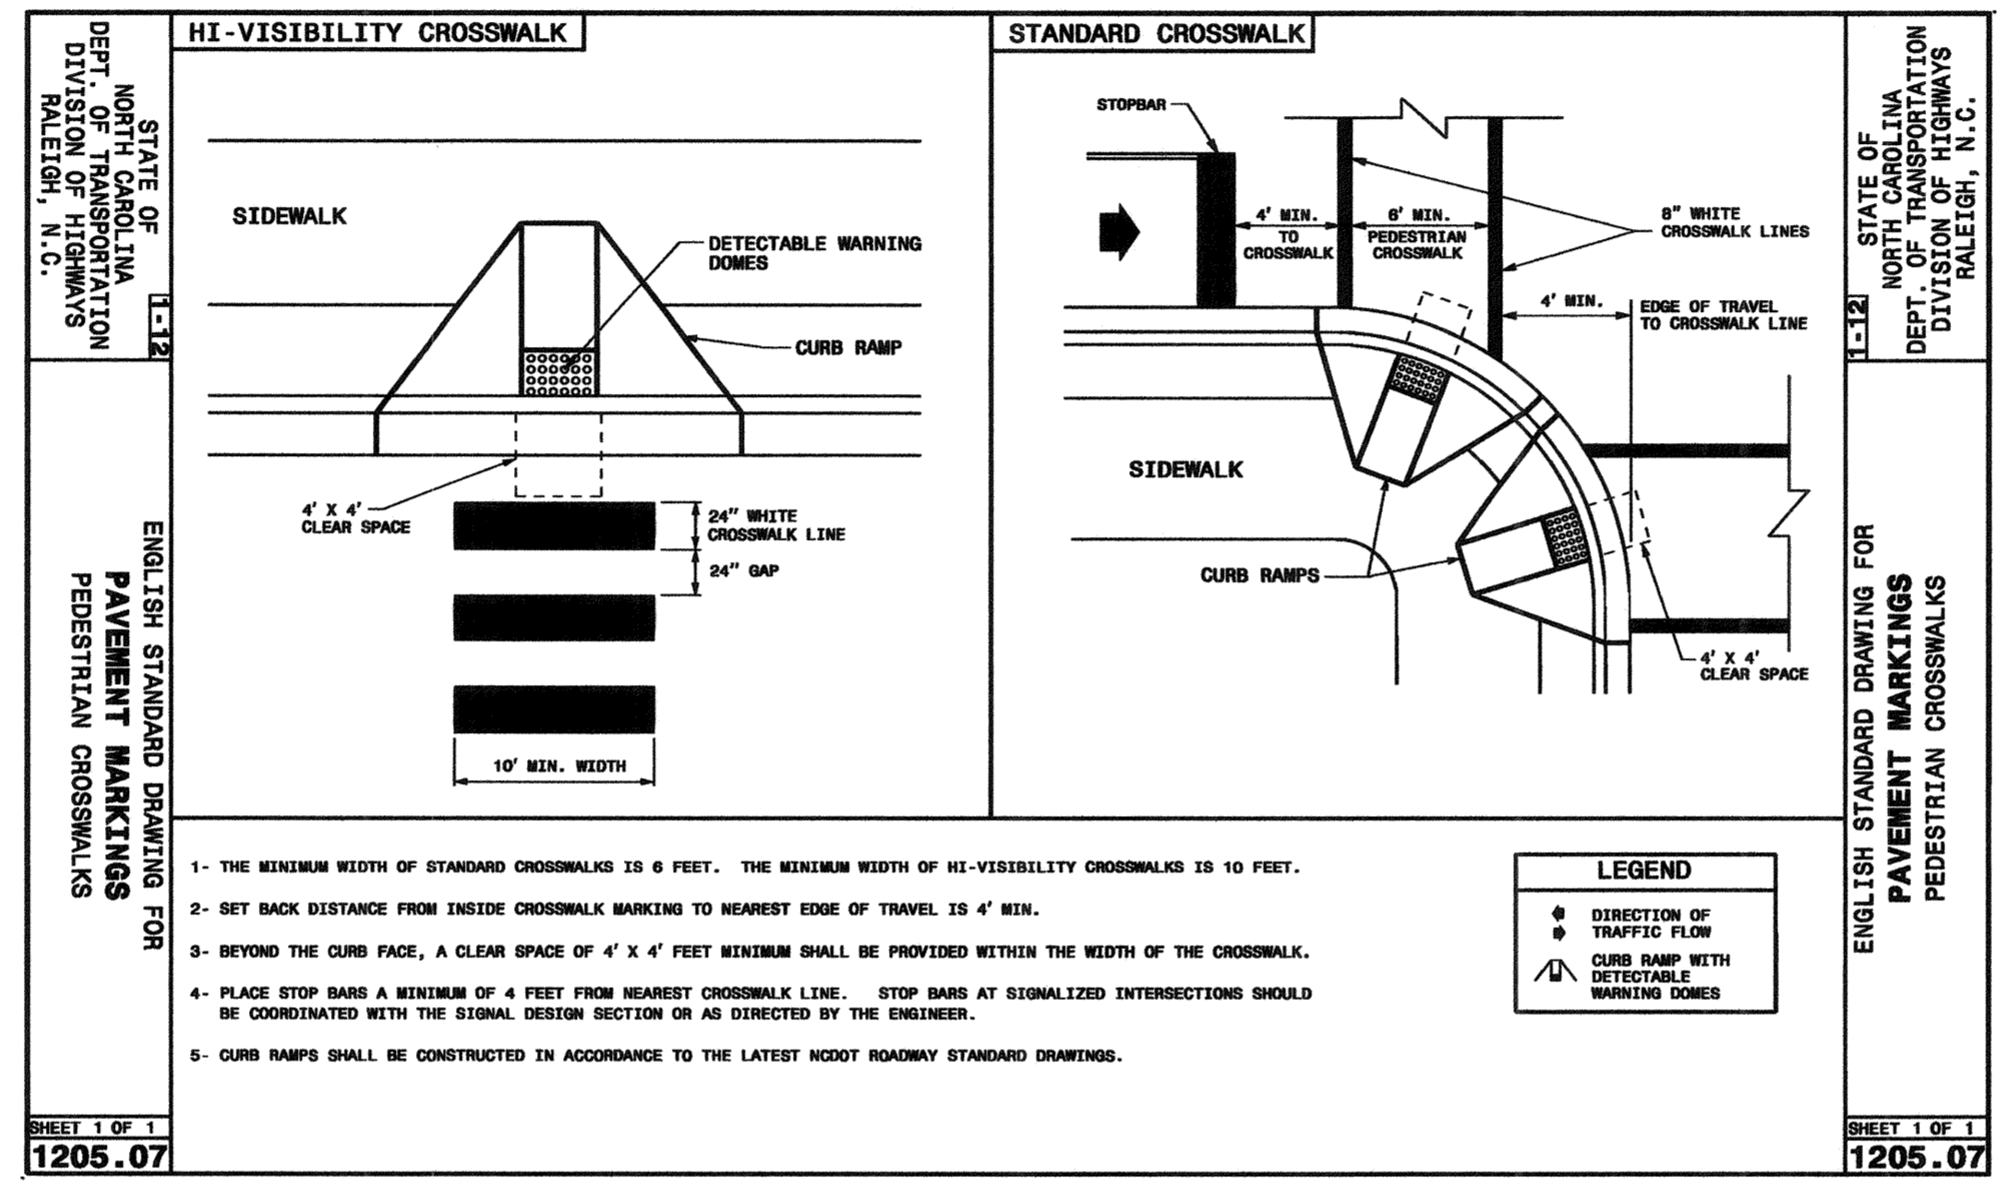


NOTES AND DETAILS
TIBURON PARC APARTMENTS
2945 MOYNET WAY
WILMINGTON, NORTH CAROLINA

OWNER:
NELSON MACRAE
MIDTOWN ONE, LLC
P.O. BOX 3145
WILMINGTON, N.C. 28406
910-392-3300

NORRIS & TUNSTALL
CONSULTING ENGINEERS, INC.
1127 FLORAL PARKWAY
SUITE 400
WILMINGTON, NC, 28403
PHONE (910) 343-9653
FAX (910) 343-9604
office@nteng.com
license #C-3681

HUD/PERMIT SET
12073
DES. JST
CKD. JPN
DRWN. NKS
DATE 5/2/13

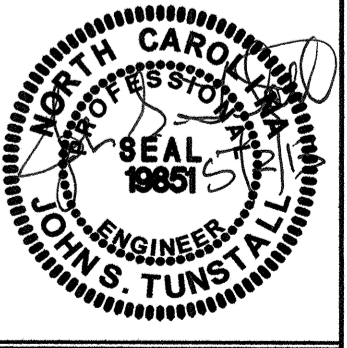

Approved Construction Plan


Name _____ Date _____

Planning _____

Traffic _____

Fire _____


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LOCATION MAP

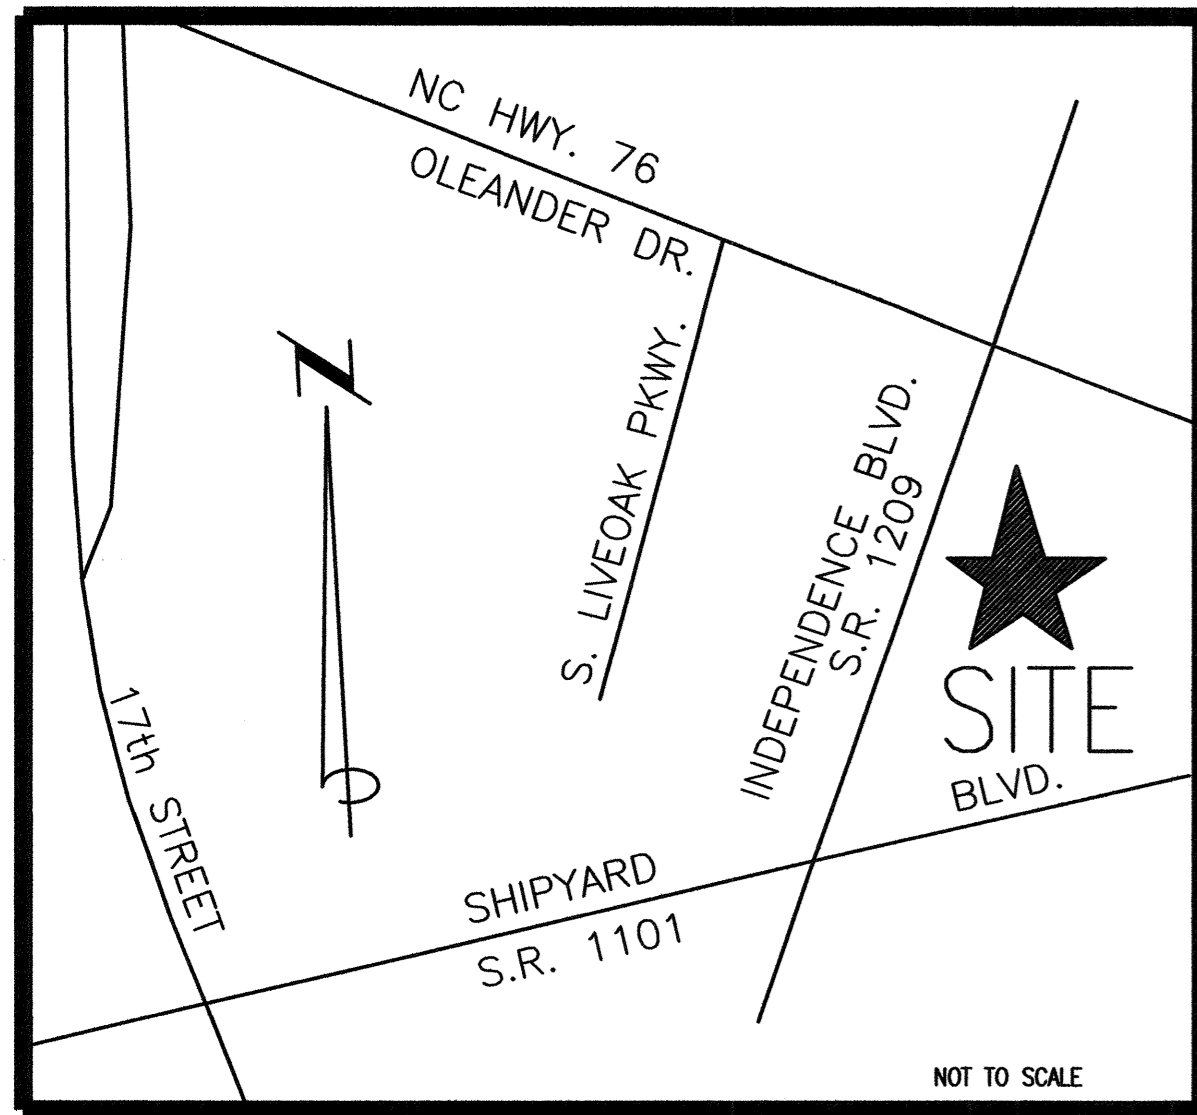
TIBURON PARC APARTMENTS

WILMINGTON, NC
NEW HANOVER COUNTY



LEGEND

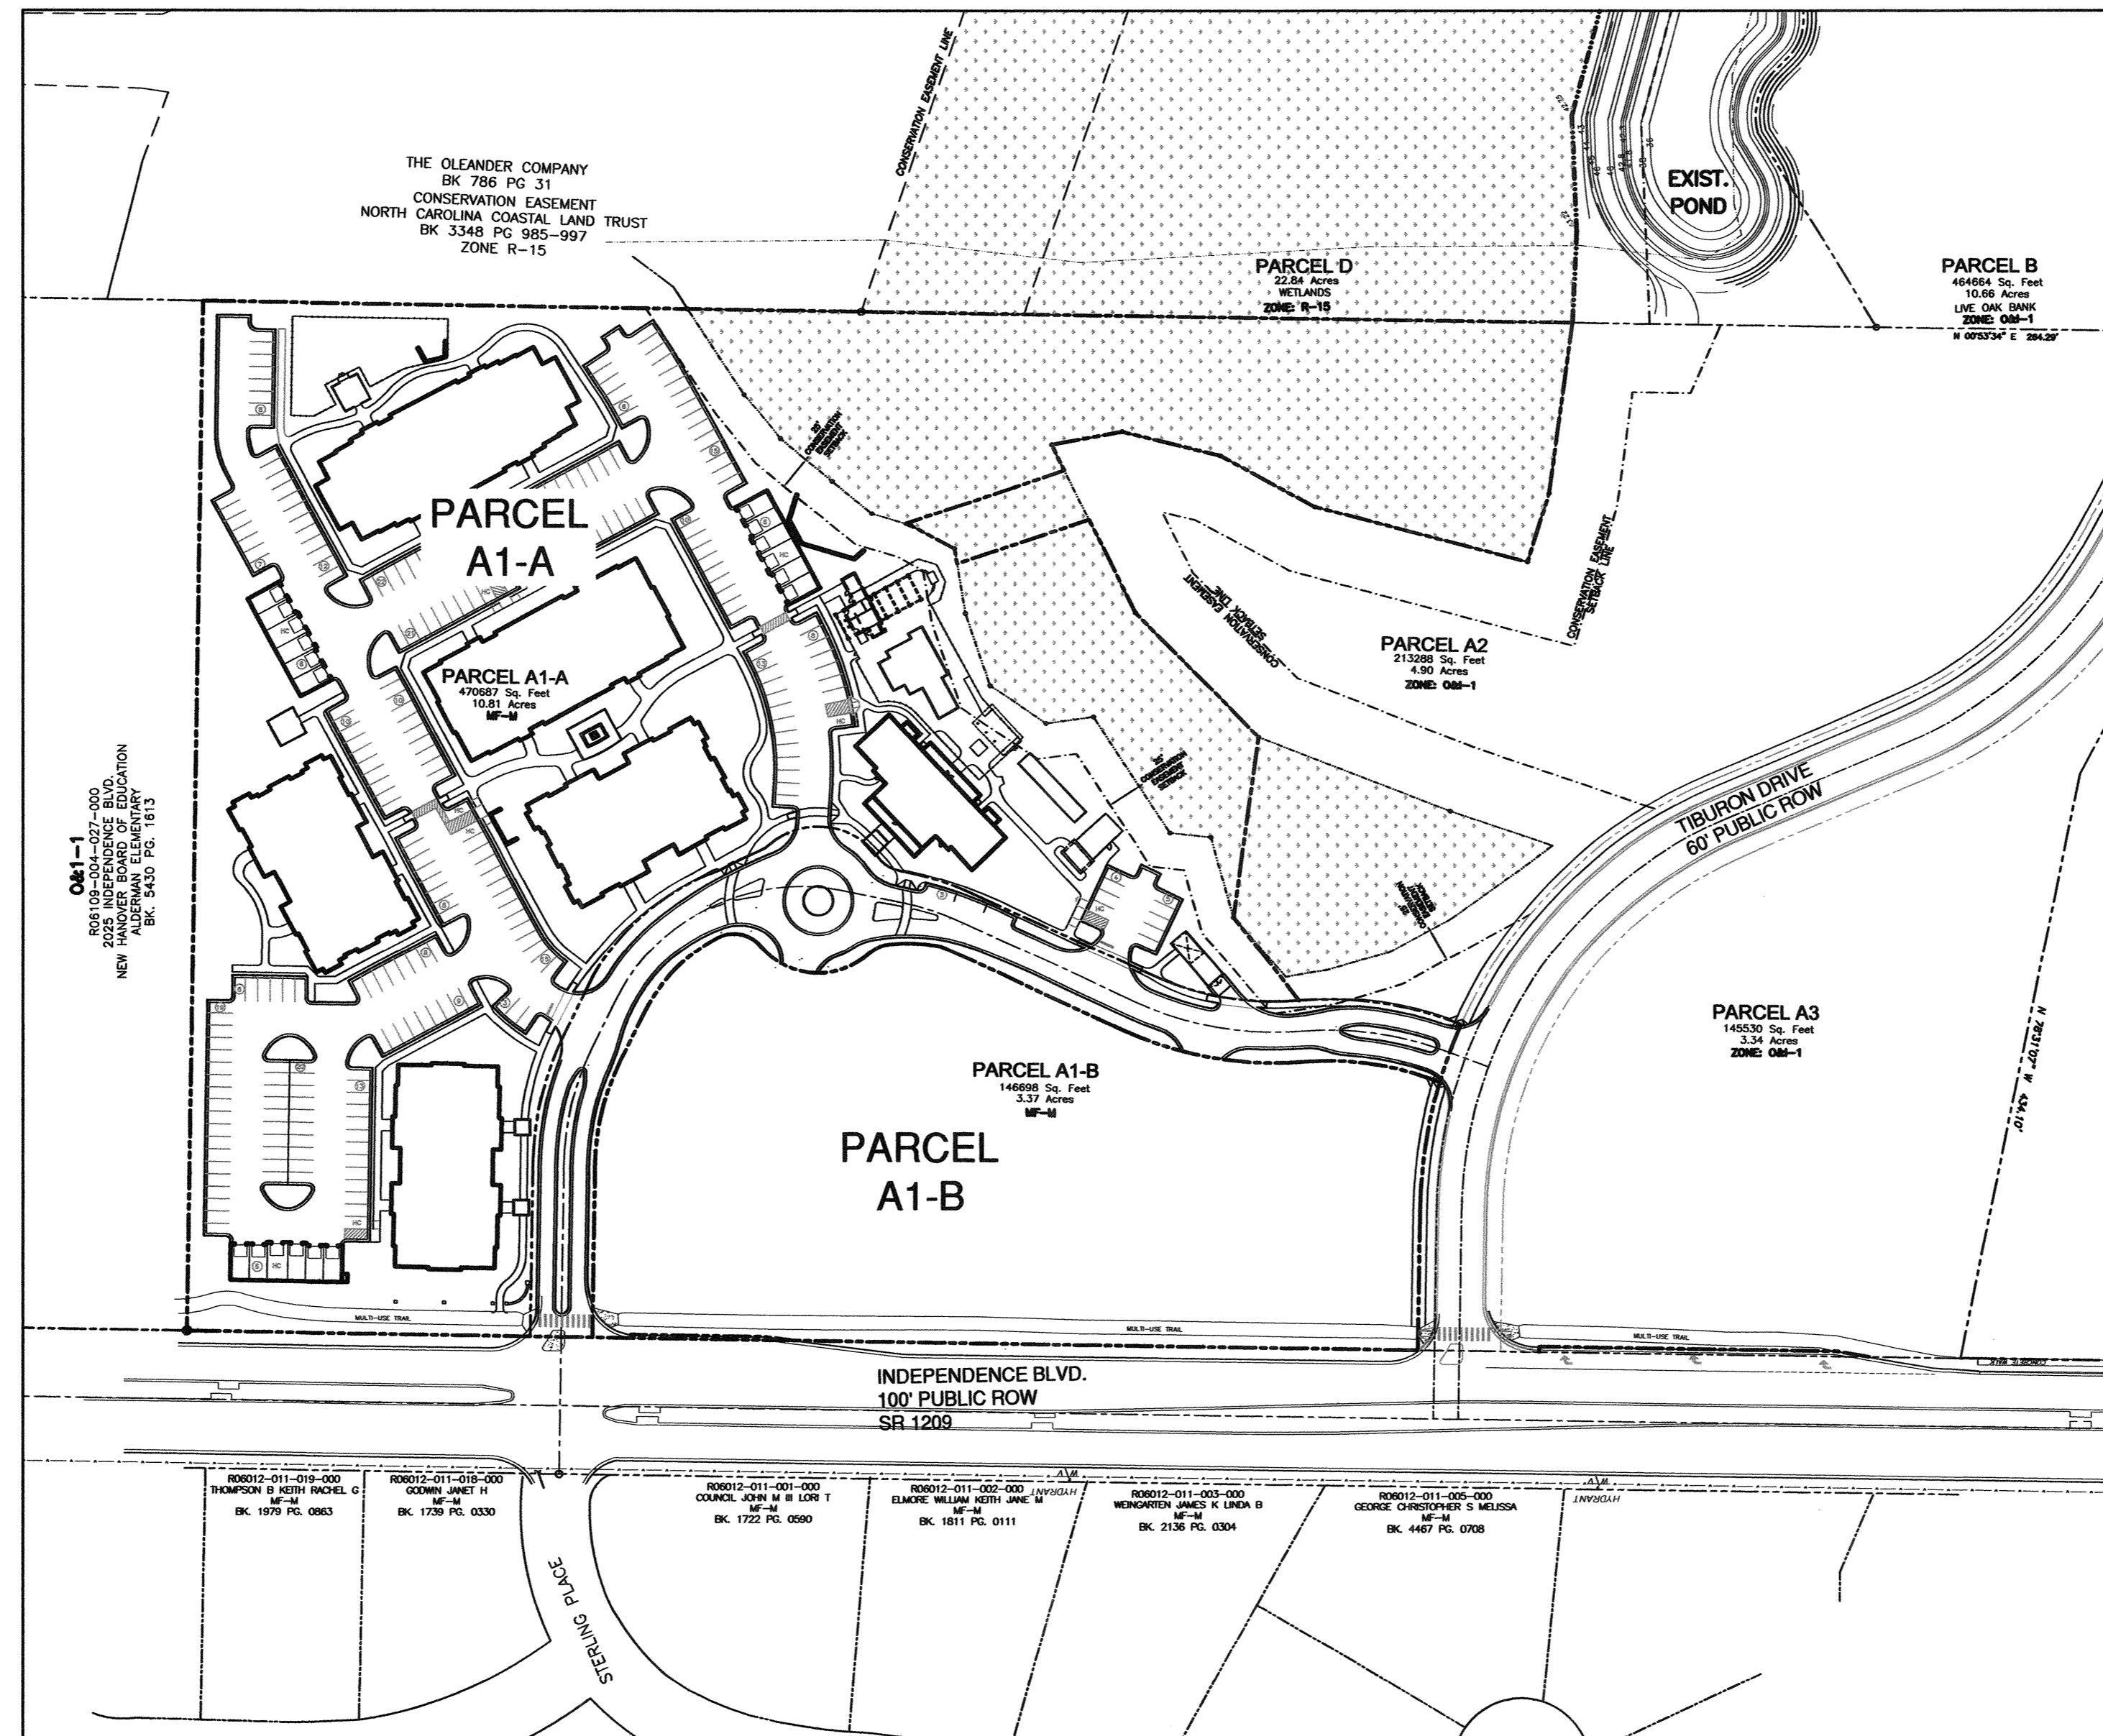- PROPERTY LINE
- CONSERVATION EASEMENT SETBACK LINE
- EXISTING WETLANDS

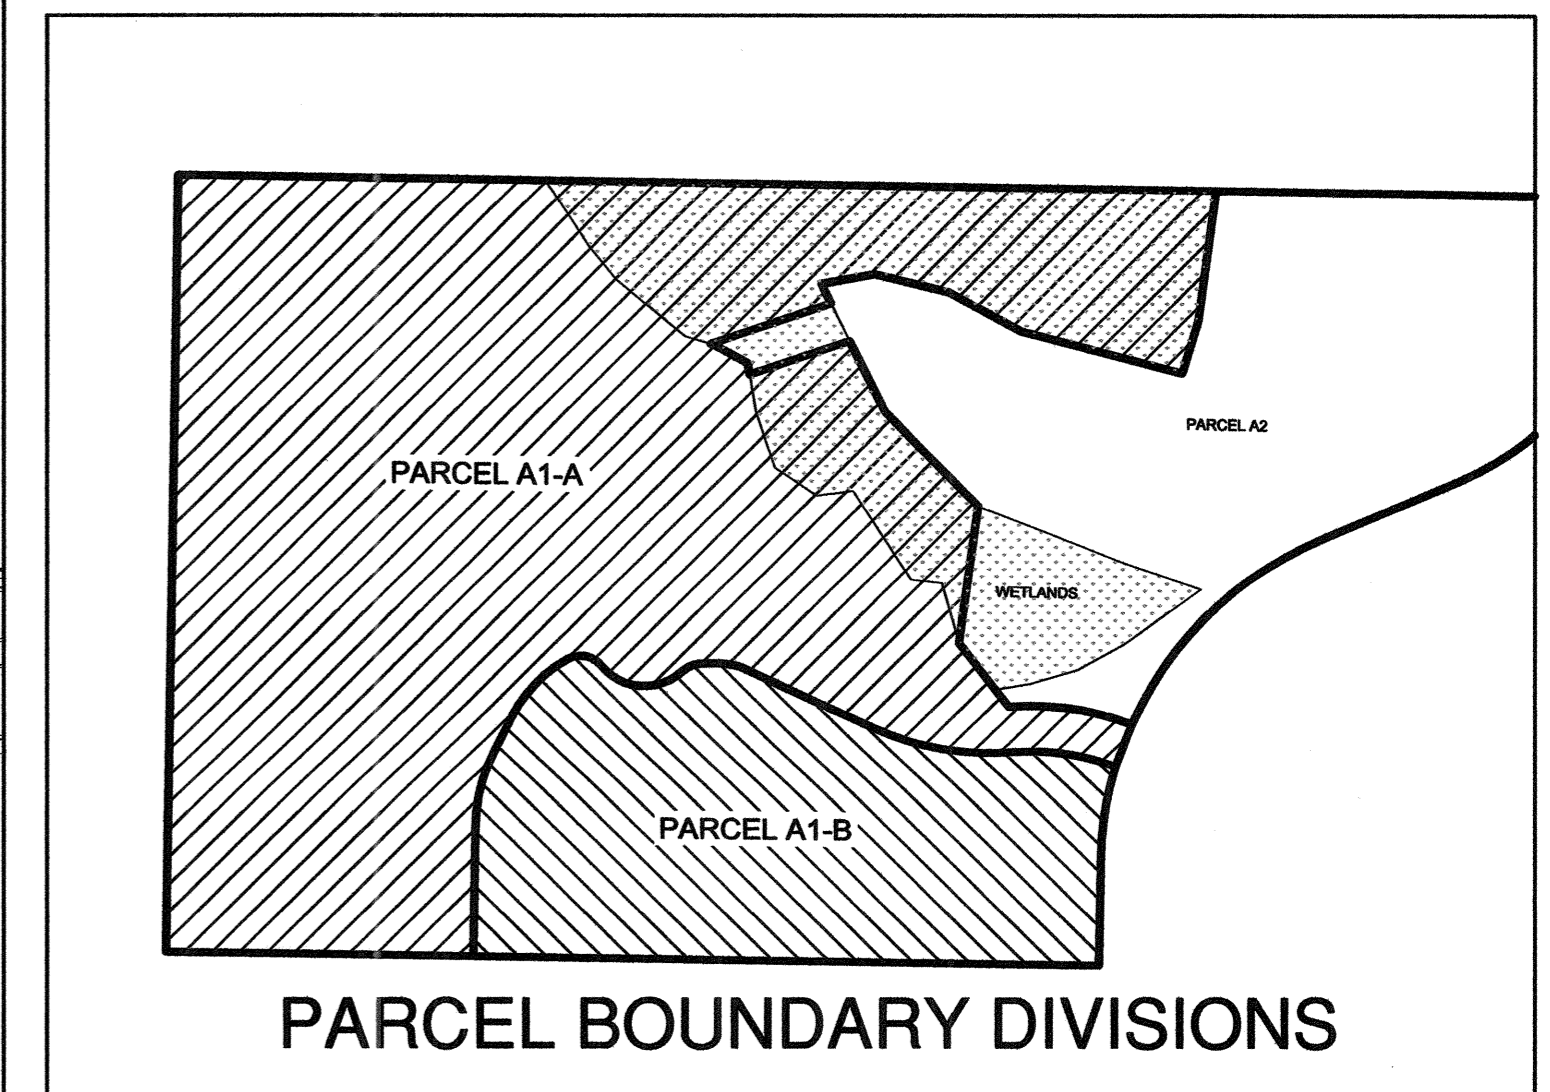

NOT TO SCALE

SCALE: 1" = 100'

OWNER/DEVELOPER

NELSON MACRAE MIDTOWN ONE, LLC
P.O. BOX 3145
WILMINGTON, N.C. 28406
910-392-3300

SURVEYOR

HANOVER DESIGN SERVICES, P.A.
1123 FLORAL PARKWAY
WILMINGTON NC 28403
910-343-8002

NORRIS & TUNSTALL

CONSULTING ENGINEERS, INC.

1127 FLORAL PARKWAY SUITES 300 & 400
WILMINGTON, NC, 28403
PHONE (910) 343-9653
FAX (910) 343-9604
office@nkteng.com
licence #C-0520

For each open utility cut of City streets, a \$325 permit shall be required from the City prior to occupancy and/or project acceptance.

NCDENR PWSS WATER PERMIT #:	_____
WATER CAPACITY:	_____ GPD
DWO SEWER PERMIT #:	_____
SEWER CAPACITY:	_____ GPD
SEWER SHED # AND PLANT:	_____
SEWER TO FLOW THROUGH NEI:	YES OR NO (CIRCLE ONE)

CITY OF WILMINGTON
NORTH CAROLINA
Public Services • Engineering Division
APPROVED STORMWATER MANAGEMENT PLAN
Date: _____ Permit # _____
Signed: _____

Approved Construction Plan
Name _____ Date _____
Planning _____
Traffic _____
Fire _____

SYMBOL	DATE	DESCRIPTION	BY
		REVISIONS	

© 2012 NORRIS & TUNSTALL

COVER SHEET
TIBURON PARC APARTMENTS
2945 MOYNET WAY
WILMINGTON, NORTH CAROLINA

OWNER:
NELSON MACRAE
MIDTOWN ONE, LLC
P.O. BOX 3145
WILMINGTON, N.C. 28406
910-392-3300


NORRIS & TUNSTALL
CONSULTING ENGINEERS, INC.
1127 FLORAL PARKWAY
SUITE 400
WILMINGTON, NC, 28403
PHONE (910) 343-9653
FAX (910) 343-9604
office@nkteng.com
licence #C-0520

HUD/PERMIT SET

12073

DES. JST
CHK. JPN
DRWN. NKS


DATE 5/2/13

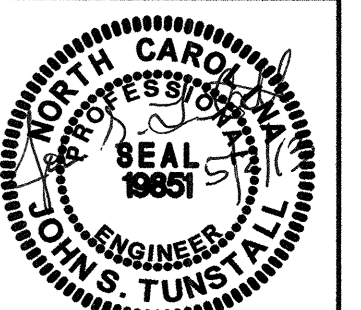


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TIBURON PARC APARTMENTS


WILMINGTON, NC
NEW HANOVER COUNTY

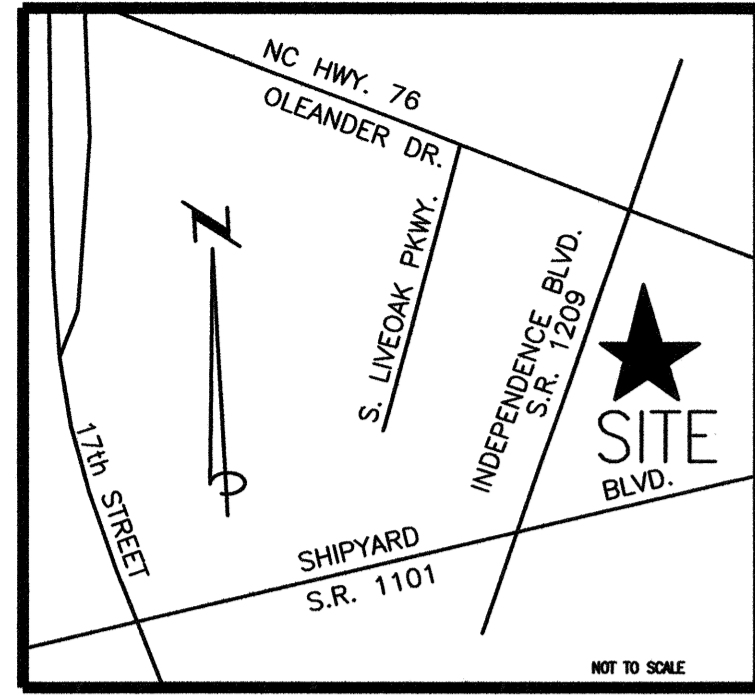

LOCATION MAP

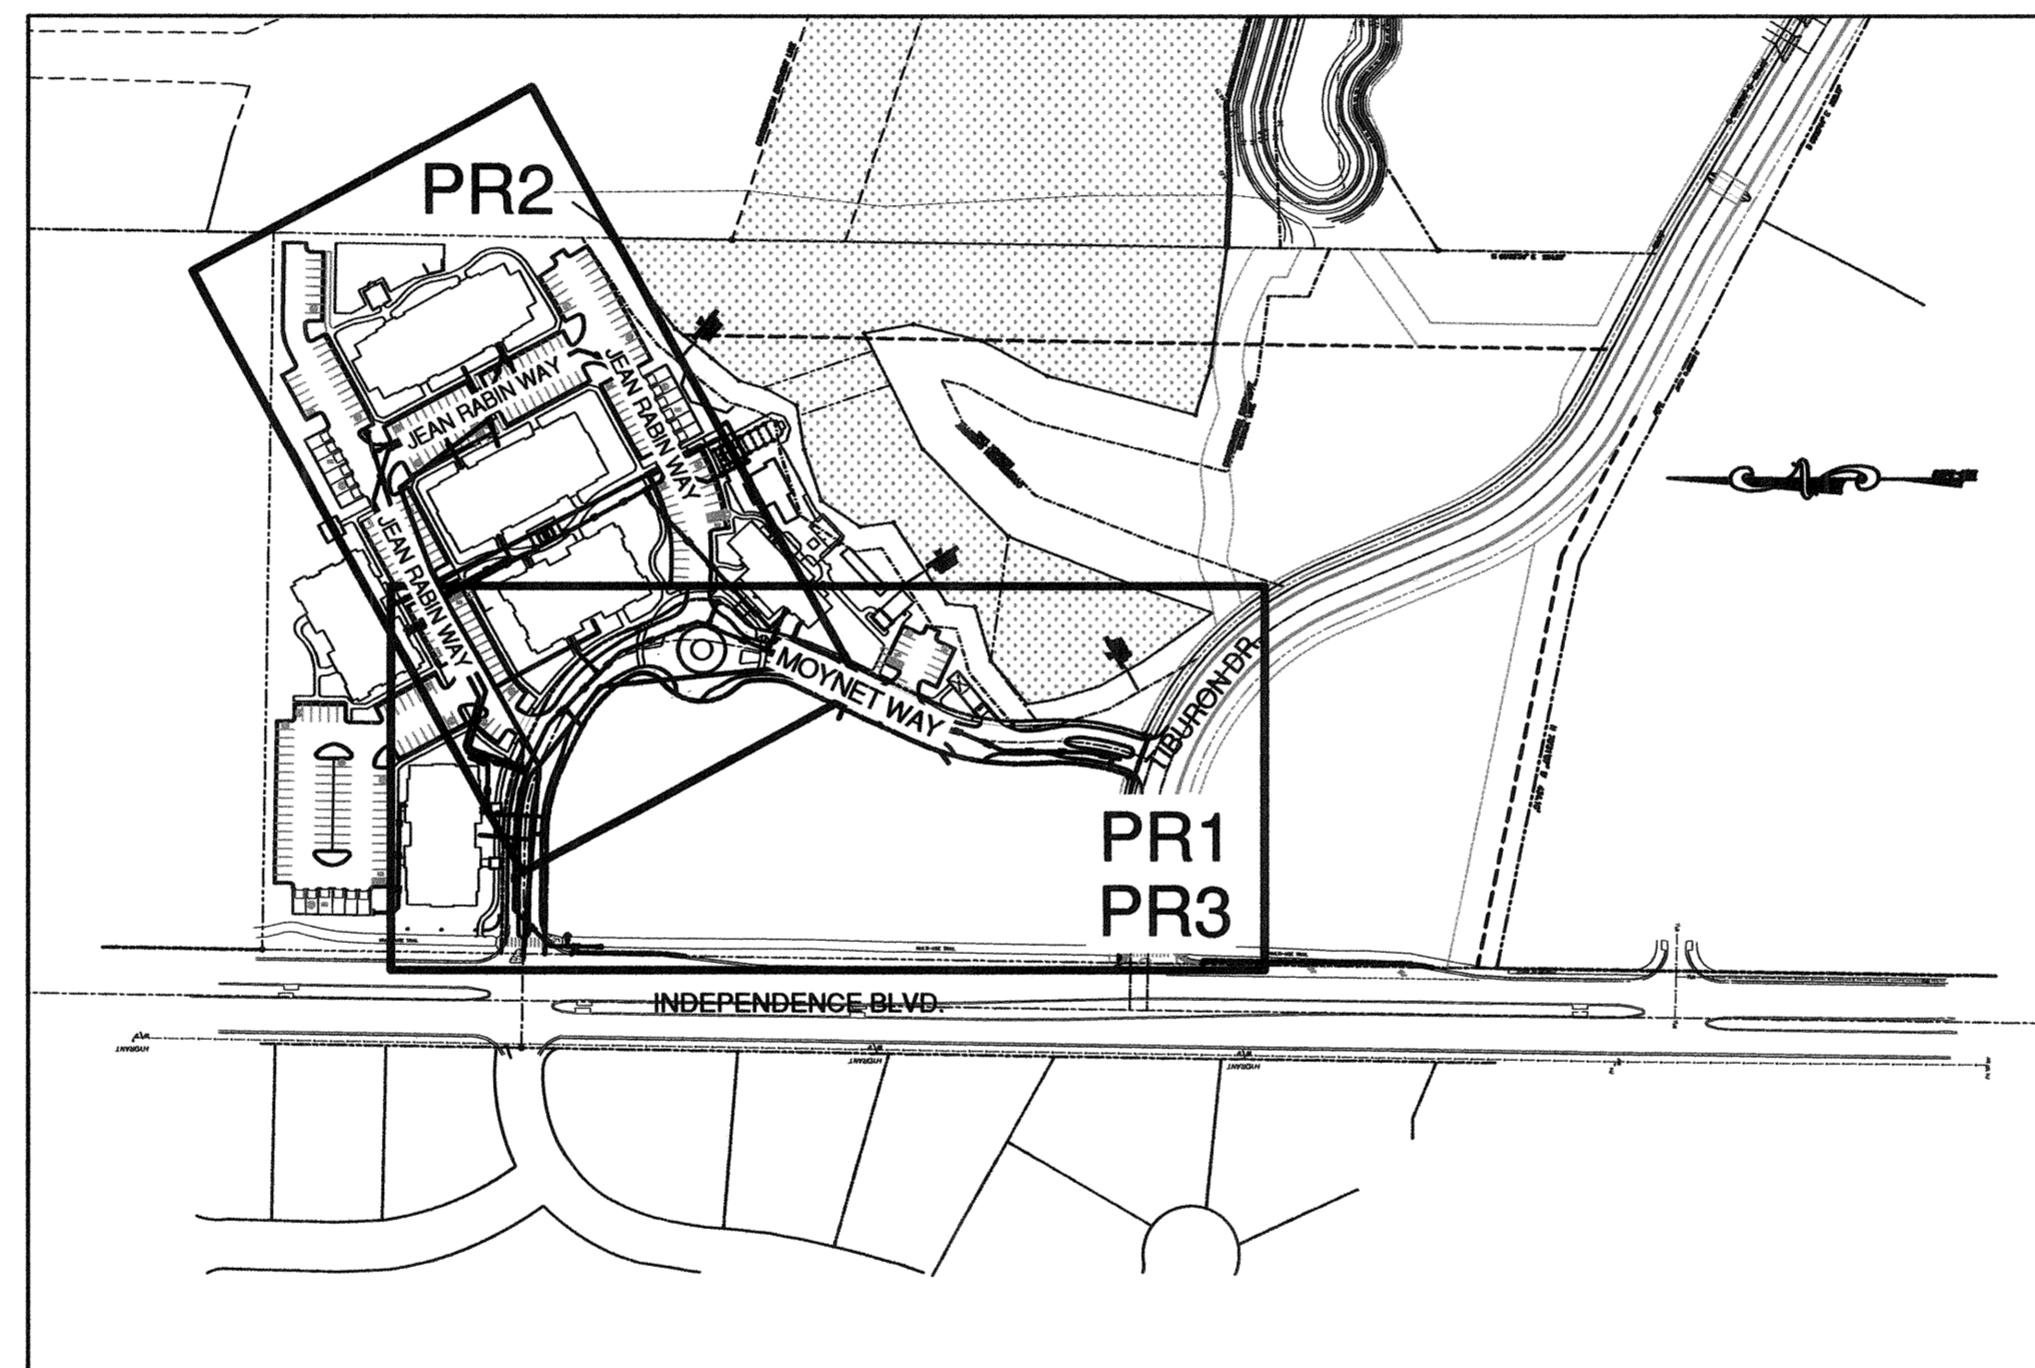

SCALE: 1" = 200'

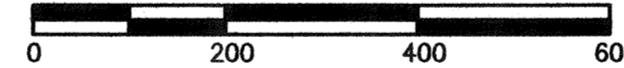

LEGEND

	PROPERTY LINE
	CONSERVATION EASEMENT
	SETBACK LINE
	EASEMENT LINE
	BUFFER LINE
	EXISTING TREE TO BE SAVED
	EXISTING WETLANDS
	PROPOSED STORMDRAIN PIPE
	PROPOSED WATERLINE SIZE VARIES SEE PLAN
	PROPOSED SANITARY SEWER
	PROPOSED FIRE HYDRANT

INDEX OF SHEETS

COVER SHEET	
PR1:	SS PLAN AND PROFILE LINE 1 MOYNET WAY
PR2:	SS PLAN AND PROFILE LINE 2 AND 3 JEAN RABIN WAY
PR3:	WATER LINE PLAN AND PROFILE MOYNET WAY
PR4:	WATER/STORM CROSSINGS PROFILES
SD-1:	CFPUA WATER MAIN CONSTRUCTION DETAILS (1 OF 2)
SD-1:	CFPUA WATER MAIN CONSTRUCTION DETAILS (2 OF 2)
SD-3:	CFPUA SANITARY SEWER STANDARD DETAILS (1 OF 3)
SD-3:	CFPUA SANITARY SEWER STANDARD DETAILS (2 OF 3)

OWNER/DEVELOPER

NELSON MACRAE
MIDTOWN ONE, LLC
P.O. BOX 3145
WILMINGTON, N.C. 28406
910-392-3300

SURVEYOR

HANOVER DESIGN SERVICES, P.A.
1123 FLORAL PARKWAY
WILMINGTON NC 28403
910-343-8002

NORRIS & TUNSTALL


CONSULTING ENGINEERS, INC.

1127 FLORAL PARKWAY
SUITES 300 & 400
WILMINGTON, NC, 28403
PHONE (910) 343-9653
FAX (910) 343-9604
office@nkteng.com
licence #C-0520

For each open utility cut of City streets, a \$325 permit shall be required from the City prior to occupancy and/or project acceptance.

NCDENR PWSS WATER PERMIT #:	_____
WATER CAPACITY:	_____ GPD
DWQ SEWER PERMIT #:	_____
SEWER CAPACITY:	_____ GPD
SEWER SHED # AND PLANT:	_____
SEWER TO FLOW THROUGH NEI:	YES or NO (CIRCLE ONE)

Approved Construction Plan	
Name	Date
Planning	_____
Traffic	_____
Fire	_____

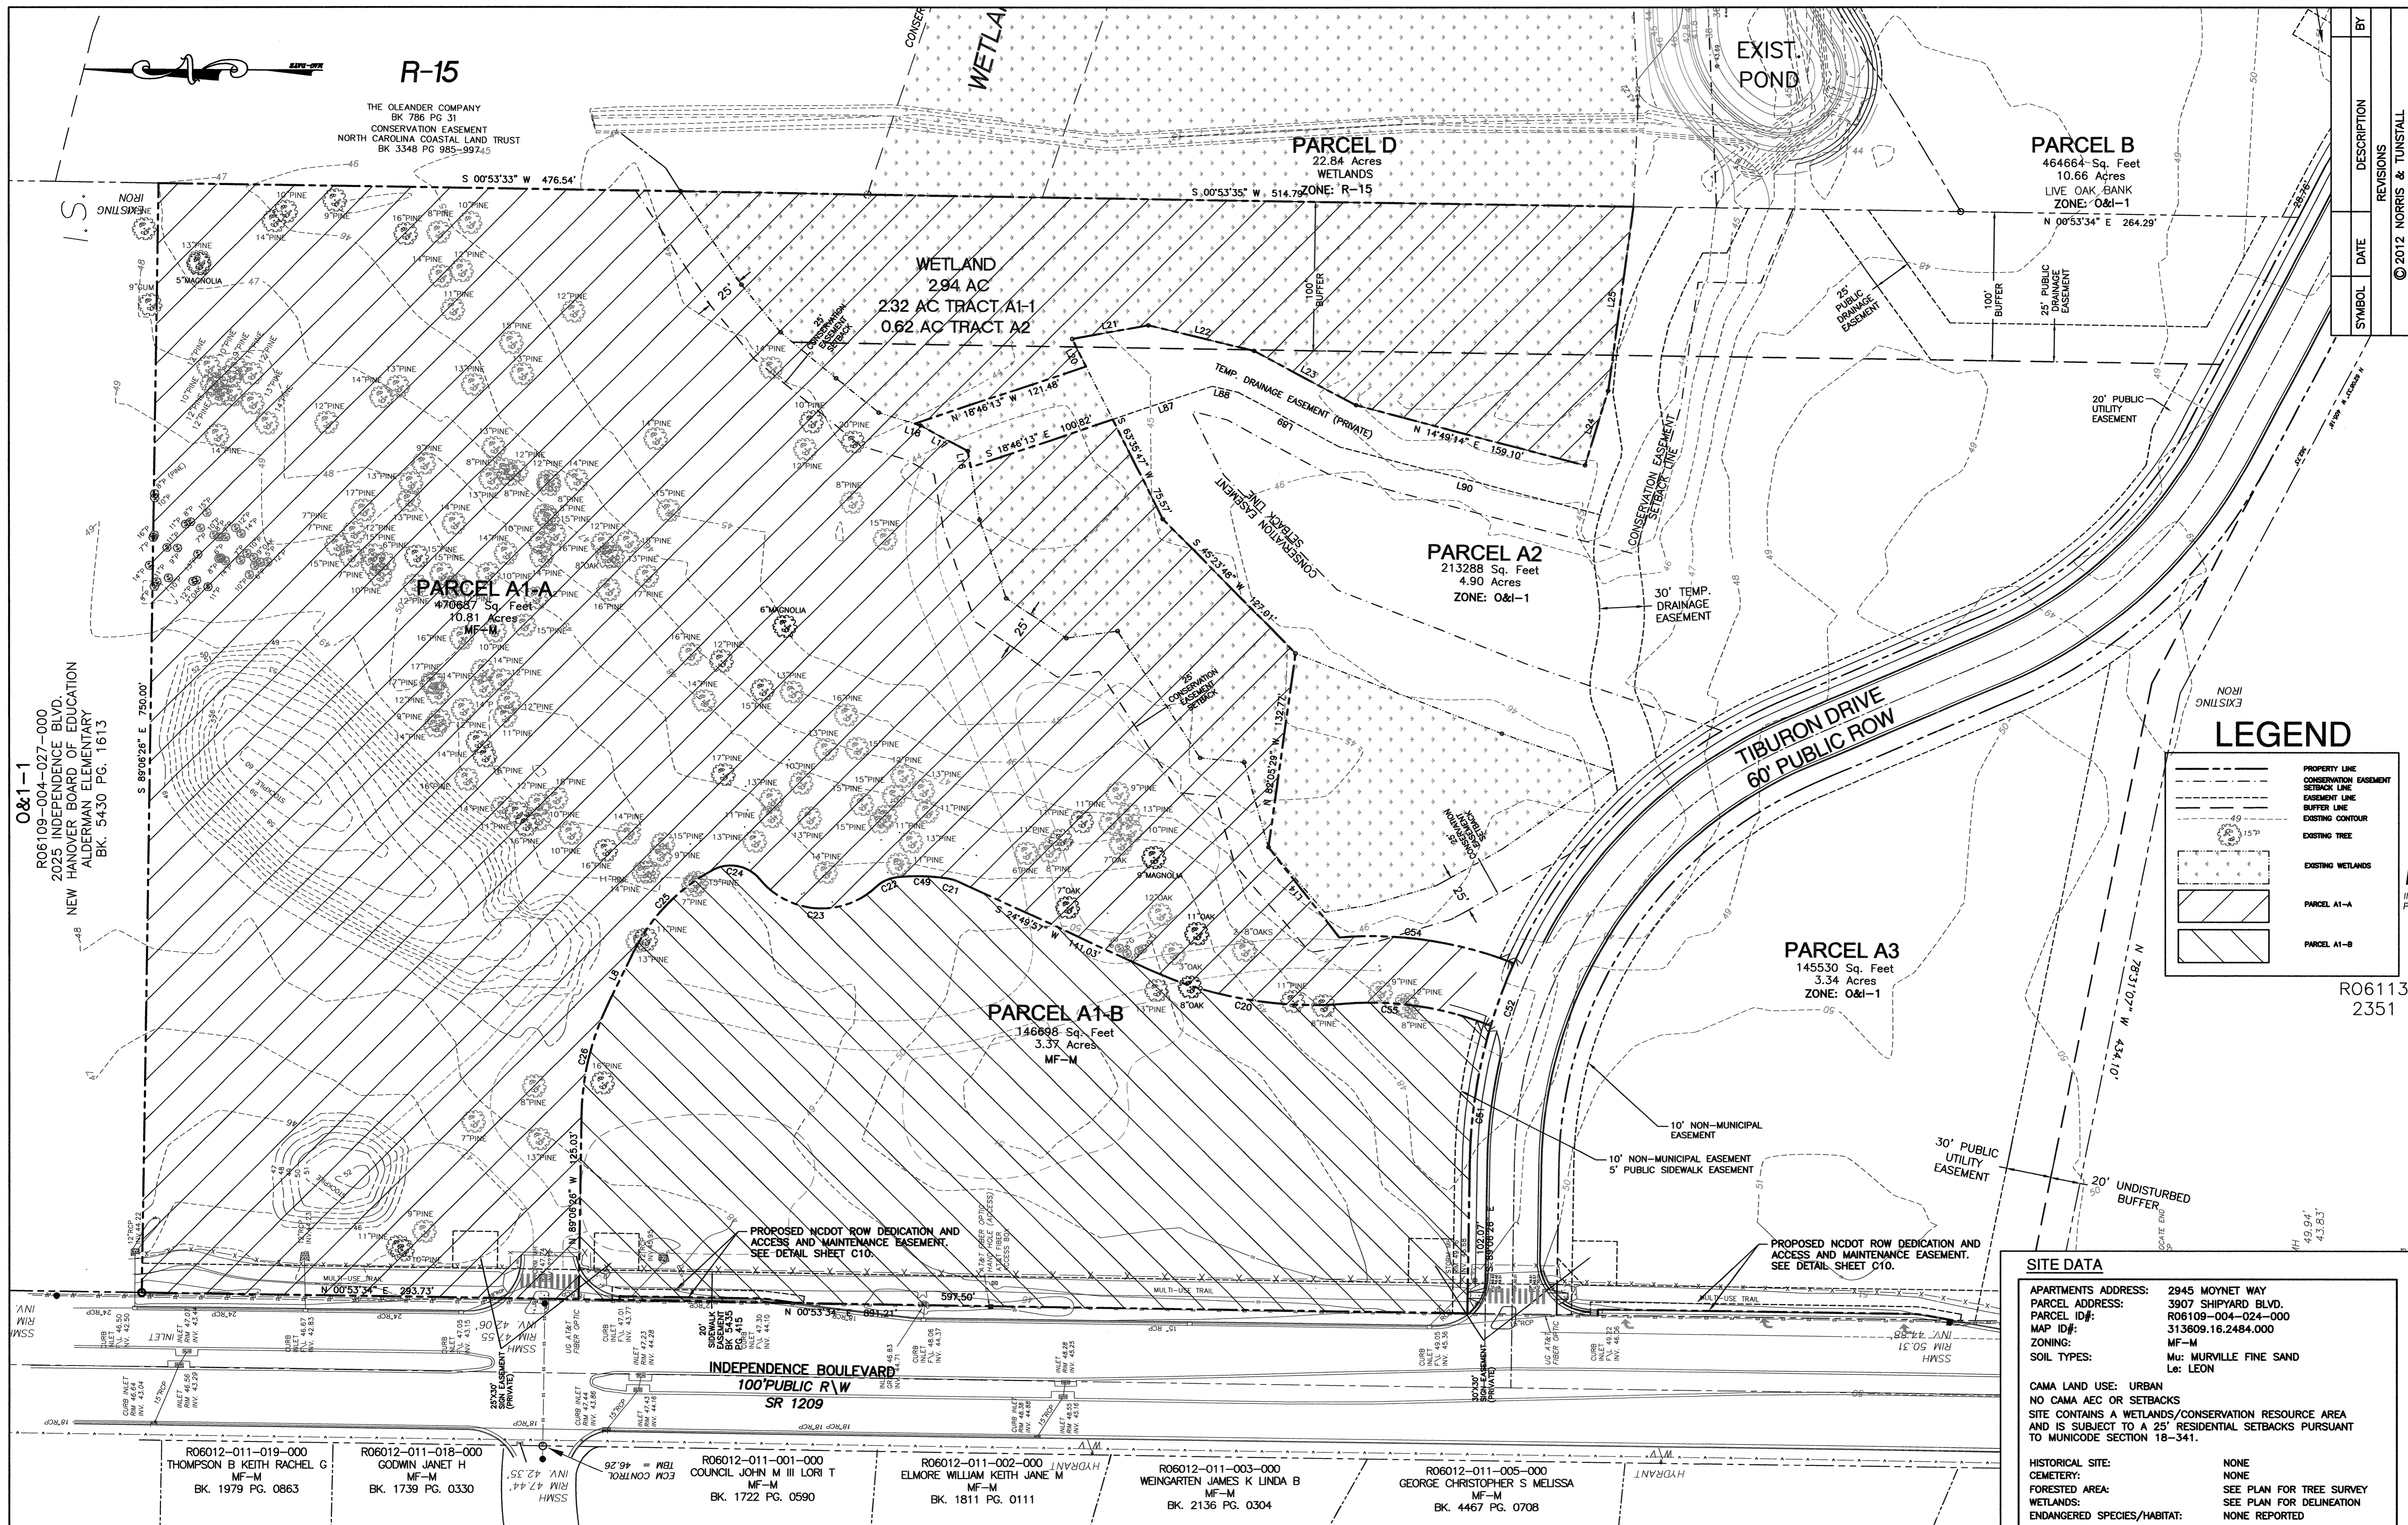

APARTMENTS ADDRESS: 2945 MOYNET WAY
PARCEL ADDRESS: 3907 SHIPYARD BLVD.
PARCEL ID#: R06109-004-024-000
MAP ID#: 313609.16.2484.000
ZONING: MF-M
SOIL TYPES: Mu: MURVILLE FINE SAND
 Le: LEON

CAMA LAND USE: URBAN
 NO CAMA AEC OR SETBACKS
 SITE CONTAINS A WETLANDS/CONSERVATION RESOURCE AREA
 AND IS SUBJECT TO A 25' RESIDENTIAL SETBACKS PURSUANT
 TO MUNICOD SECTION 18-341.

HISTORICAL SITE:
 CEMETERY: NONE
 FORESTED AREA: NONE
 WETLANDS: SEE PLAN FOR DELINEATION
 ENDANGERED SPECIES/HABITAT: NONE REPORTED

APPROVED CONSTRUCTION PLAN

Name: _____ Date: _____

Planning: _____

Traffic: _____

Fire: _____

For each open utility cut of City streets, a \$325 permit shall be required from the City prior to occupancy and/or project acceptance.

SURVEYOR:
 TOPOGRAPHIC SURVEY & COMPOST MAP BY:
 HANOVER DESIGN SERVICES, P.A.
 LAND SURVEYORS ENGINEERS LAND PLANNERS

319 WALNUT STREET
 WILMINGTON, N.C. 28401
 PHONE: 910 343-9022
 FAX: 910 343-9041

APPLICANT/PREPARER OF PLAN:
 NORRIS & TUNSTALL CONSULTING ENGINEERS, INC.
 1127 FLORAL PARKWAY
 SUITE 300/400
 WILMINGTON, NC, 28403
 PHONE (910) 343-9653
 (910) 343-9604 FAX
 LICENCE #C-3641

OWNER:
 NELSON MACRAE
 MIDDOWN ONE, LLC
 P.O. BOX 3145
 WILMINGTON, N.C. 28406
 910-392-3300

SCALE: 1" = 50'

INVENTORY SITE PLAN

TIBURON PARC APARTMENTS
 2945 MOYNET WAY
 WILMINGTON, NORTH CAROLINA

OWNER:
 NELSON MACRAE
 MIDDOWN ONE, LLC
 P.O. BOX 3145
 WILMINGTON, N.C. 28406
 910-392-3300

NORRIS & TUNSTALL
 CONSULTING ENGINEERS, INC.
 1127 FLORAL PARKWAY
 SUITE 400
 WILMINGTON, NC, 28403

HUD/PERMIT SET

12073

DES. JST
 CKD. JPN
 DRWN. NKS

DATE: 5/2/13

11




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For each open utility cut of City streets, a \$325 permit shall be required from the City prior to occupancy and/or project acceptance.

Approved Construction Plan

Name _____ Date _____
 Planning _____
 Traffic _____
 Fire _____

NCDENR PWSS WATER PERMIT #: _____
 WATER CAPACITY: _____ GPD
 DWQ SEWER PERMIT #: _____
 SEWER CAPACITY: _____ GPD
 SEWER SHED # AND PLANT: _____
 SEWER TO FLOW THROUGH NEI: YES or NO (CIRCLE ONE)

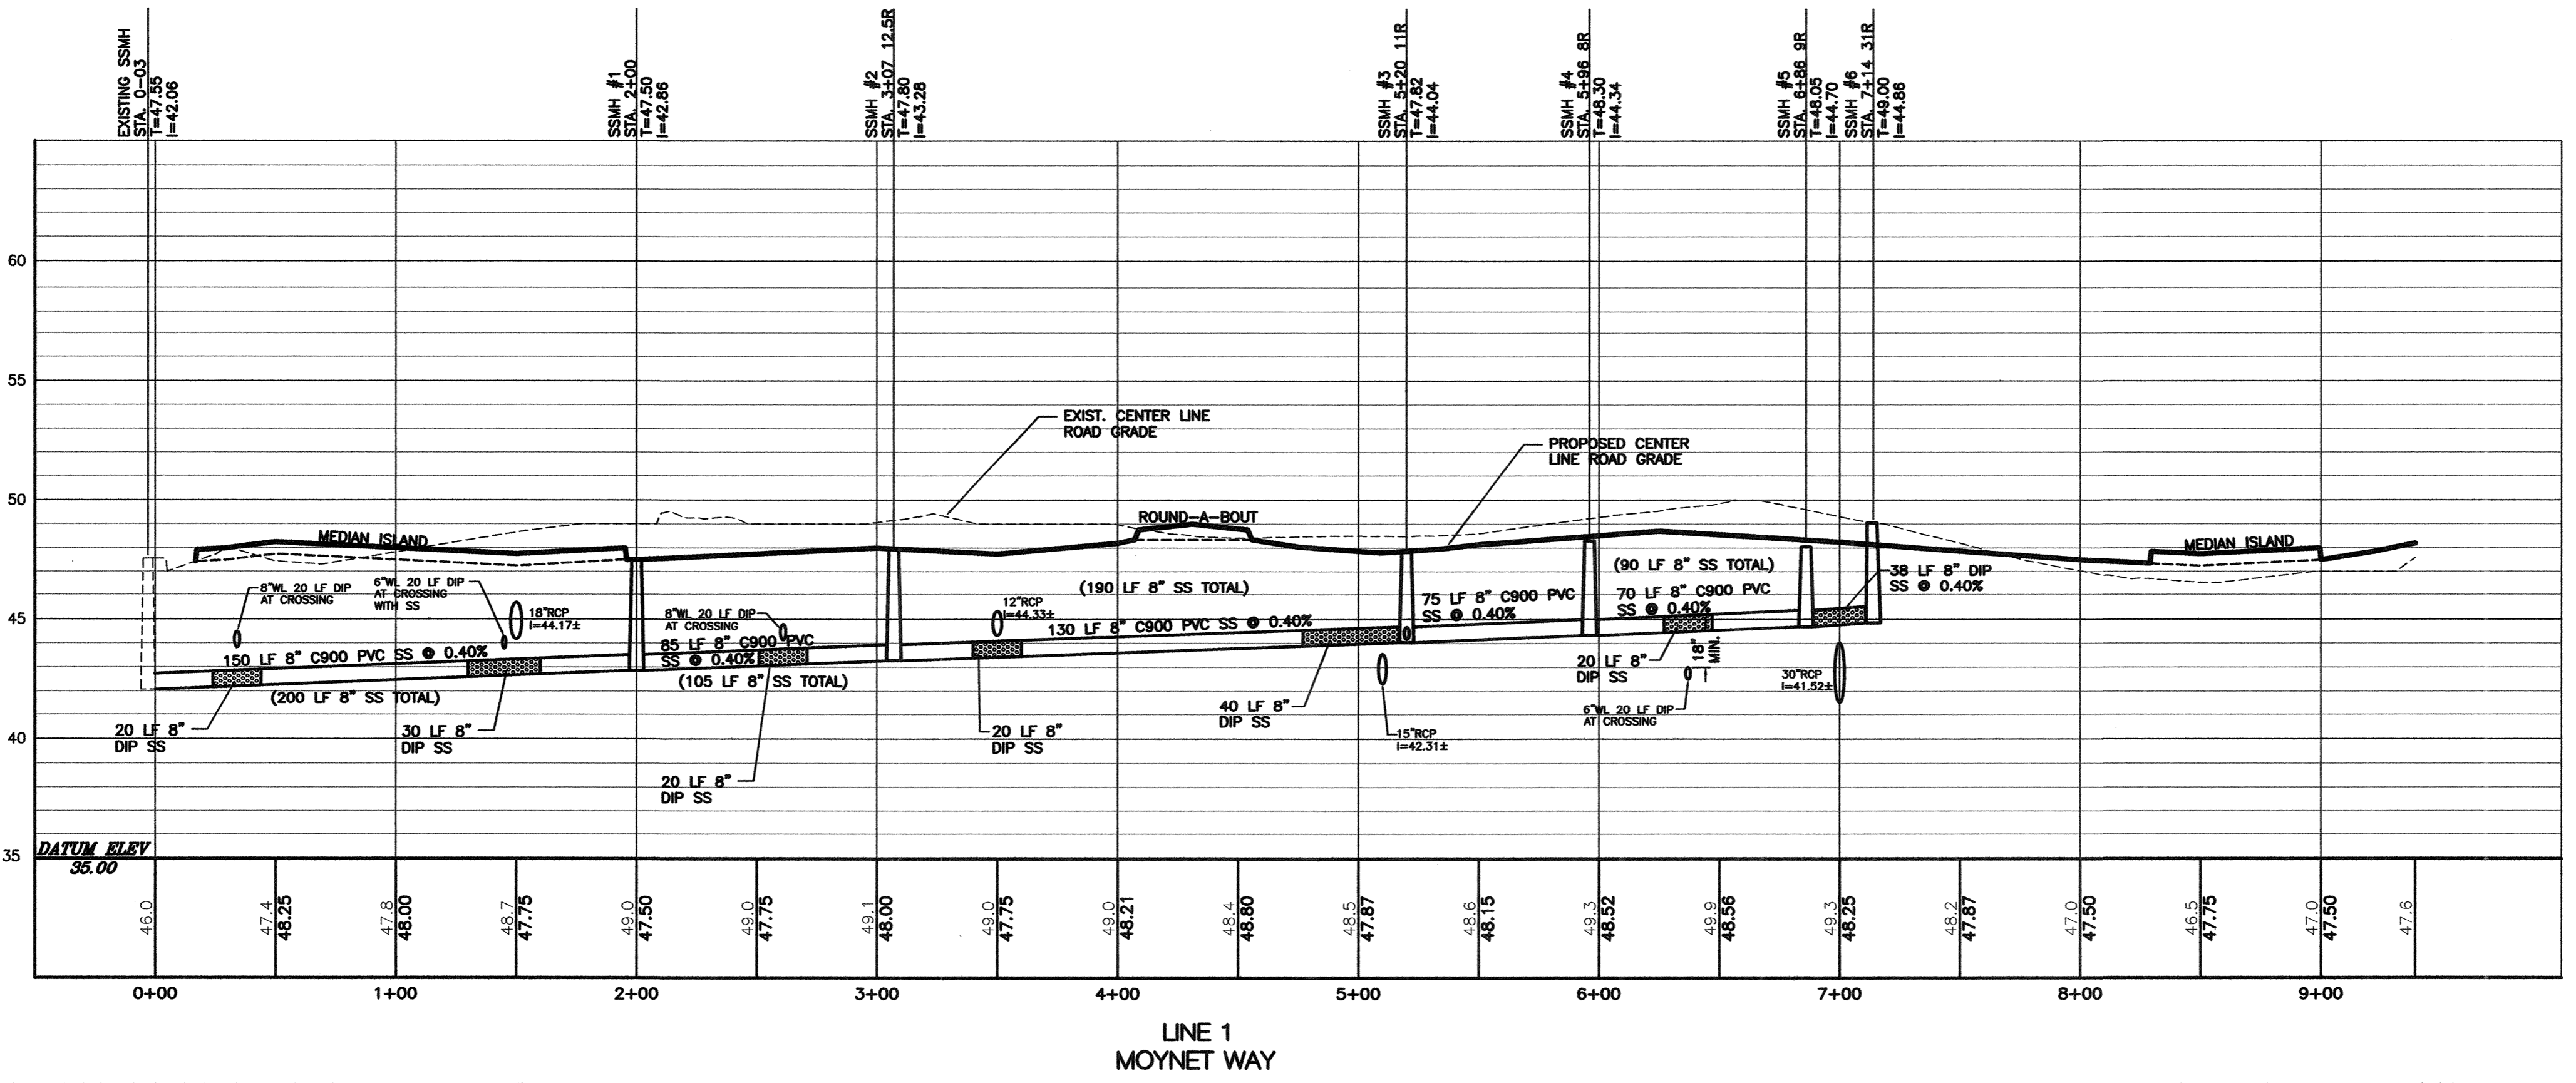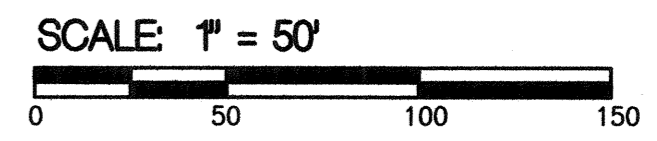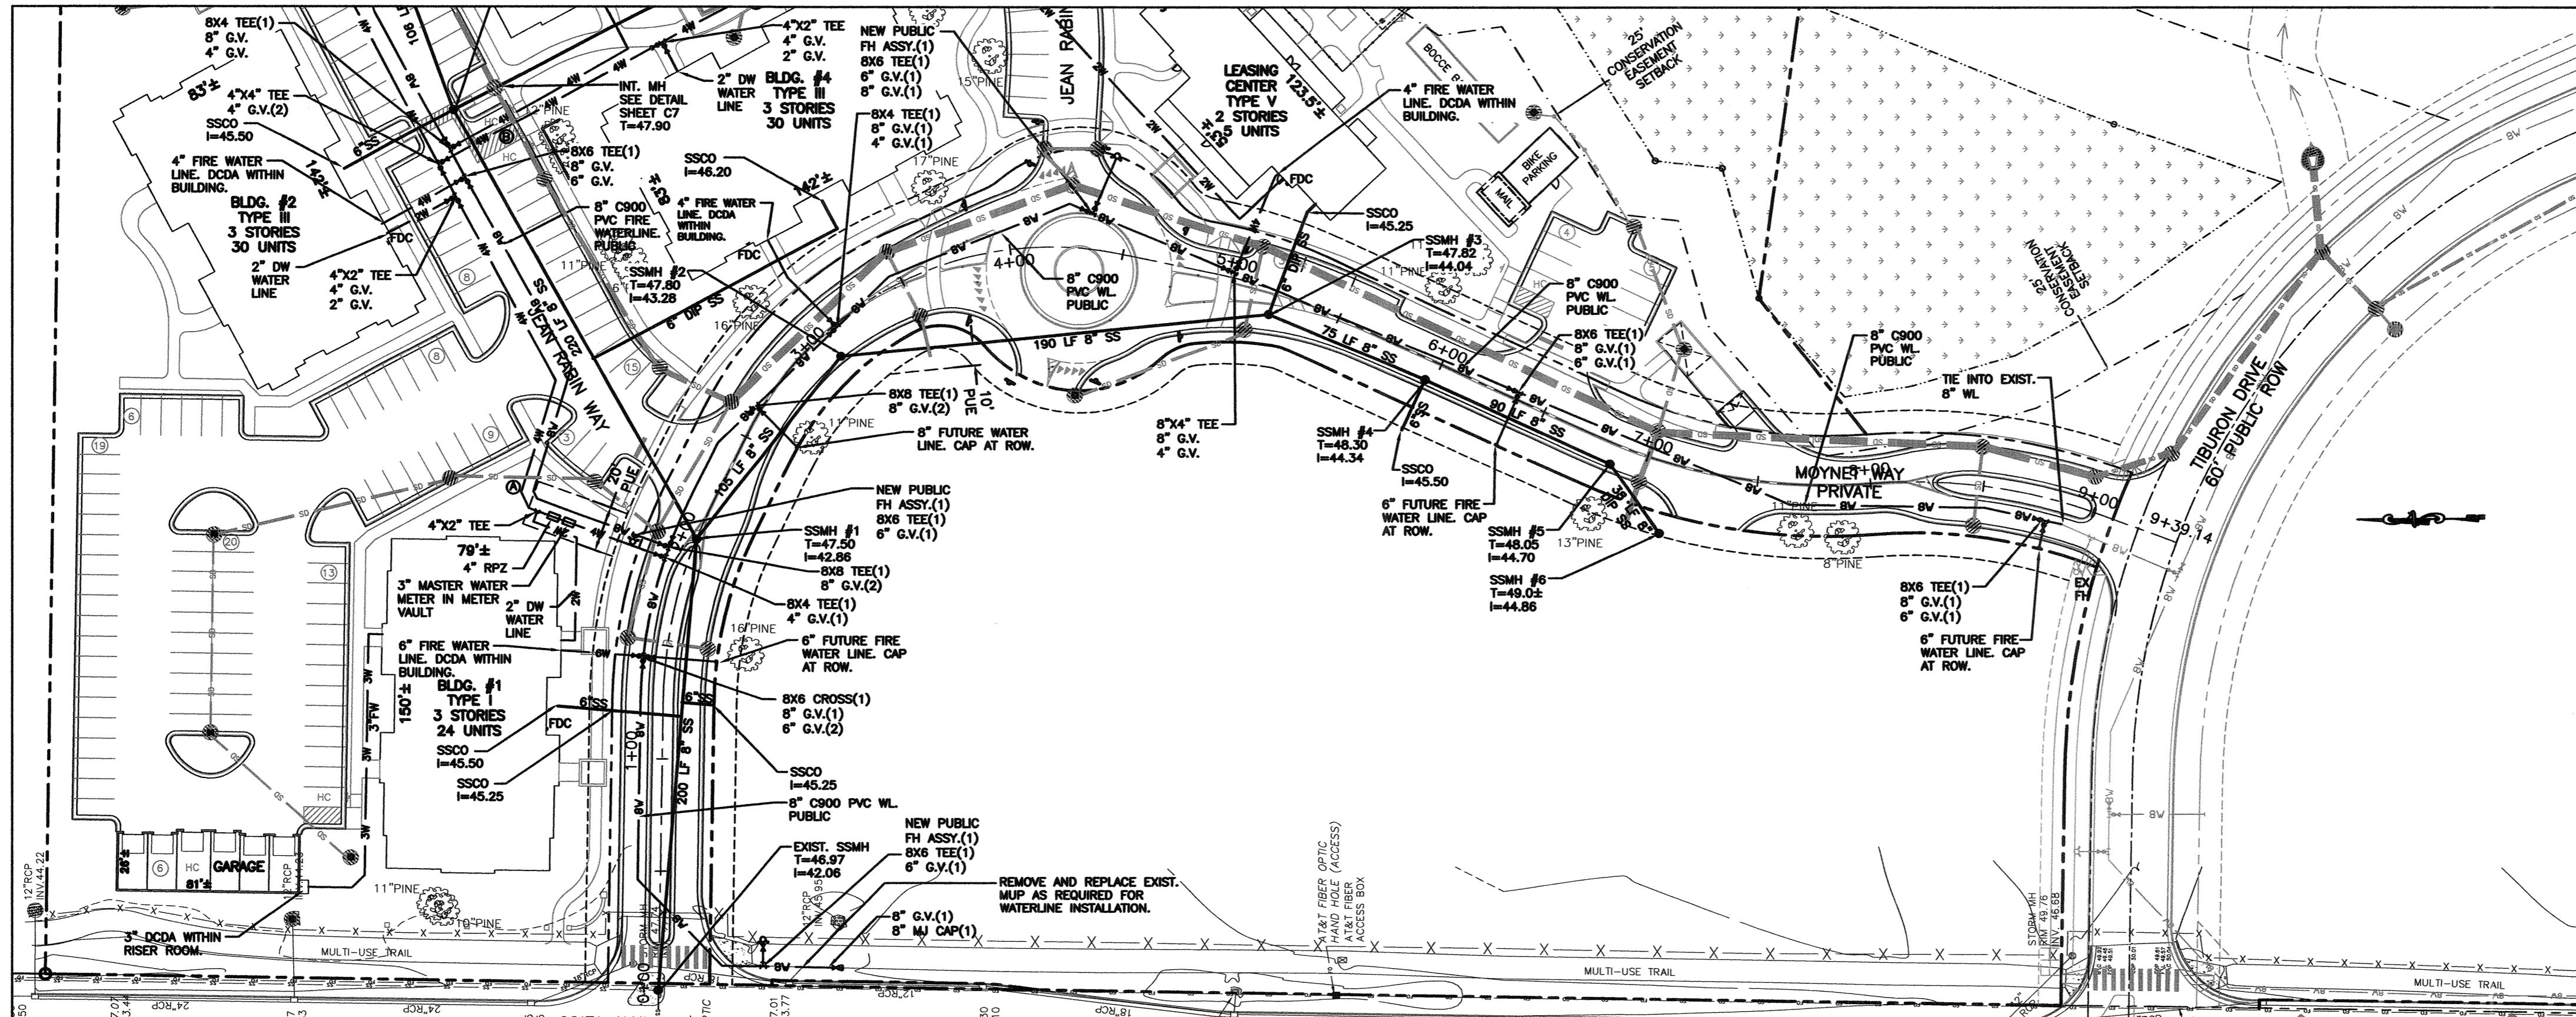


- UTILITY NOTES:**
- LATERAL SEPARATION OF SEWERS AND WATER MAINS. WATER MAINS SHALL BE LAID AT LEAST TO FEET LATERALLY FROM EXISTING OR PROPOSED SEWERS, UNLESS LOCAL CONDITIONS OR BARRIERS PREVENT A 10 FOOT LATERAL SEPARATION-IN WHICH CASE:
 - THE WATER MAIN IS LAID IN A SEPARATE TRENCH, WITH THE ELEVATION OF THE BOTTOM OF THE WATER MAIN AT LEAST 18 INCHES ABOVE THE TOP OF THE SEWER, OR
 - THE WATER MAIN IS LAID IN THE SAME TRENCH AS THE SEWER WITH THE WATER MAIN LOCATED AT ONE SIDE ON A BENCH OF UNDISTURBED EARTH, AND WITH THE ELEVATION OF THE BOTTOM OF THE WATER MAIN AT LEAST 18 INCHES ABOVE THE TOP OF THE SEWER.
 - CROSSING A WATER MAIN OVER A SEWER. WHENEVER IT IS NECESSARY FOR A WATER MAIN TO CROSS OVER A SEWER, THE WATER MAIN SHALL BE LAID AT SUCH AN ELEVATION THAT THE BOTTOM OF THE WATER MAIN IS AT LEAST 18 INCHES ABOVE THE TOP OF THE SEWER, UNLESS LOCAL CONDITIONS OR BARRIERS PREVENT AN 18 INCH VERTICAL SEPARATION-IN WHICH CASE BOTH THE WATER MAIN AND THE SEWER SHALL BE CONSTRUCTED OF FERROUS MATERIALS AND WITH JOINTS THAT ARE EQUIVALENT TO WATER MAIN STANDARDS FOR A DISTANCE OF 10 FEET ON EACH SIDE OF THE POINT OF CROSSING.
 - CROSSING A WATER MAIN UNDER A SEWER. WHENEVER IT IS NECESSARY FOR A WATER MAIN TO CROSS UNDER A SEWER, BOTH THE WATER MAIN AND THE SEWER SHALL BE CONSTRUCTED OF FERROUS MATERIALS AND WITH JOINTS EQUIVALENT TO WATER MAIN STANDARDS FOR A DISTANCE OF 10 FEET ON EACH SIDE OF THE POINT OF CROSSING.
 - MAINTAIN A 24" MINIMUM SEPARATION BETWEEN THE PROPOSED OR EXISTING STORM DRAIN AND THE PROPOSED OR EXISTING WATER LINE OR SEWER LINE. SEE DETAILS.
 - RESTRAINING/BLOCKING: THE PLUGS, CAPS, TEES AND BENDS DEFLECTING 22-1/2 DEGREES OR MORE EITHER VERTICALLY OR HORIZONTALLY ON WATER LINES 6 INCHES IN DIAMETER OF LARGER SHALL BE PROVIDED WITH THRUST BLOCKING OF "MEGALUG" RETAINER GLAND AT EACH JOINT, INSTALLED PER MANUFACTURER'S REQUIREMENTS.
 - FOR STORMDRAIN PIPES 24" AND LARGER, WHEN THE STORMDRAIN PIPE IS OVER GRAVITY SEWER OR WATERLINE WITH LESS THAN 18" SEPARATION, STRUCTURAL BRIDGING MUST BE INSTALLED. SEE CFPWA DETAIL.

- CFPWA STANDARD NOTES:**
- SEWER GUARDS REQUIRED AT ALL MANHOLES. STAINLESS STEEL SEWER GUARDS REQUIRED AT MANHOLES LOCATED IN TRAFFIC AREAS.
 - WELLS IN CONFLICT ARE TO BE RELOCATED.
 - SERVICES SHALL BE PERPENDICULAR TO MAIN AND TERMINATE AT RIGHT OF WAY LINE. SERVICES IN CUL-DE-SAC ARE REQUIRED TO BE PERPENDICULAR, OR MUST ORIGINATE IN MANHOLE AND TERMINATE AT RIGHT OF WAY LINE.
 - ALL SERVICES TYING INTO DUCTILE IRON MAINS SHALL BE CONSTRUCTED OF CLASS 50, D.I.P. 401 PROTECTO CERAMIC LINED.
 - 10' UTILITIES EASEMENT IS PROVIDED ALONG THE FRONTAGE OF ALL LOTS AND AS SHOWN.
 - NO FLEXIBLE COUPLINGS SHALL BE USED.

HORIZ. 1" = 50'
 VERT. 1" = 8'

REV. NO.	DESCRIPTION	DATE

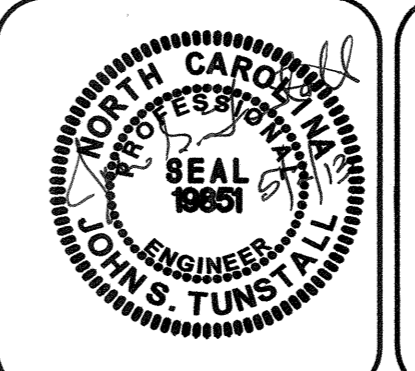

NORRIS & TUNSTALL
CONSULTING ENGINEERS, INC.
 1127 FLORAL PARWAY PHONE (910) 343-9853
 SUITES 305 & 400 FAX (910) 343-9904
 WILMINGTON, NC 28403 LICENSE EC-3550

DATE: 5/2/13
 SCALE: 1" = 50'
 1" = 5'
 DRAWN: NKS
 CHECKED: JST
 PROJECT NO: 12073

SHEET NO:
PR1

SANITARY SEWER PLAN AND PROFILE
TIBURON PARC APARTMENTS
 2945 MOYNET WAY
 WILMINGTON, N. C.

For each open utility cut of City streets, a \$325 permit shall be required from the City prior to occupancy and/or project acceptance.

Approved Construction Plan

Name _____ Date _____

Planning _____

Traffic _____

Fire _____

NCDENR PWSS WATER PERMIT #: _____


WATER CAPACITY: _____ GPD

DWQ SEWER PERMIT #: _____

SEWER CAPACITY: _____ GPD



SEWER SHED # AND PLANT: _____

SEWER TO FLOW THROUGH NEI: YES or NO (CIRCLE ONE)

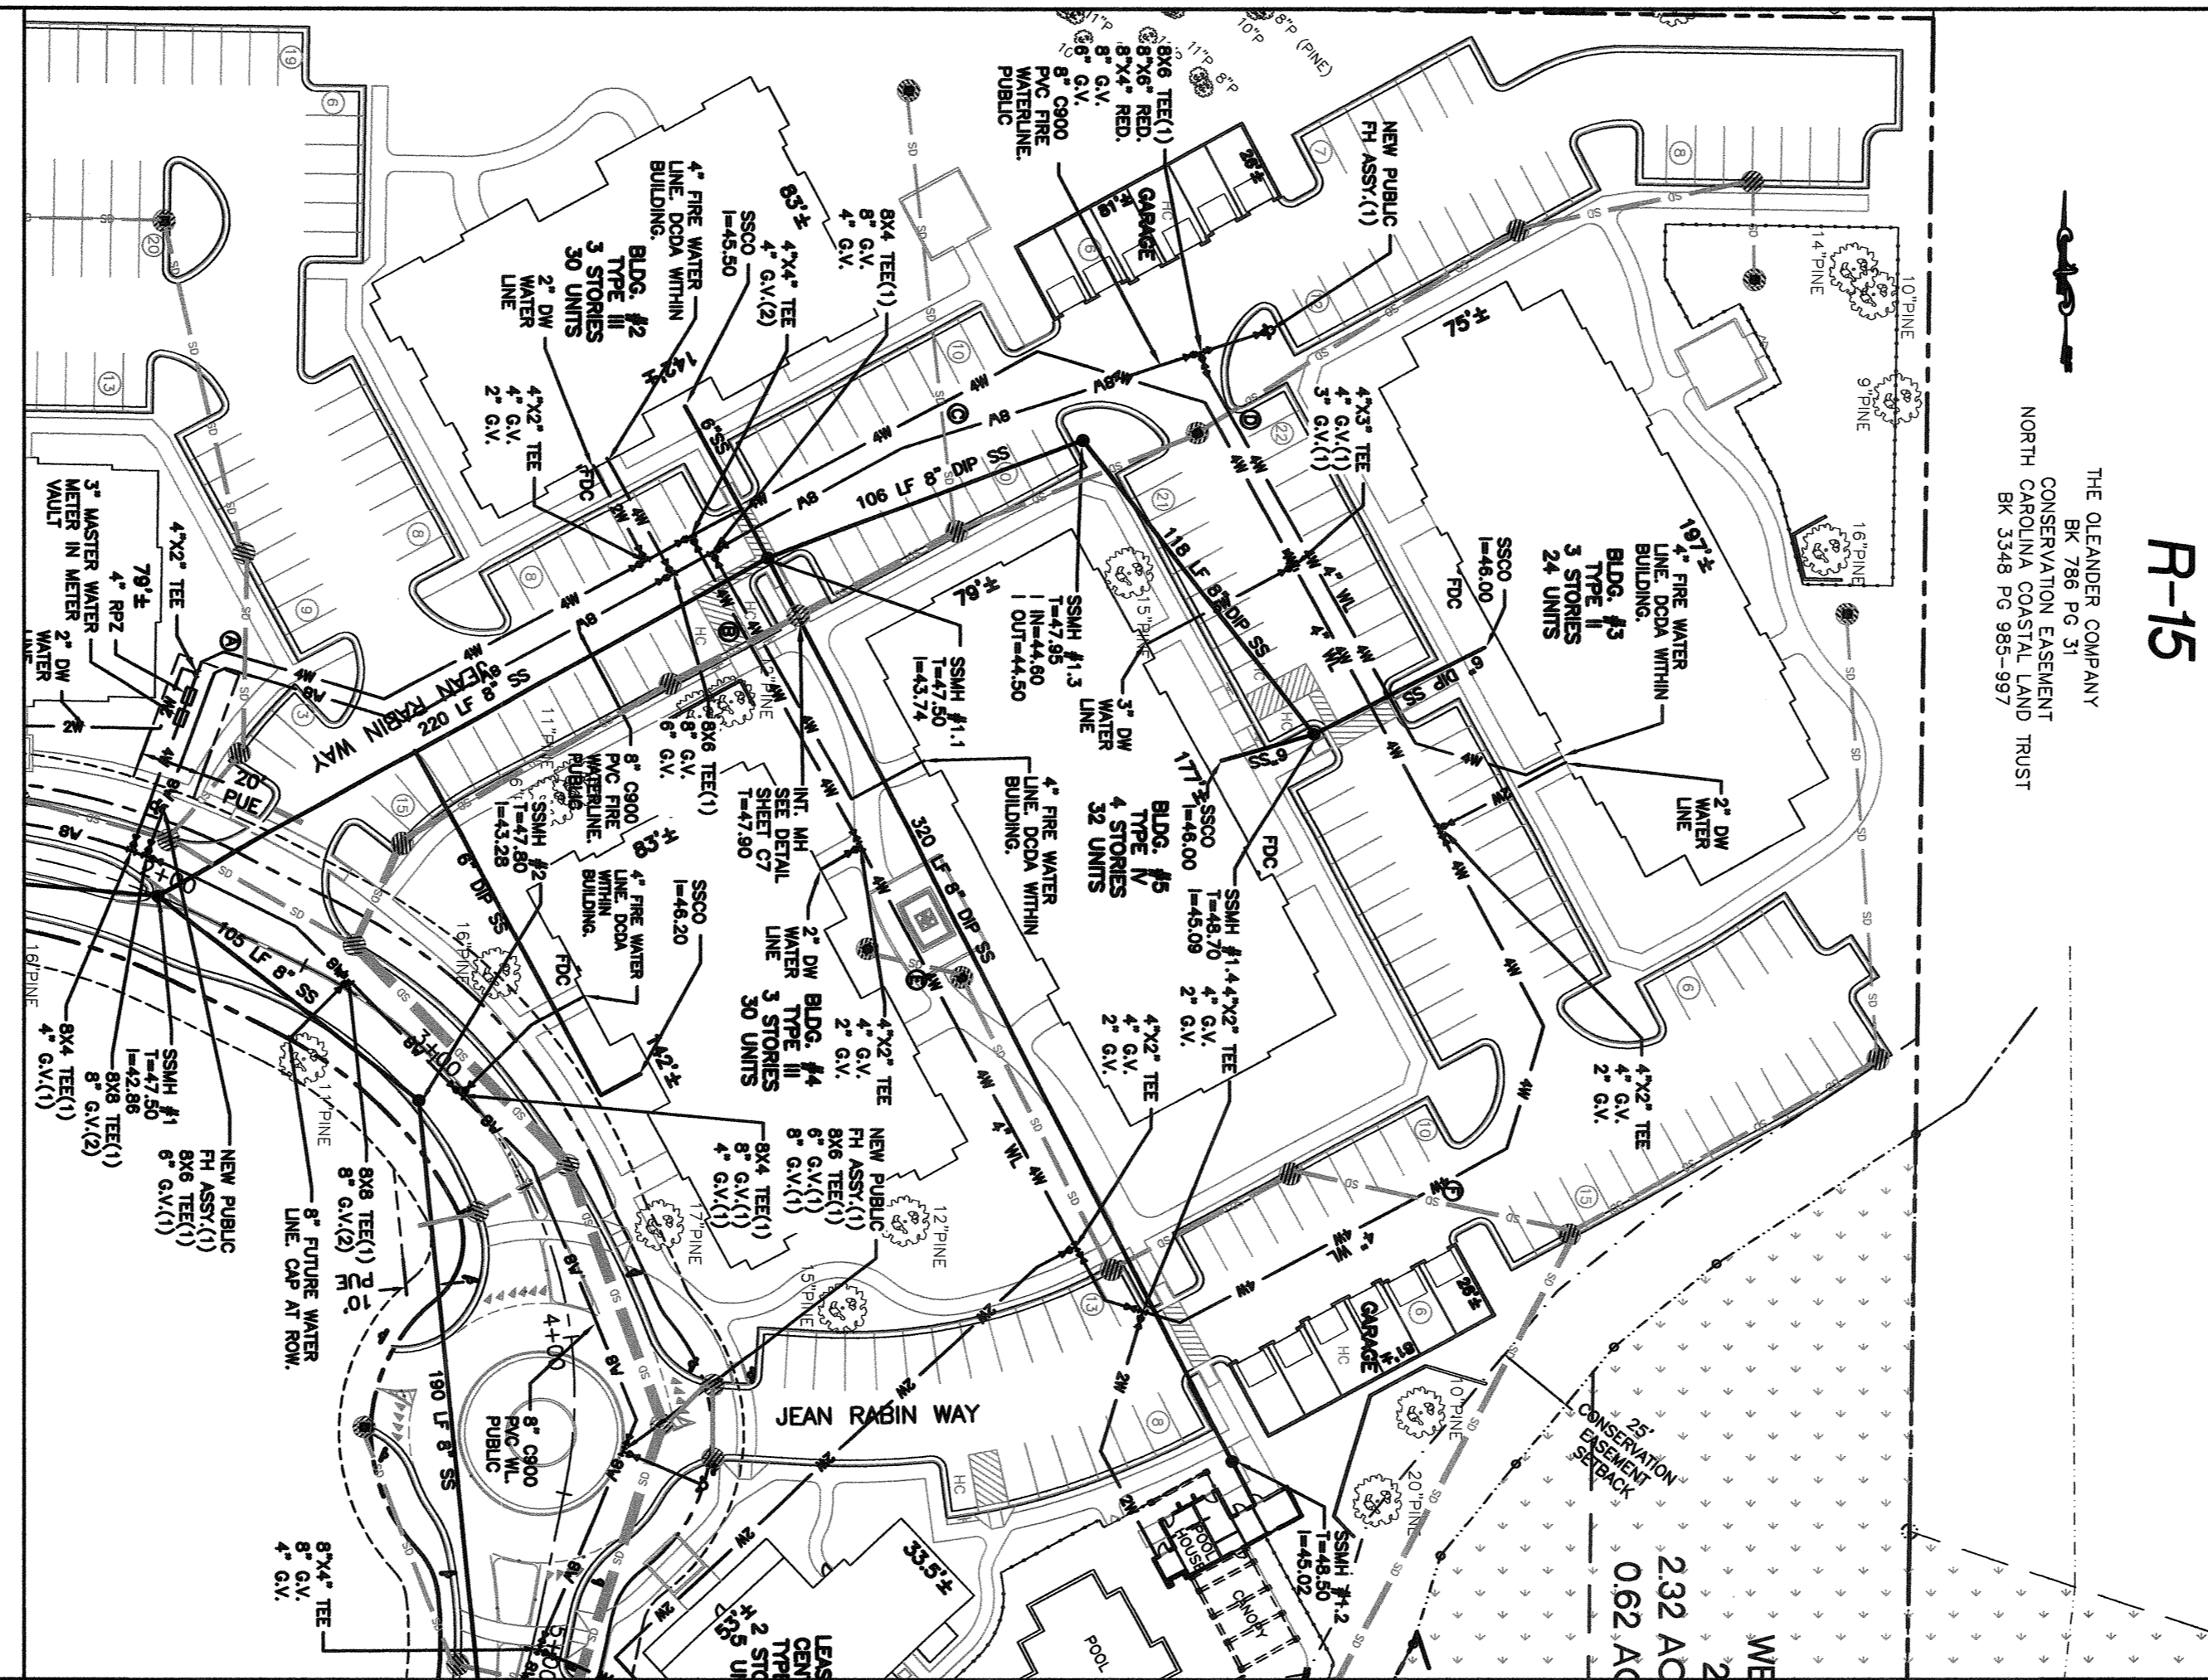

R-15

THE CLEANDER COMPANY
 BR. 786 PG. 31
 CONSERVATION EASEMENT
 NORTH BR. 3348 PG. 985-997

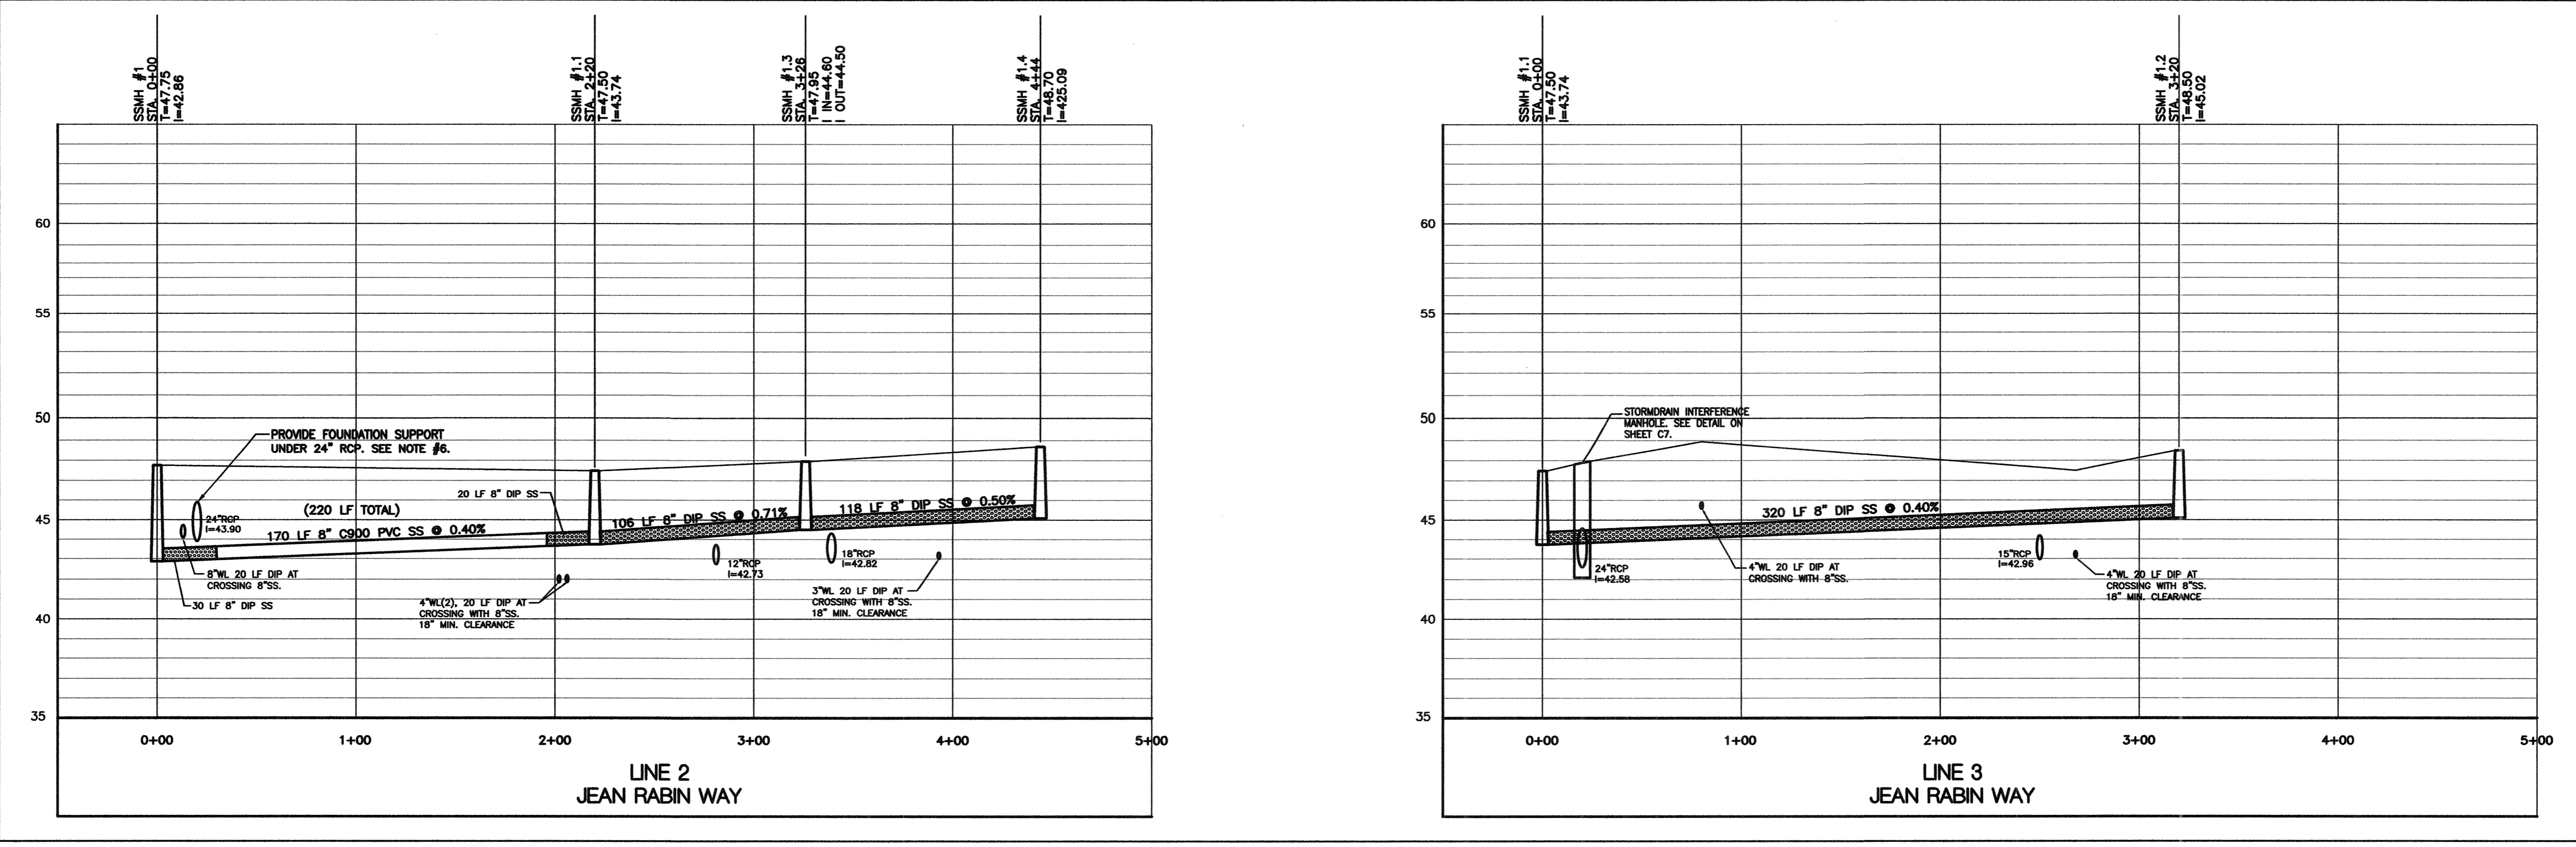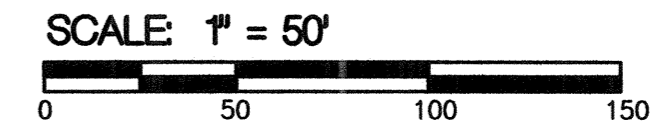

UTILITY NOTES:

1. LATERAL SEPARATION OF SEWERS AND WATER MAINS. WATER MAINS SHALL BE LAID AT LEAST 10 FEET LATERALLY FROM EXISTING OR PROPOSED SEWERS, UNLESS LOCAL CONDITIONS OR BARRIERS PREVENT A 10 FOOT LATERAL SEPARATION-IN WHICH CASE:

(A) THE WATER MAIN IS LAID IN A SEPARATE TRENCH, WITH THE ELEVATION OF THE BOTTOM OF THE WATER MAIN AT LEAST 18 INCHES ABOVE THE TOP OF THE SEWER, OR

(B) THE WATER MAIN IS LAID IN THE SAME TRENCH AS THE SEWER WITH THE WATER MAIN LOCATED AT ONE SIDE ON A BENCH OF UNDISTURBED EARTH, AND WITH THE ELEVATION OF THE BOTTOM OF THE WATER MAIN AT LEAST 18 INCHES ABOVE THE TOP OF THE SEWER.

2. CROSSING A WATER MAIN OVER A SEWER. WHENEVER IT IS NECESSARY FOR A WATER MAIN TO CROSS OVER A SEWER, THE WATER MAIN SHALL BE LAID AT SUCH AN ELEVATION THAT THE BOTTOM OF THE WATER MAIN IS AT LEAST 18 INCHES ABOVE THE TOP OF THE SEWER, UNLESS LOCAL CONDITIONS OR BARRIERS PREVENT AN 18 INCH VERTICAL SEPARATION-IN WHICH CASE BOTH THE WATER MAIN AND THE SEWER SHALL BE CONSTRUCTED OF FERROUS MATERIALS AND WITH JOINTS THAT ARE EQUIVALENT TO WATER MAIN STANDARDS FOR A DISTANCE OF 10 FEET ON EACH SIDE OF THE POINT OF CROSSING.

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4. MAINTAIN A 24\"/>

CFPUA STANDARD NOTES:

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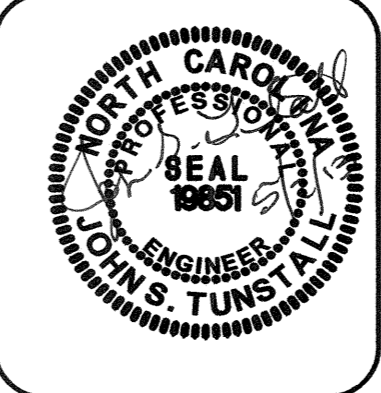
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5. 10' UTILITIES EASEMENT IS PROVIDED ALONG THE FRONTAGE OF ALL LOTS AND AS SHOWN.

6. NO FLEXIBLE COUPLINGS SHALL BE USED.

HORIZ. 1" = 50'
 VERT. 1" = 8'

REV. NO.	DESCRIPTION	DATE



NORRIS & TUNSTALL
 CONSULTING ENGINEERS, INC.

1127 FLORAL PARWAY PHONE (910) 343-9853
 SUITE 300 # 400 FAX (910) 343-9904
 WILMINGTON, NC 28403 lic#0006 EC-0620

SANITARY SEWER PLAN AND PROFILE
 TIBURON PARC APARTMENTS
 2945 MOYNET WAY
 WILMINGTON, N. C.

DATE: 5/2/13
 SCALE: 1" = 50'
 DRAWN: NKS
 CHECKED: JST
 PROJECT NO: 12073

SHEET NO:
PR2

For each open utility cut of City streets, a \$325 permit shall be required from the City prior to occupancy and/or project acceptance.

Approved Construction Plan

Name _____ Date _____

Planning _____

Traffic _____

Fire _____

NC DENR PWSS WATER PERMIT #: _____




WATER CAPACITY: _____ GPD

DWQ SEWER PERMIT #: _____

SEWER CAPACITY: _____ GPD

SEWER SHED # AND PLANT: _____

SEWER TO FLOW THROUGH NEI: YES or NO (CIRCLE ONE)

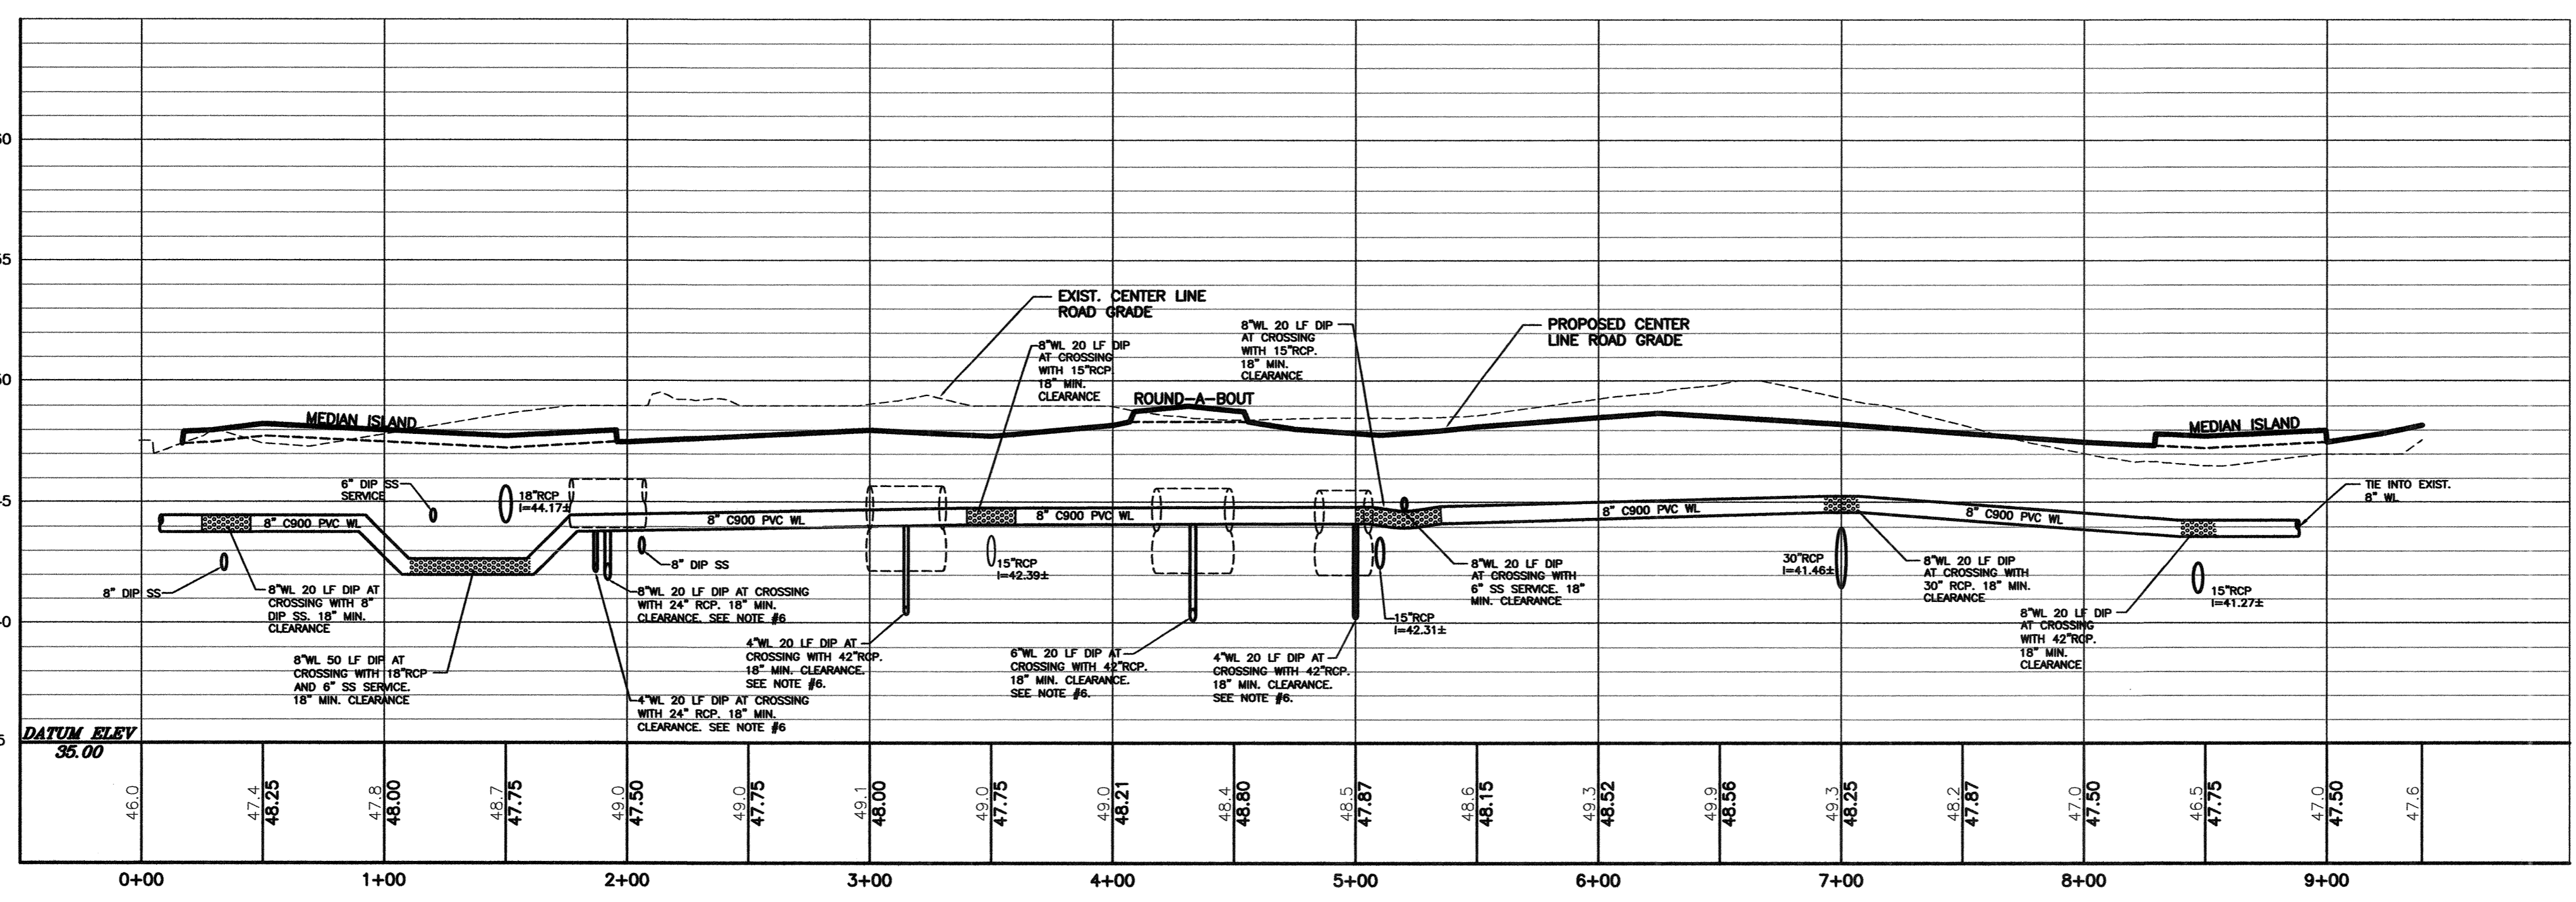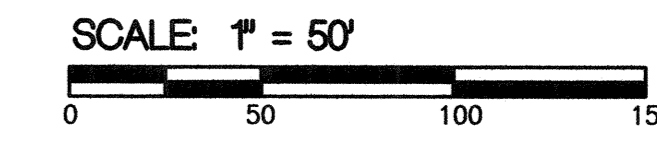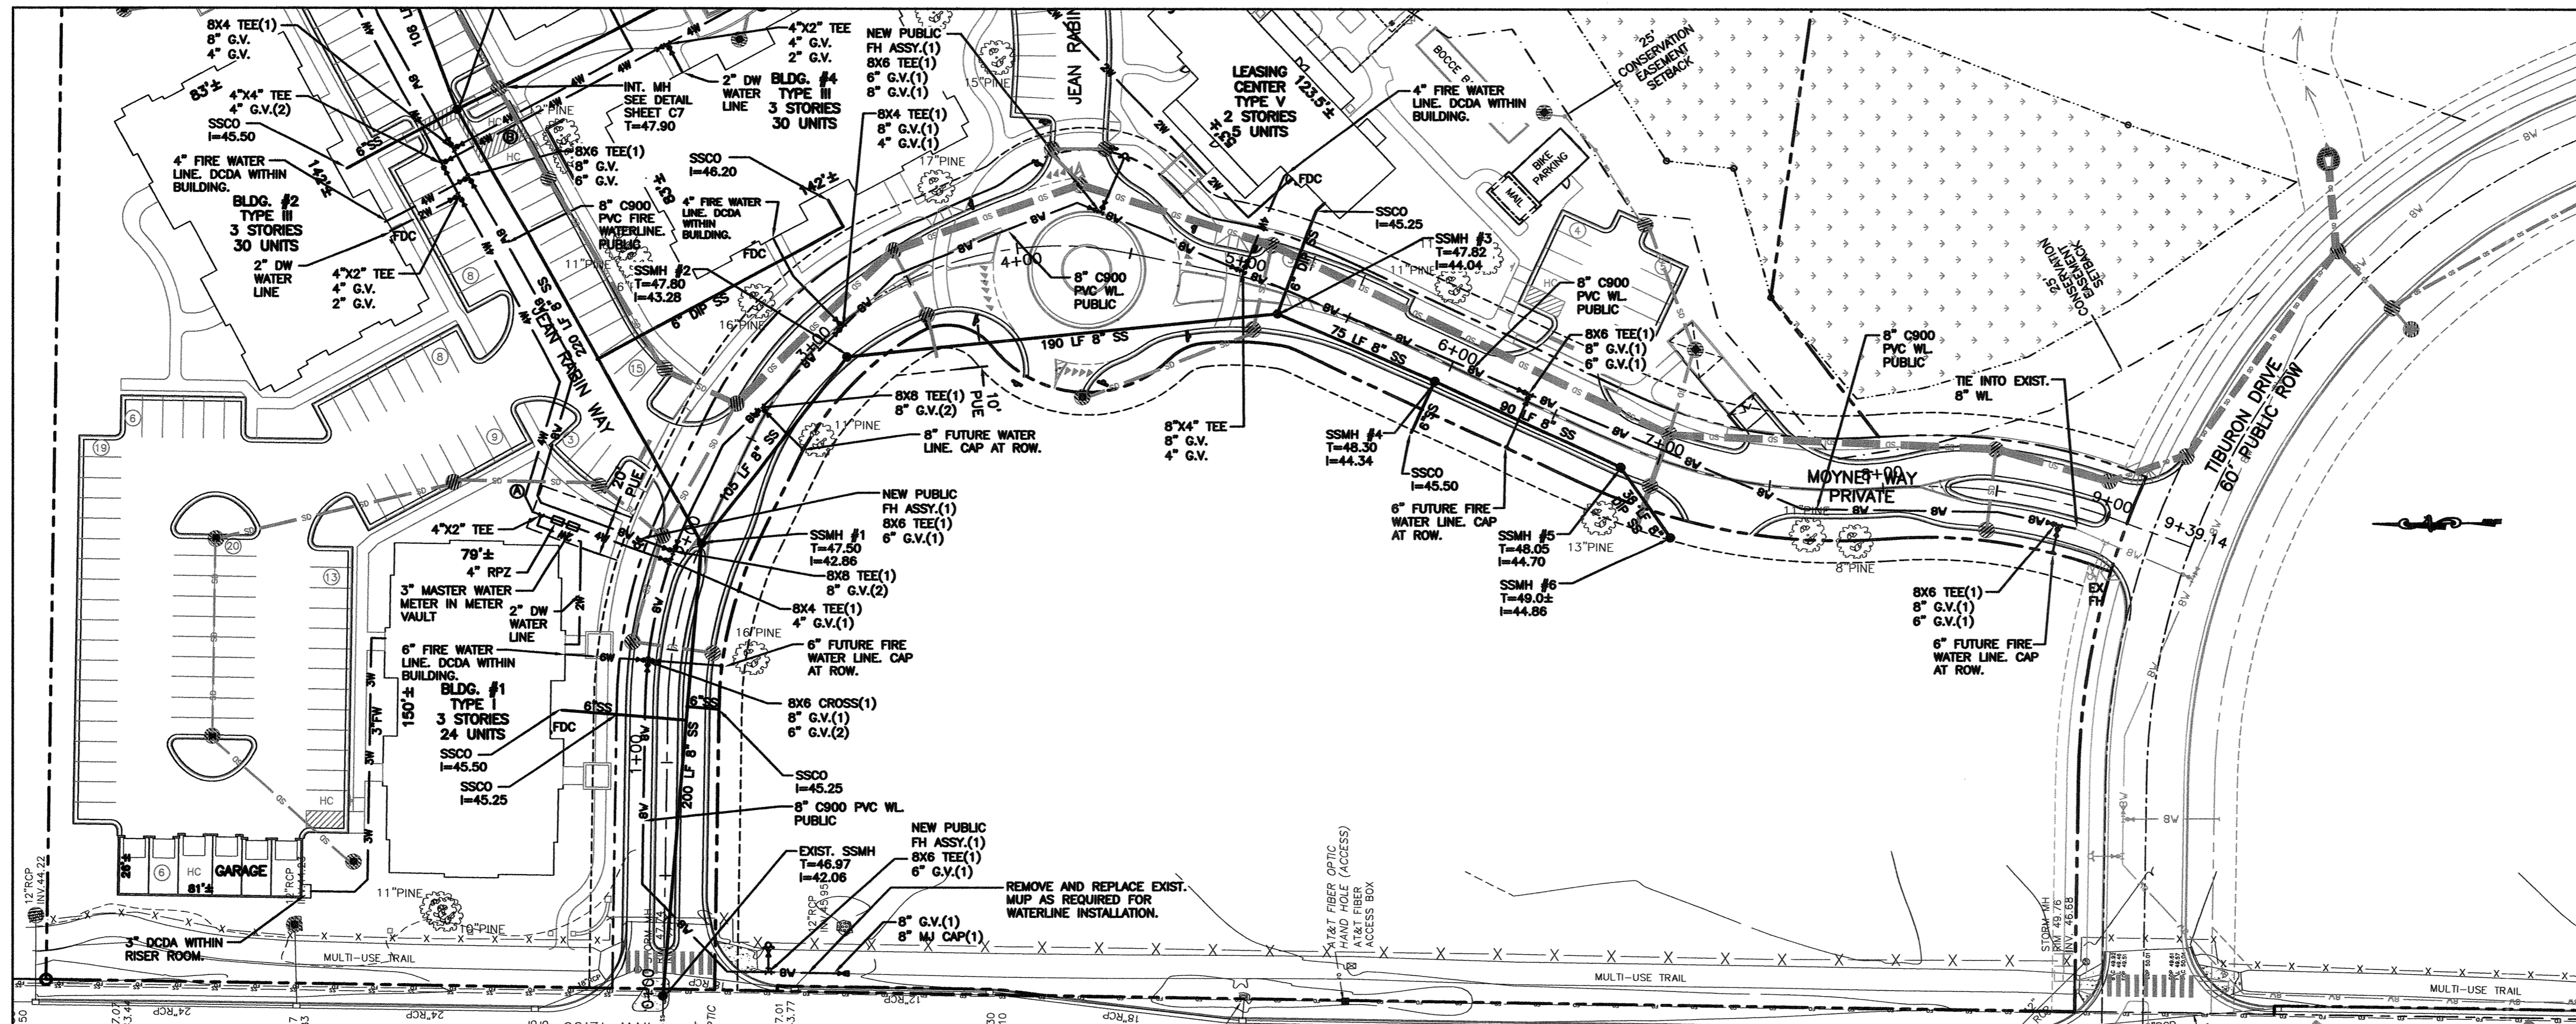


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 - MAINTAIN A 24" MINIMUM SEPARATION BETWEEN THE PROPOSED OR EXISTING STORM DRAIN AND THE PROPOSED OR EXISTING WATER LINE OR SEWER LINE. SEE DETAILS.
 - RESTRAINING/BLOCKING: THE PLUGS, CAPS, TEES AND BENDS DEFLECTING 22-1/2 DEGREES OR MORE EITHER VERTICALLY OR HORIZONTALLY ON WATER LINES 6 INCHES IN DIAMETER OF LARGER SHALL BE PROVIDED WITH THRUST BLOCKING OF "MEGALUG" RETAINER GLAND AT EACH JOINT, INSTALLED PER MANUFACTURER'S REQUIREMENTS.
 - FOR STORMDRAIN PIPES 24" AND LARGER, WHEN THE STORMDRAIN PIPE IS OVER GRAVITY SEWER OR WATERLINE WITH LESS THAN 18" SEPARATION, STRUCTURAL BRIDGING MUST BE INSTALLED. SEE CPUPA DETAIL.

- CPUPA STANDARD NOTES:**
- SEWER GUARDS REQUIRED AT ALL MANHOLES. STAINLESS STEEL SEWER GUARDS REQUIRED AT MANHOLES LOCATED IN TRAFFIC AREAS.
 - WELLS IN CONFLICT ARE TO BE RELOCATED.
 - SERVICES SHALL BE PERPENDICULAR TO MAIN AND TERMINATE AT RIGHT OF WAY LINE. SERVICES IN CUL-DE-SAC ARE REQUIRED TO BE PERPENDICULAR, OR MUST ORIGINATE IN MANHOLE AND TERMINATE AT RIGHT OF WAY LINE.
 - ALL SERVICES TYING INTO DUCTILE IRON MAINS SHALL BE CONSTRUCTED OF CLASS 50, D.I.P. 401 PROTECTED CERAMIC LINED.
 - 10' UTILITIES EASEMENT IS PROVIDED ALONG THE FRONTAGE OF ALL LOTS AND AS SHOWN.
 - NO FLEXIBLE COUPLINGS SHALL BE USED.

HORIZ. 1" = 50'
VERT. 1" = 8'

REV. NO.	DESCRIPTION	DATE

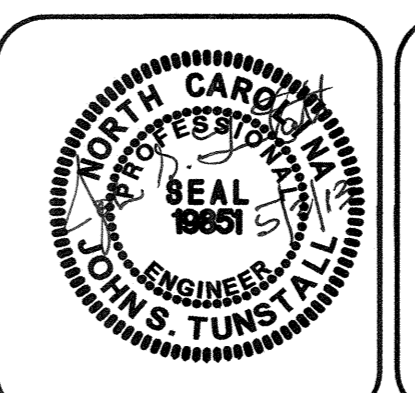


NORRIS & TUNSTALL
CONSULTING ENGINEERS, INC.

1127 FLORAL PARWAY PHONE (910) 343-9853
SUITE 300 & 400 FAX (910) 343-9804
WILMINGTON, NC 28403 LICENSE EC-3250


DATE: 5/2/13
SCALE: 1" = 50'
DRAWN: NKS
CHECKED: JUST
PROJECT NO: 12073

SHEET NO: **PR3**

F:\Projects\2012\12073 Midtown Apartments of Tiburon Parc\12073.master.r4.dwg, 5/7/2013 9:58:20 AM

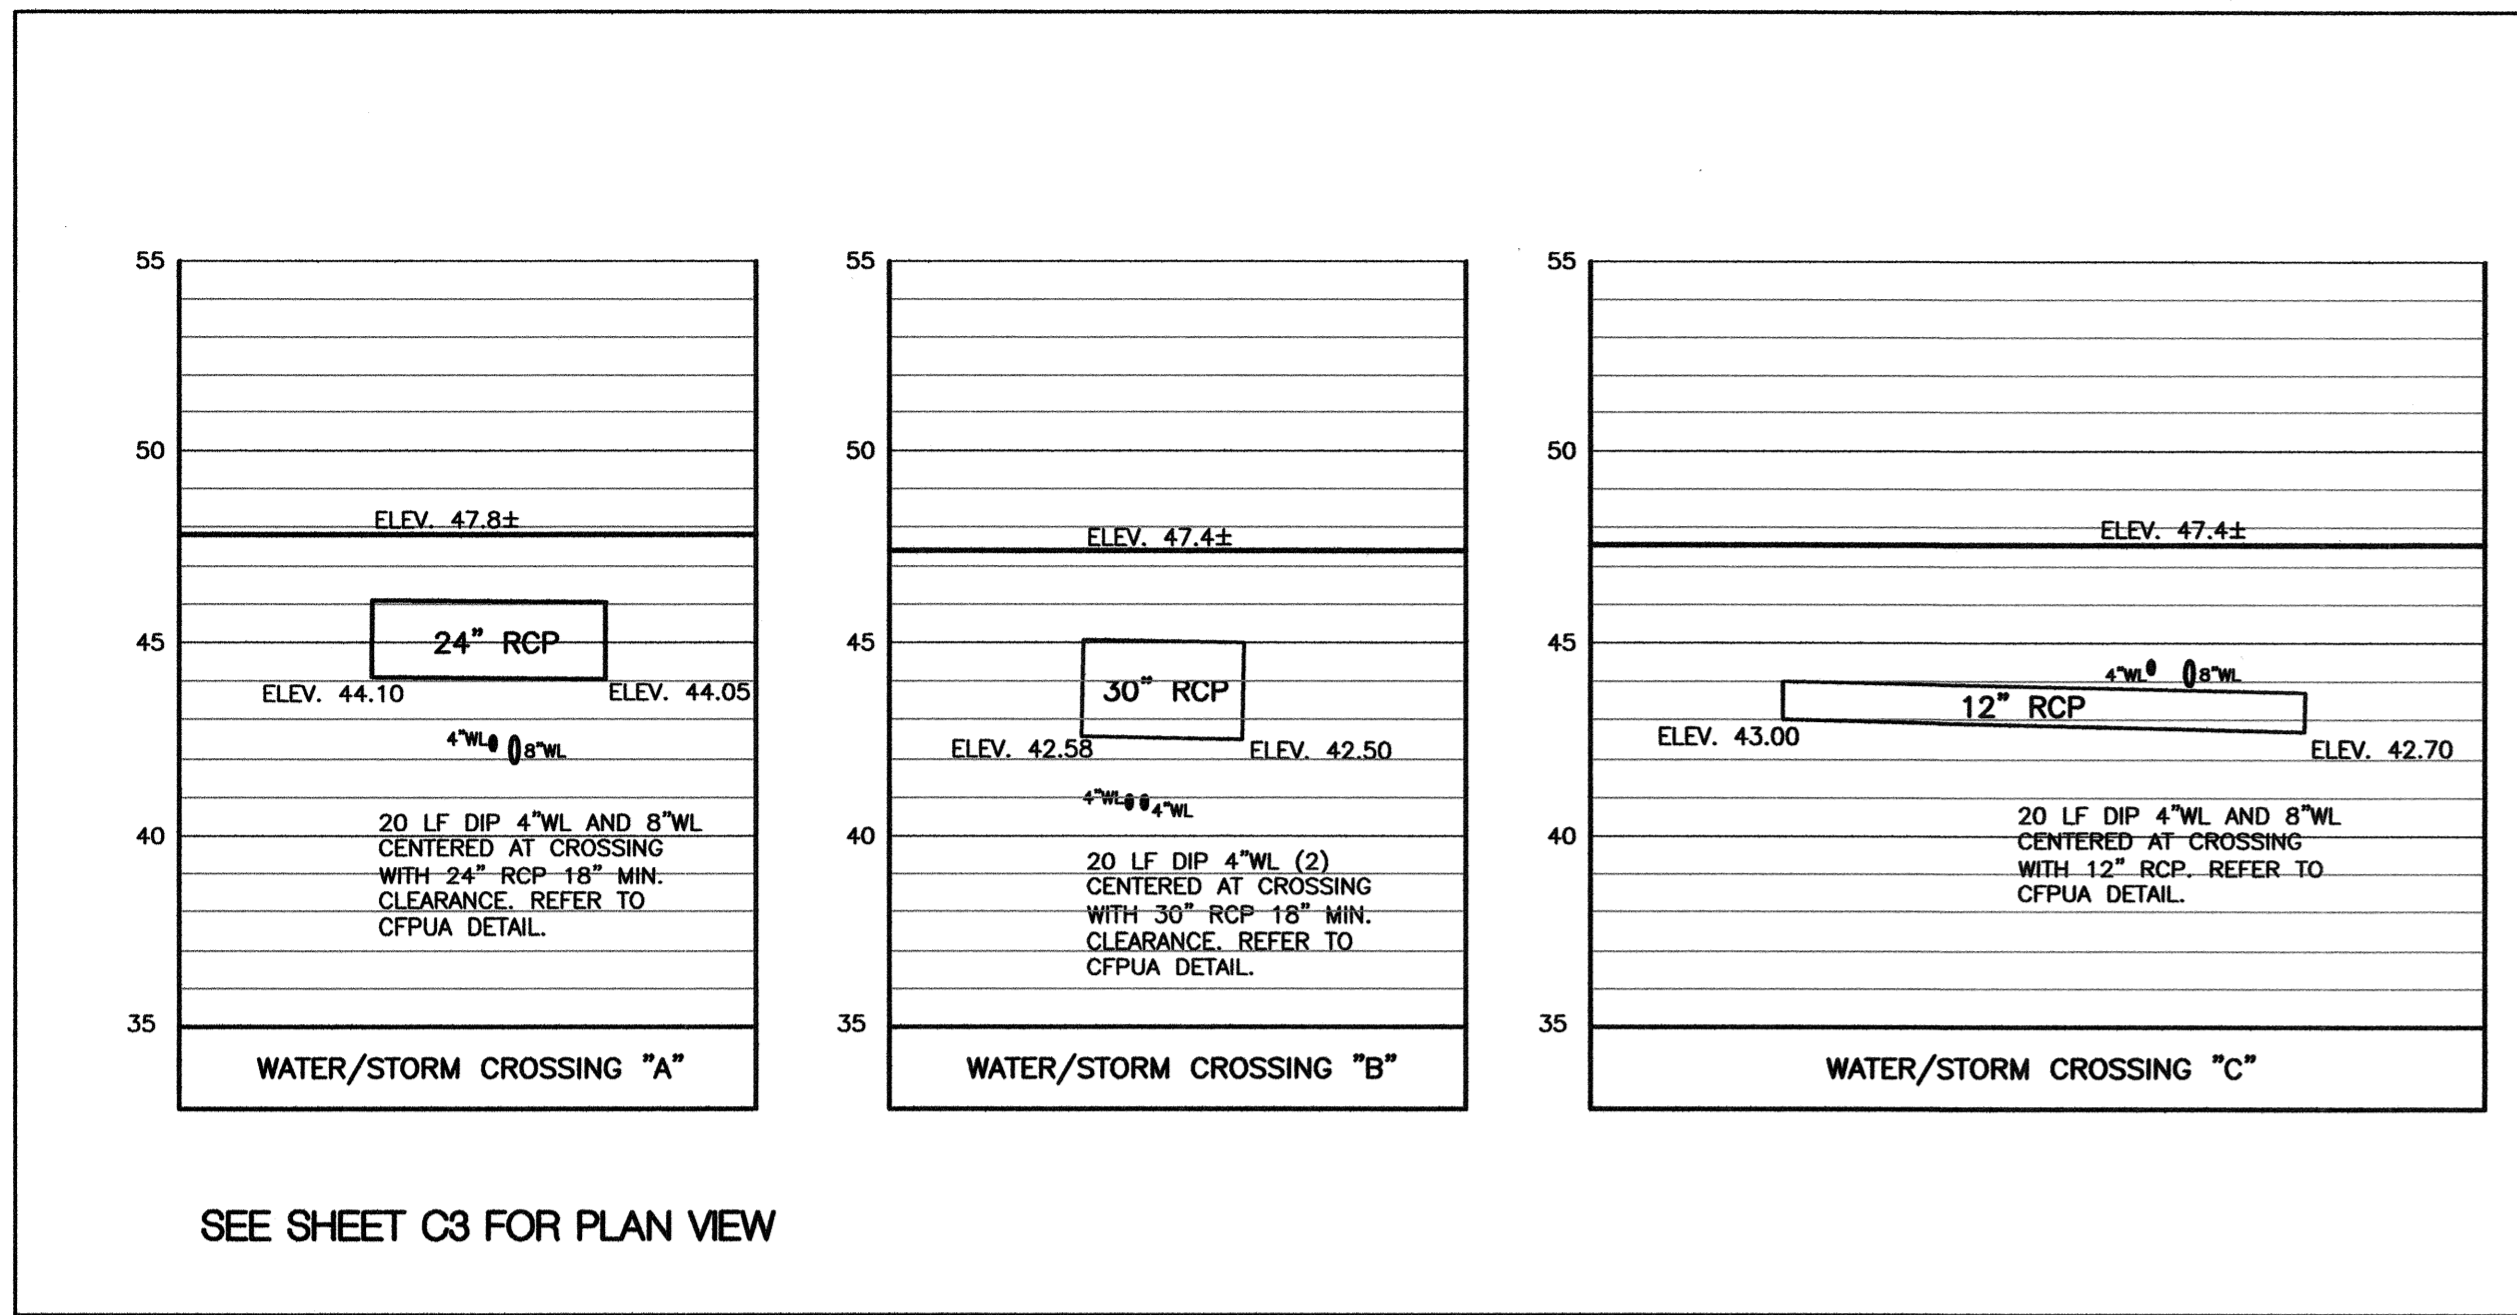

SEE SHEET C3 FOR PLAN VIEW

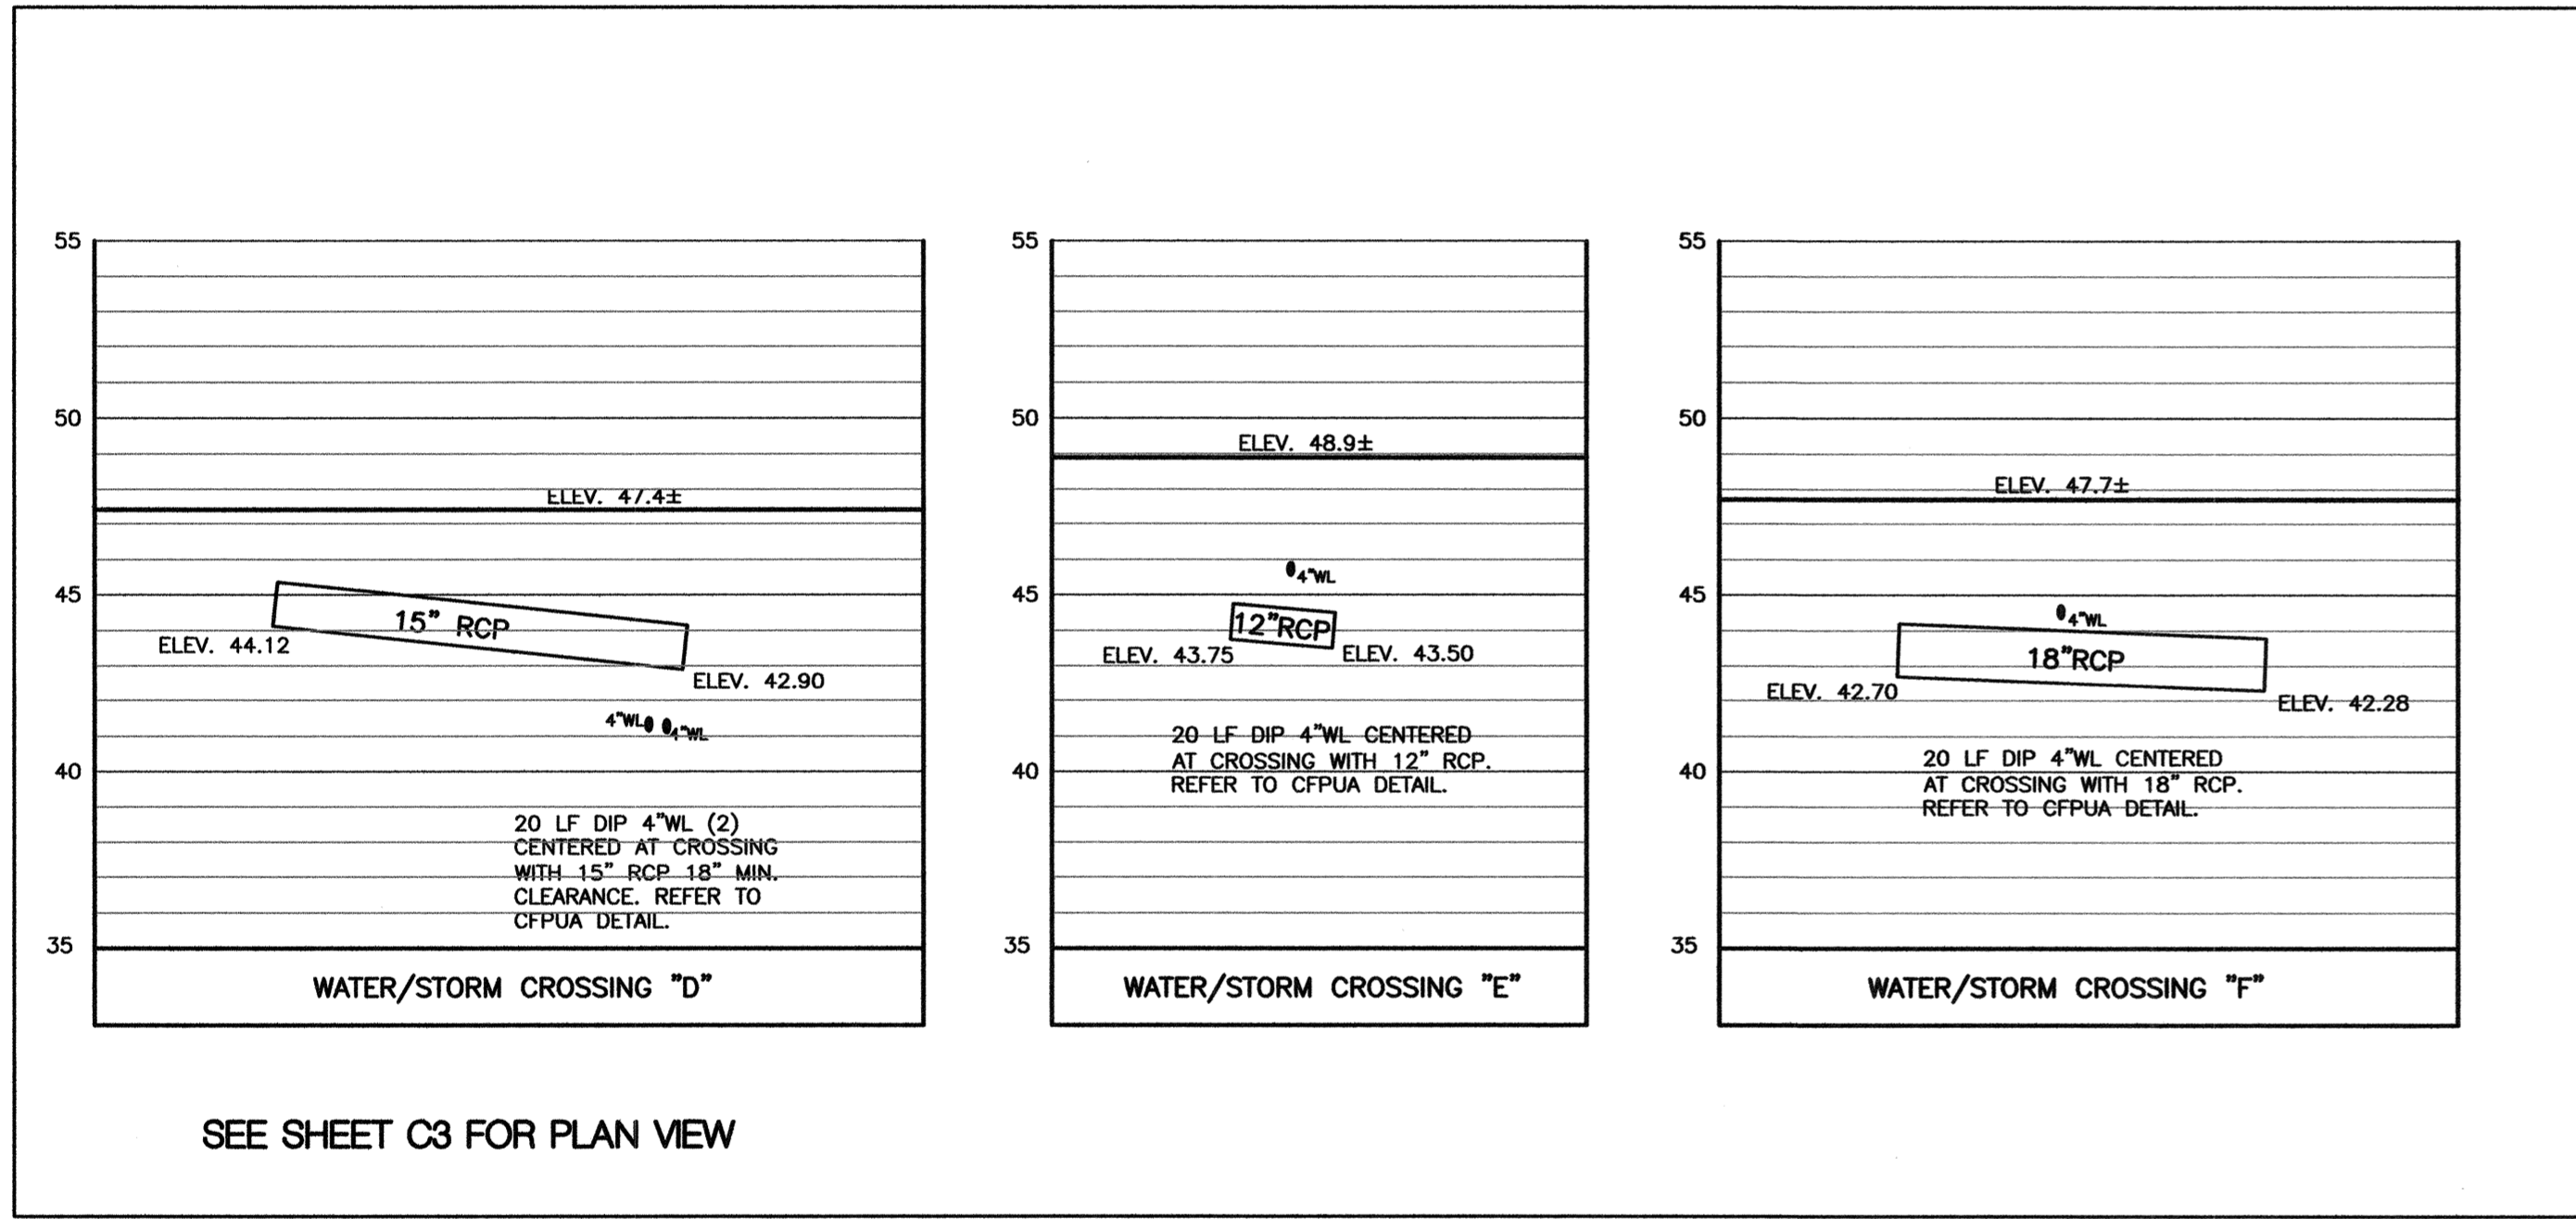

SEE SHEET C3 FOR PLAN VIEW

UTILITY NOTES:


- LATERAL SEPARATION OF SEWERS AND WATER MAINS. WATER MAINS SHALL BE LAID AT LEAST 10 FEET LATERALLY FROM EXISTING OR PROPOSED SEWERS, UNLESS LOCAL CONDITIONS OR BARRIERS PREVENT A 10 FOOT LATERAL SEPARATION- IN WHICH CASE:
 - THE WATER MAIN IS LAID IN A SEPARATE TRENCH, WITH THE ELEVATION OF THE BOTTOM OF THE WATER MAIN AT LEAST 18 INCHES ABOVE THE TOP OF THE SEWER; OR
 - THE WATER MAIN IS LAID IN THE SAME TRENCH AS THE SEWER WITH THE WATER MAIN LOCATED AT ONE SIDE ON A BENCH OF UNDISTURBED EARTH, AND WITH THE ELEVATION OF THE BOTTOM OF THE WATER MAIN AT LEAST 18 INCHES ABOVE THE TOP OF THE SEWER.
- CROSSING A WATER MAIN OVER A SEWER. WHENEVER IT IS NECESSARY FOR A WATER MAIN TO CROSS OVER A SEWER, THE WATER MAIN SHALL BE LAID AT SUCH AN ELEVATION THAT THE BOTTOM OF THE WATER MAIN IS AT LEAST 18 INCHES ABOVE THE TOP OF THE SEWER, UNLESS LOCAL CONDITIONS OR BARRIERS PREVENT AN 18 INCH VERTICAL SEPARATION- IN WHICH CASE BOTH THE WATER MAIN AND THE SEWER SHALL BE CONSTRUCTED OF FERROUS MATERIALS AND WITH JOINTS THAT ARE EQUIVALENT TO WATER MAIN STANDARDS FOR A DISTANCE OF 10 FEET ON EACH SIDE OF THE POINT OF CROSSING.
- CROSSING A WATER MAIN UNDER A SEWER. WHENEVER IT IS NECESSARY FOR A WATER MAIN TO CROSS UNDER A SEWER, BOTH THE WATER MAIN AND THE SEWER SHALL BE CONSTRUCTED OF FERROUS MATERIALS AND WITH JOINTS EQUIVALENT TO WATER MAIN STANDARDS FOR A DISTANCE OF 10 FEET ON EACH SIDE OF THE POINT OF CROSSING.
- MAINTAIN A 24" MINIMUM SEPARATION BETWEEN THE PROPOSED OR EXISTING STORM DRAIN AND THE PROPOSED OR EXISTING WATER LINE OR SEWER LINE. SEE DETAILS.
- RESTRAINING/BLOCKING: THE PLUGS, CAPS, TEES AND BENDS DEFLECTING 22-1/2 DEGREES OR MORE EITHER VERTICALLY OR HORIZONTALLY ON WATER LINES 6 INCHES IN DIAMETER OF LARGER SHALL BE PROVIDED WITH THRUST BLOCKING OF "MEGALUG" RETAINER GLAND AT EACH JOINT, INSTALLED PER MANUFACTURER'S REQUIREMENTS.
- FOR STORMDRAIN PIPES 24" AND LARGER, WHEN THE STORMDRAIN PIPE IS OVER GRAVITY SEWER OR WATERLINE WITH LESS THAN 18" SEPARATION, STRUCTURAL BRIDGING MUST BE INSTALLED. SEE CFPUA DETAIL.

CFPUA STANDARD NOTES:

- SEWER GUARDS REQUIRED AT ALL MANHOLES. STAINLESS STEEL SEWER GUARDS REQUIRED AT MANHOLES LOCATED IN TRAFFIC AREAS.
- WELLS IN CONFLICT ARE TO BE RELOCATED.
- SERVICES SHALL BE PERPENDICULAR TO MAIN AND TERMINATE AT RIGHT OF WAY LINE. SERVICES IN CUL-DE-SAC ARE REQUIRED TO BE PERPENDICULAR, OR MUST ORIGINATE IN MANHOLE AND TERMINATE AT RIGHT OF WAY LINE.
- ALL SERVICES TYING INTO DUCTILE IRON MAINS SHALL BE CONSTRUCTED OF CLASS 50, D.I.P. 401 PROTECTO CERAMIC LINED.
- 10' UTILITIES EASEMENT IS PROVIDED ALONG THE FRONTAGE OF ALL LOTS AND AS SHOWN.
- NO FLEXIBLE COUPLINGS SHALL BE USED.

HORIZ. $\frac{1}{8}'' = 50'$
VERT. $\frac{1}{8}'' = 5'$

REV. NO.	DESCRIPTION	DATE

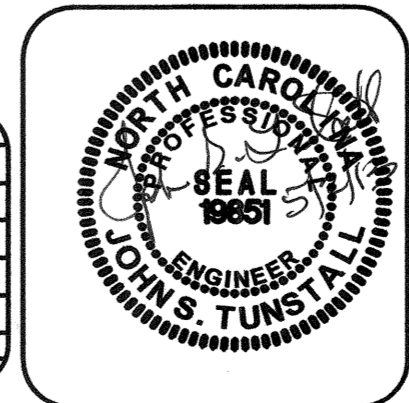

NORRIS & TUNSTALL
CONSULTING ENGINEERS, INC.
1127 FLORENCE PARADISE DRIVE, SUITE 300 • WILMINGTON, NC 28403
PHONE (910) 343-9653 FAX (910) 343-9604
LICENSE PC-30520

WATERLINE PLAN AND PROFILE
TIBURON PARC APARTMENTS
2945 MOYNET WAY
WILMINGTON, N. C.

DATE: 5/2/13
SCALE: 1" = 50'
DRAWN: NKS
CHECKED: JUST
PROJECT NO: 12073


SHEET NO:
PR4

Approved Construction Plan

Name	Date
Planning	
Traffic	
Fire	


For each open utility cut of City streets, a \$325 permit shall be required from the City prior to occupancy and/or project acceptance.

NCDENR PWSS WATER PERMIT #: _____
WATER CAPACITY: _____ GPD
DWQ SEWER PERMIT #: _____
SEWER CAPACITY: _____ GPD
SEWER SHED # AND PLANT: _____
SEWER TO FLOW THROUGH NEI: YES or NO (CIRCLE ONE)

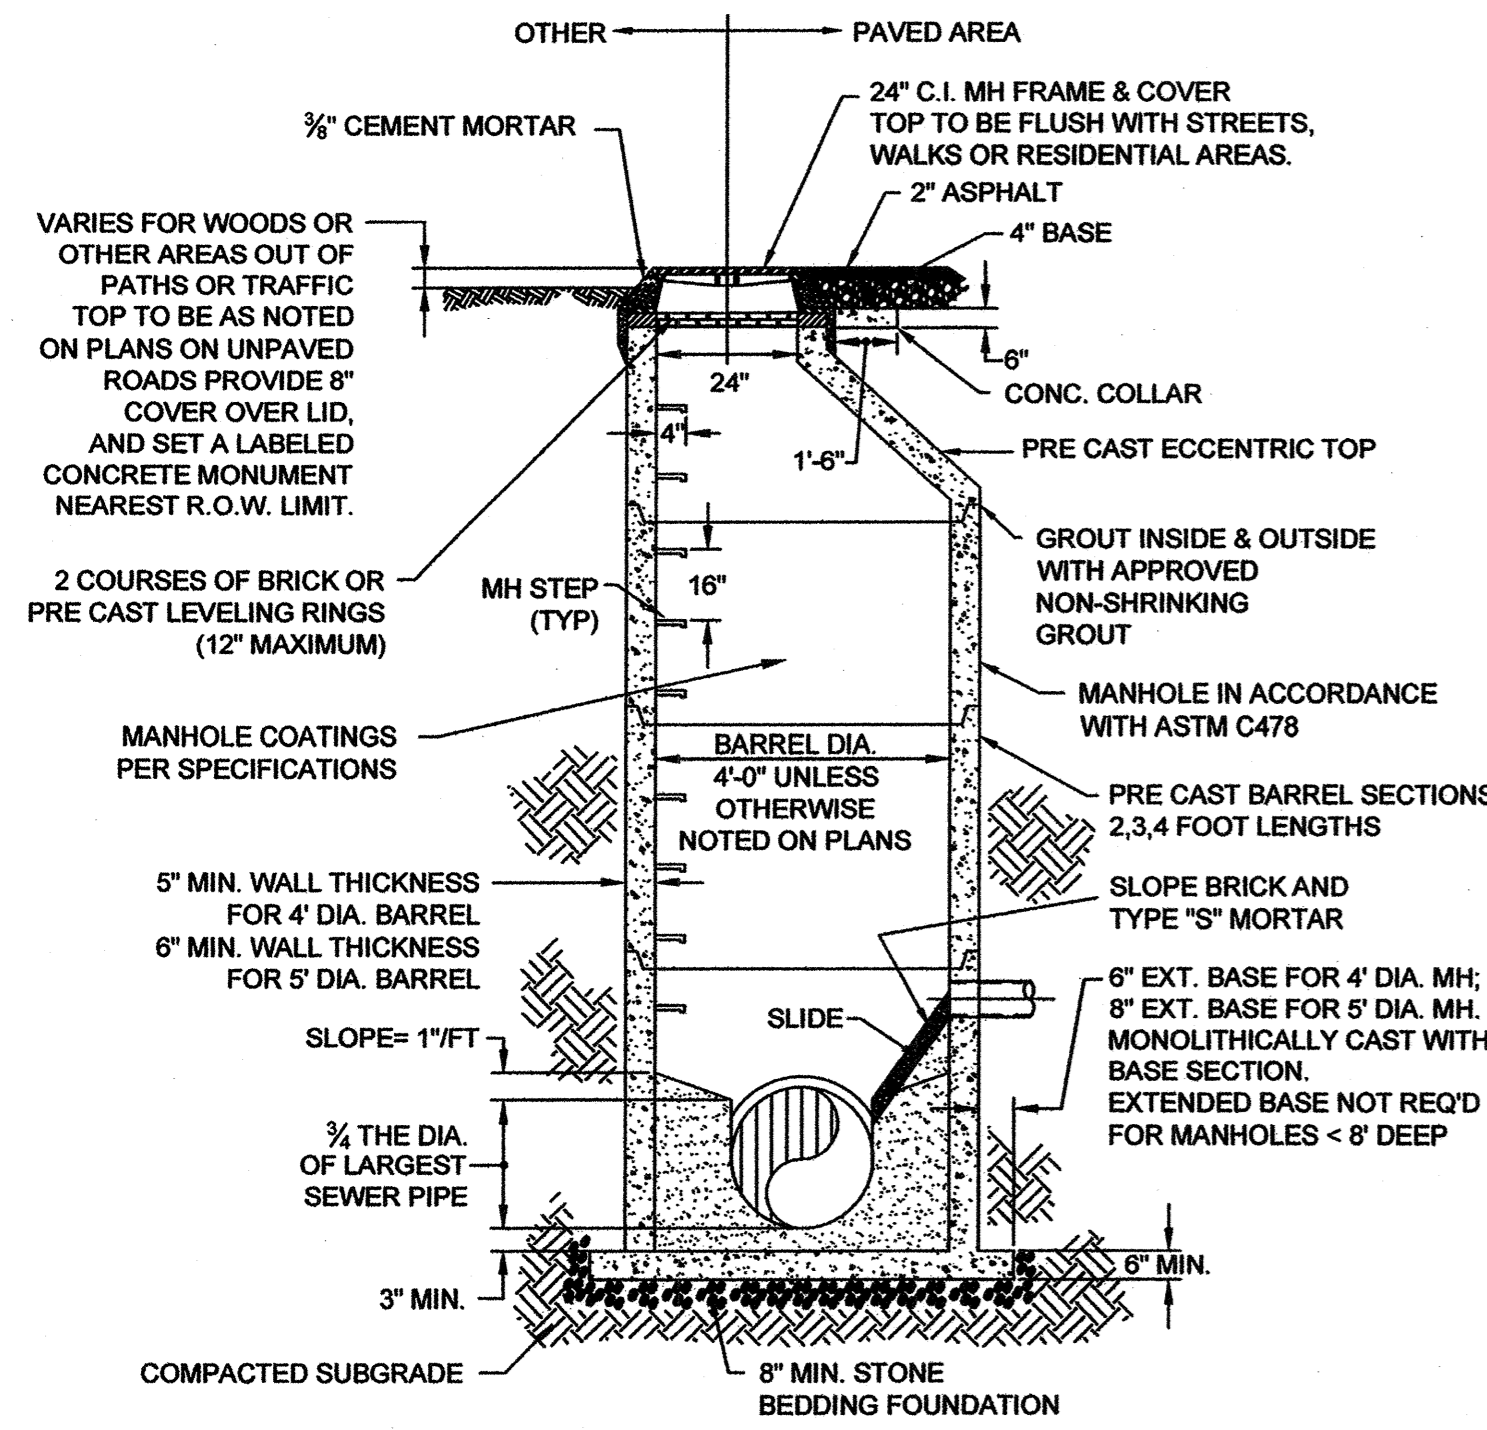


PRECAST CONCRETE OFFSET MANHOLE TYPICAL

(LESS THAN 30" DROP)
NOT TO SCALE

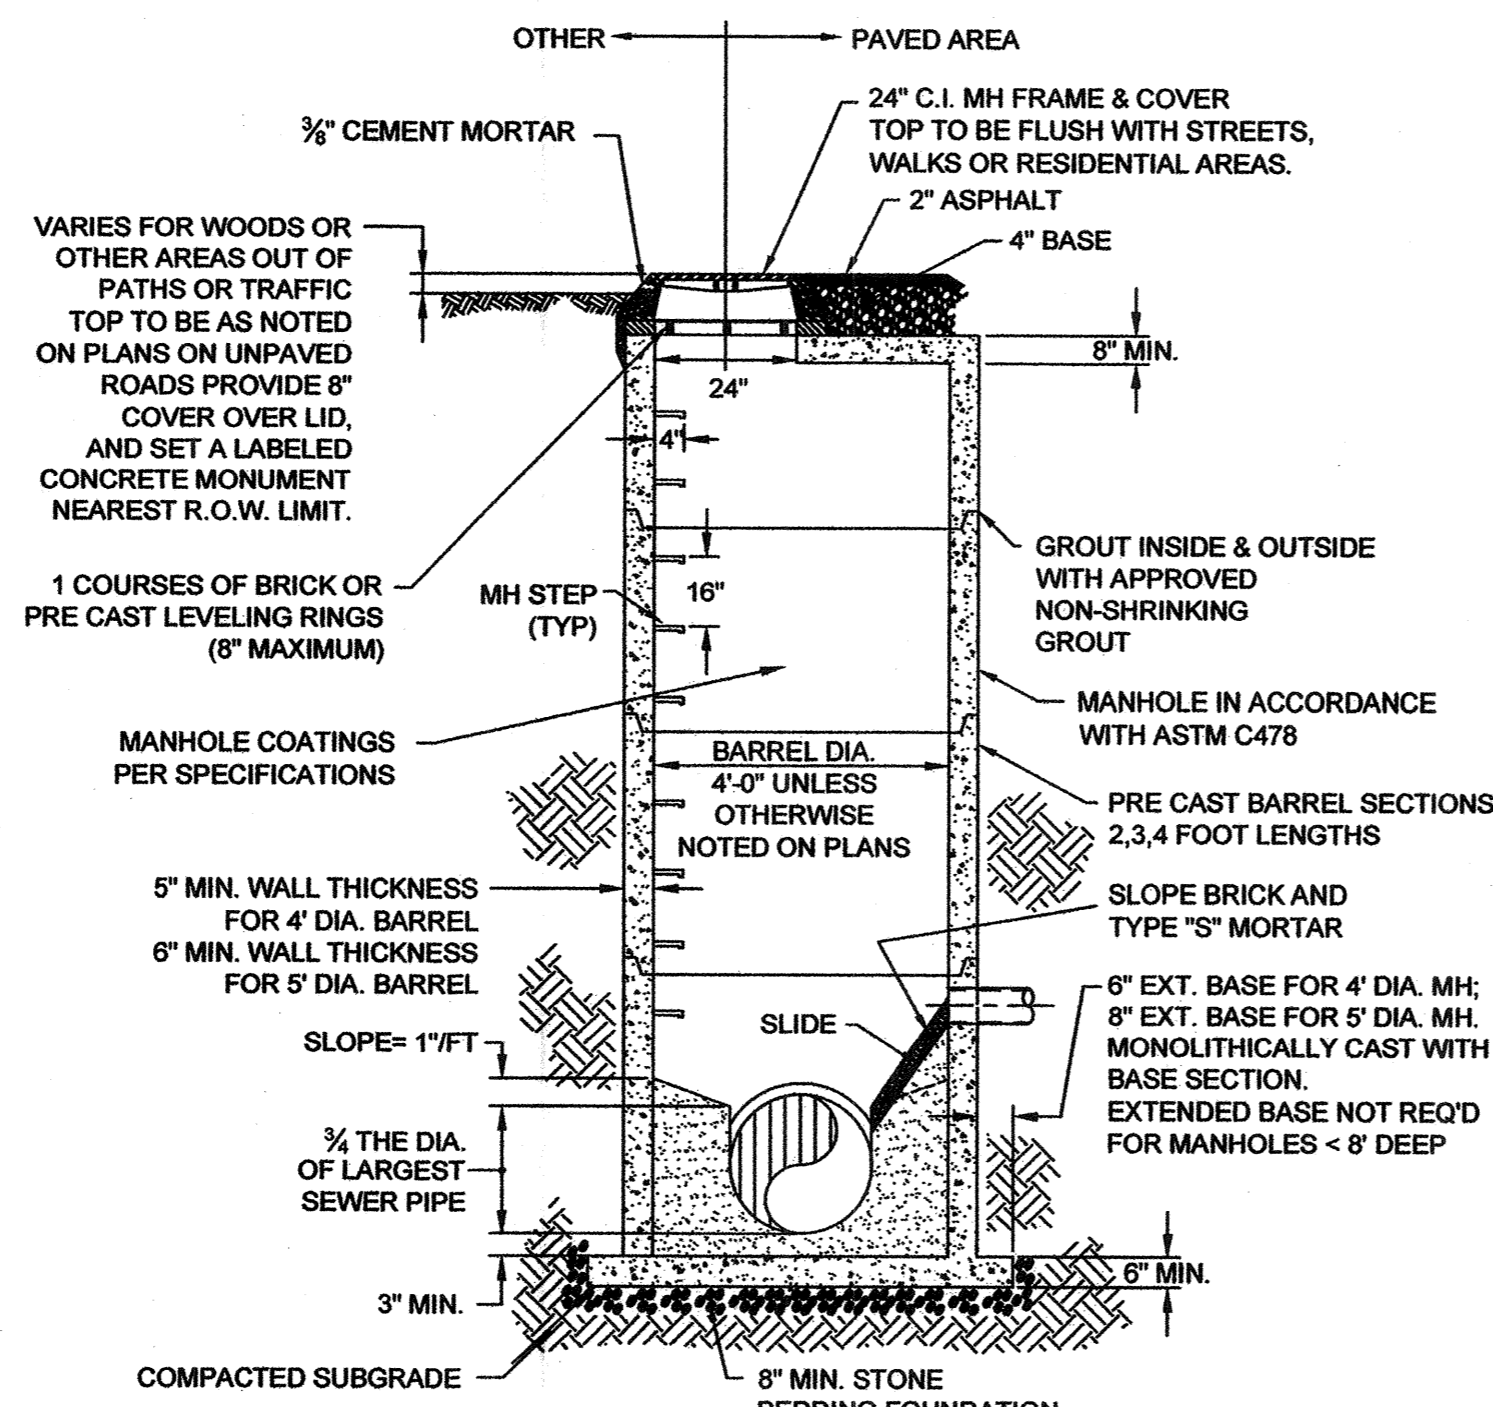


PRECAST CONCRETE FLAT TOP MANHOLE TYPICAL

(LESS THAN 30" DROP)
NOT TO SCALE

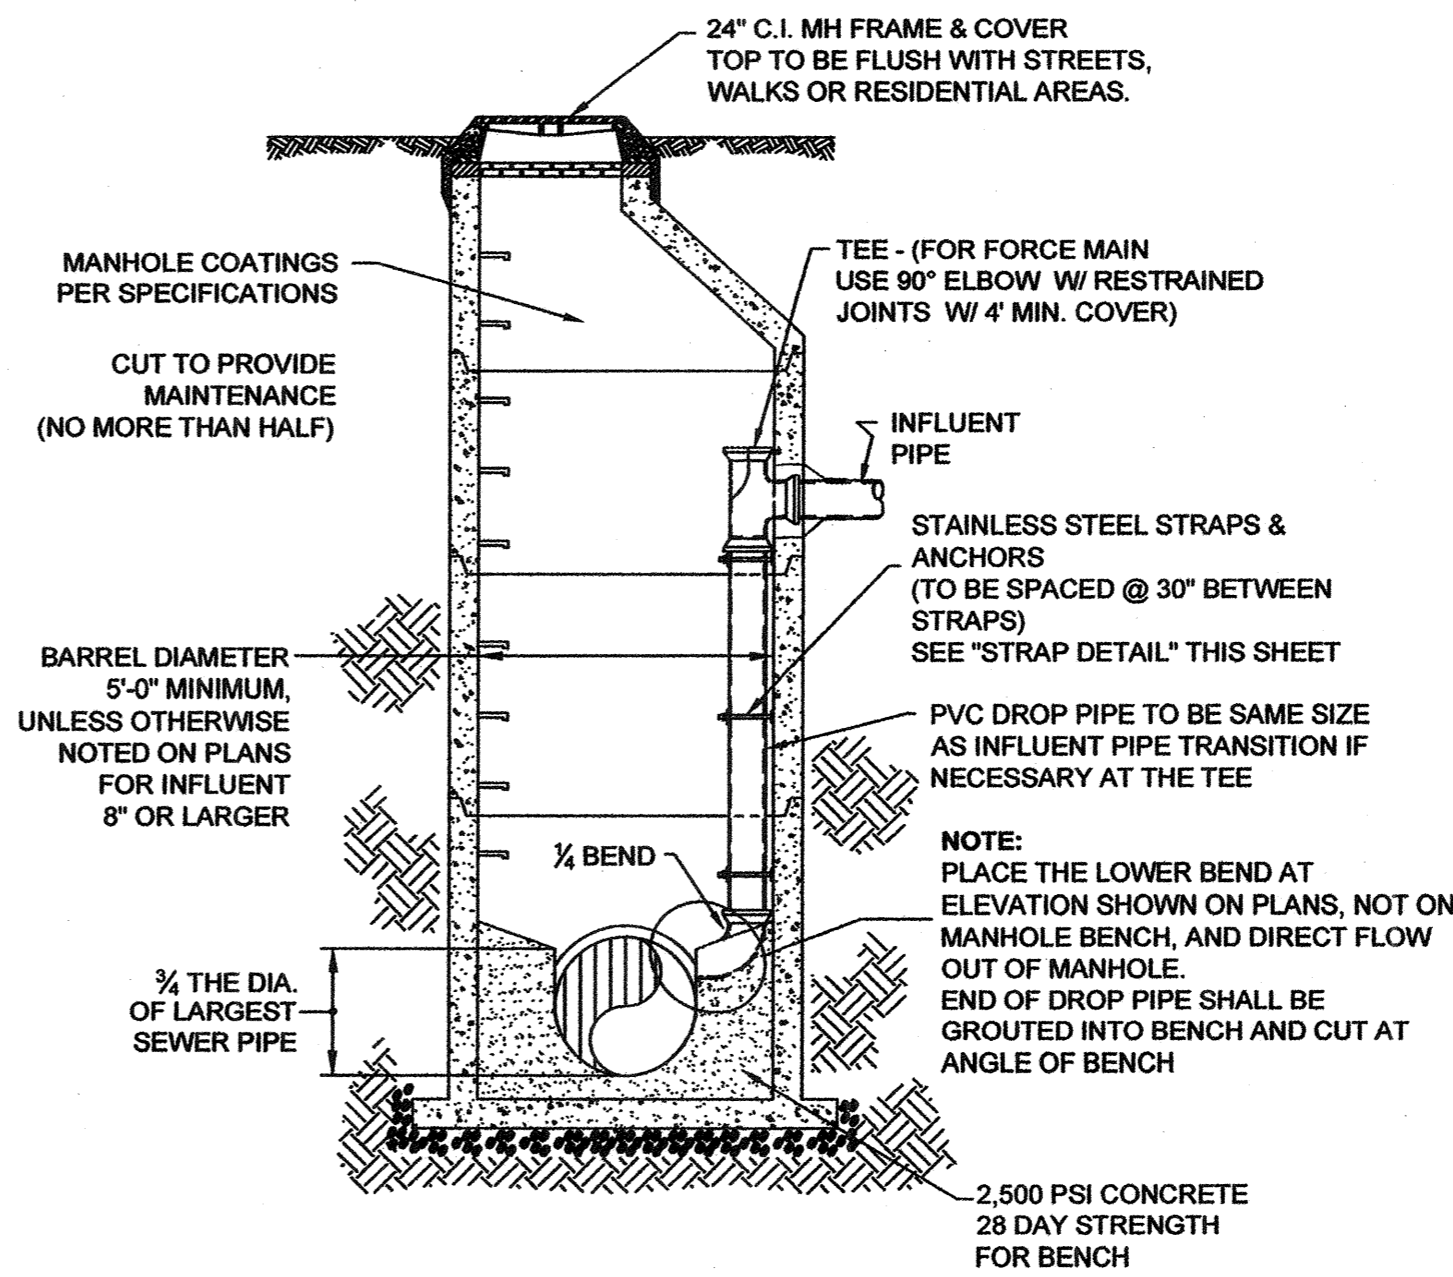


DROP MANHOLE

(MORE THAN 30" DROP)
NOT TO SCALE

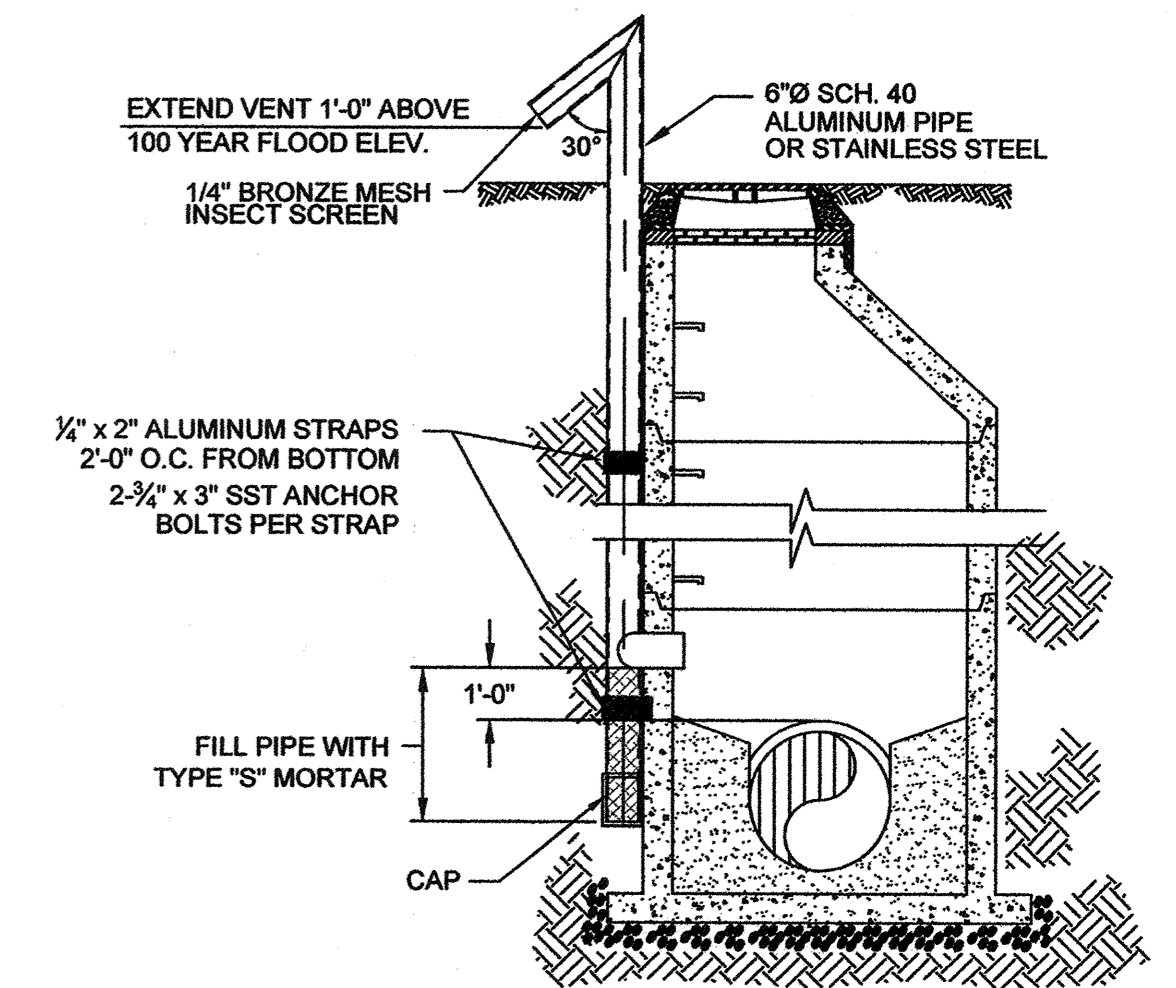


STANDARD VENT MANHOLE

NOT TO SCALE

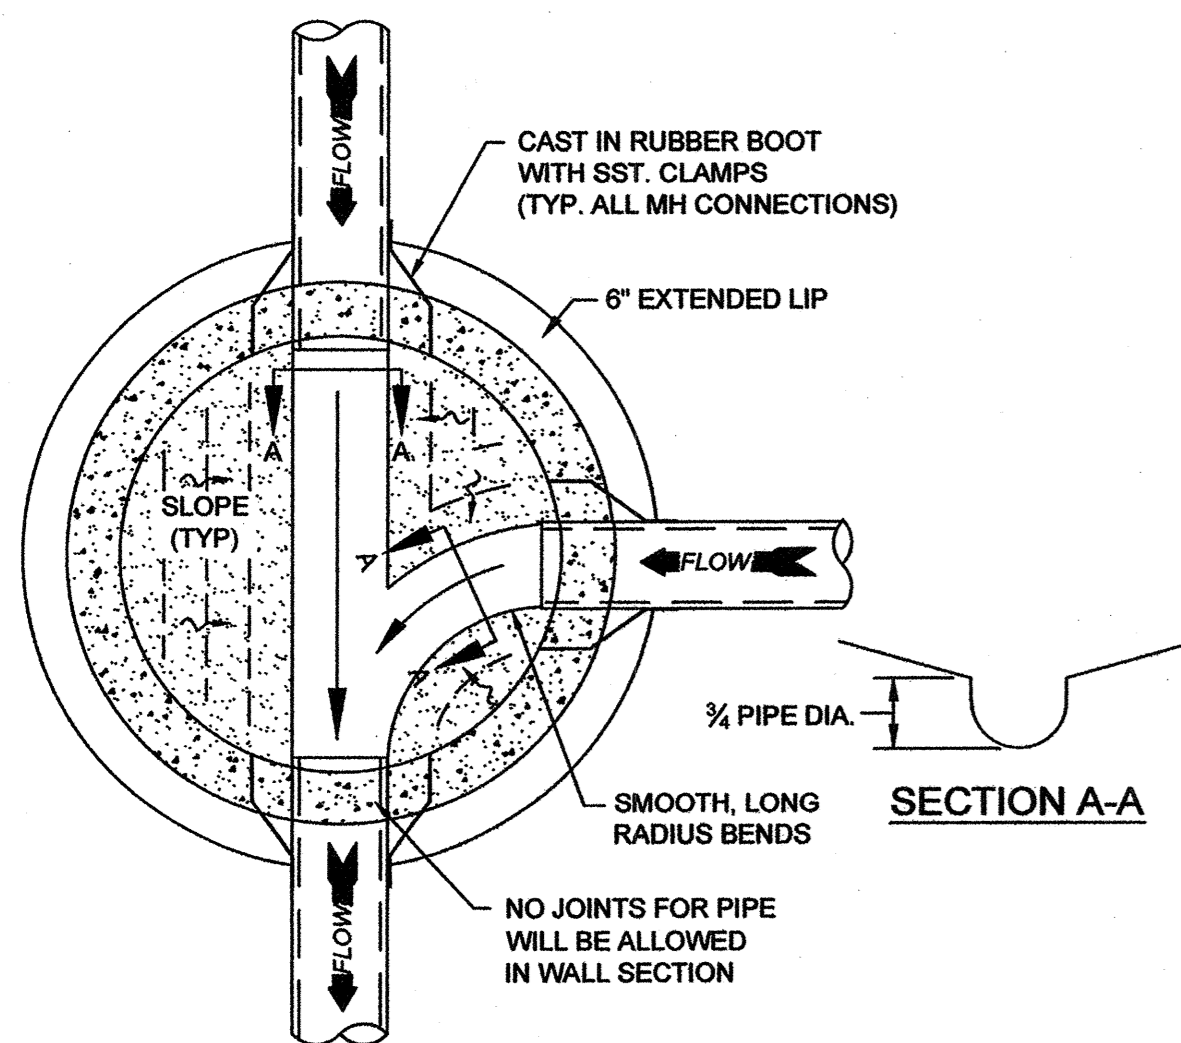

MANHOLE FLOOR PLAN


NOT TO SCALE

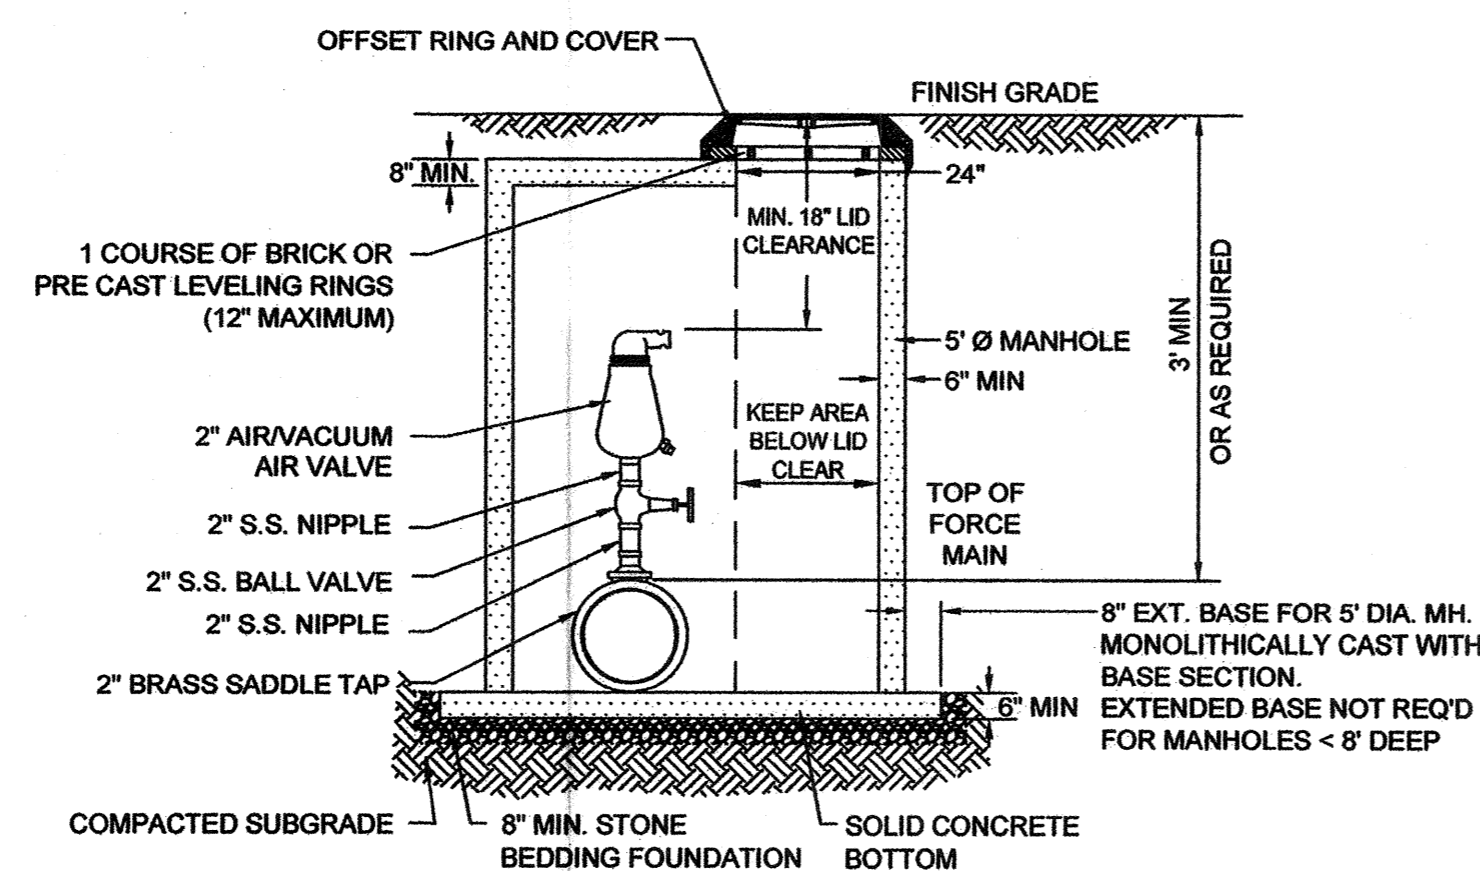

**AIR / VACUUM AND AIR
RELEASE COMBINATION VALVE**


NOT TO SCALE

- NOTES:
1. CONTRACTOR TO INSTALL VALVE & MANHOLE AT SUFFICIENT DEPTH TO ALLOW FOR ACCESS.
 2. FORCE MAIN TO BE OFFSET IN MANHOLE TO KEEP AREA BELOW LID CLEAR.
 3. REFER TO SPECIFICATIONS FOR ADDITIONAL DETAILS.
 4. USE CAST IN RUBBER BOOT WITH SST. CLAMPS FOR ALL MH CONNECTIONS INCLUDING FORCE MAIN.

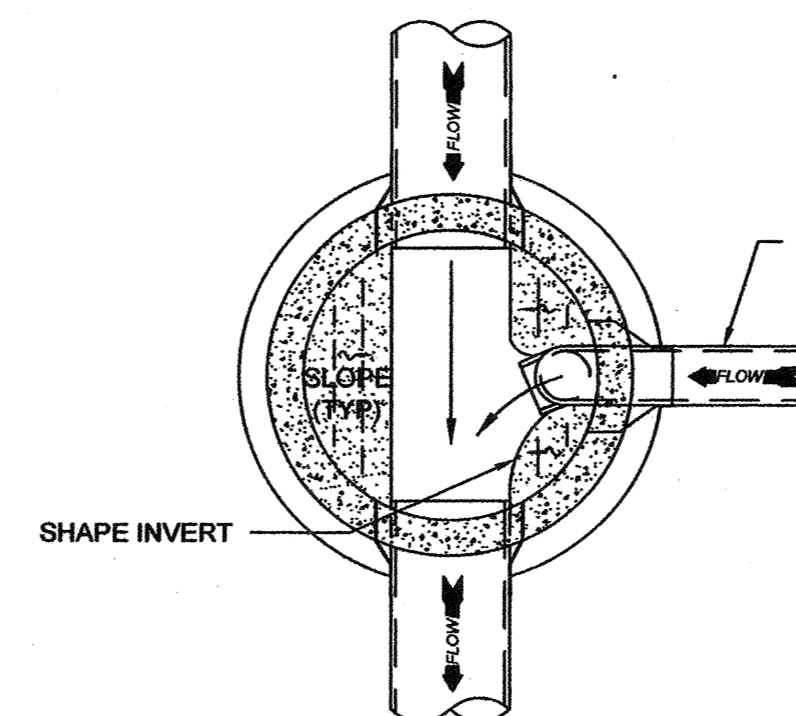

DROP MANHOLE FLOOR PLAN

NOT TO SCALE

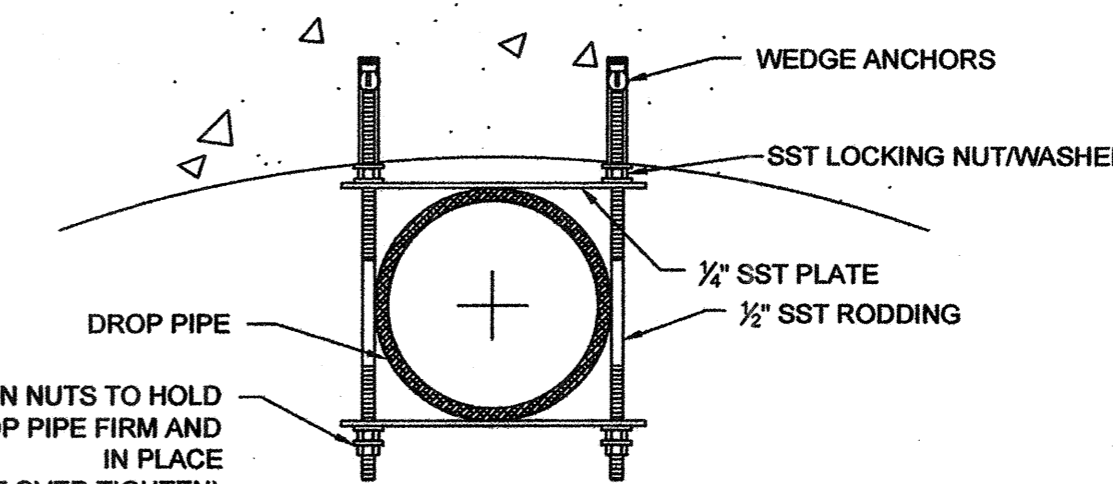

STRAP DETAIL

NOT TO SCALE

NOTE: ALL PARTS TO BE SST.

CAPE FEAR PUBLIC UTILITY AUTHORITY STANDARD SEWER NOTES:

1. SEWER GUARDS REQUIRED AT ALL MANHOLES. STAINLESS STEEL SEWER GUARDS REQUIRED AT MANHOLES LOCATED IN TRAFFIC AREAS.
2. SERVICES SHALL BE PERPENDICULAR TO MAIN AND TERMINATE AT RIGHT-OF-WAY LINE. SERVICES IN CUL-DE-SACS ARE REQUIRED TO BE PERPENDICULAR, OR MUST ORIGINATE IN MANHOLE AND TERMINATE AT RIGHT-OF-WAY LINE.
3. ALL SERVICES TYING INTO DUCTILE IRON MAINS SHALL BE CONSTRUCTED OF CLASS 50, DIP, WITH PROTECTO 401 CERAMIC EPOXY LINING.
4. MINIMUM 10' UTILITIES EASEMENT PROVIDED ALONG THE FRONTAGE OF ALL LOTS AND AS SHOWN FOR NEW DEVELOPMENTS.
5. NO FLEXIBLE COUPLINGS SHALL BE USED.
6. ALL STAINLESS STEEL FASTENERS SHALL BE 316.

STANDARD SEWER NOTES

(REQUIRED ON ALL SEWER PLAN AND PROFILE SHEETS)


GENERAL NOTES:

1. NO EXCAVATED MATERIAL SHALL BE PLACED IN ANY STREAM, DITCH OR DRAINAGE-WAY.
2. THE CONTRACTOR IS RESPONSIBLE FOR LOCATING ALL UNDERGROUND UTILITIES BEFORE ANY CONSTRUCTION BEGINS.
3. THE CONTRACTOR IS RESPONSIBLE FOR TEMPORARY SEDIMENT AND EROSION CONTROL MEASURES WHILE CONSTRUCTION IS IN PROGRESS.
4. THE CONTRACTOR IS RESPONSIBLE FOR STABILIZATION OF ALL DISTURBED AREAS.
5. THE CONTRACTOR IS RESPONSIBLE FOR LAY DOWN & STOCKPILE AREAS (TO ARRANGE AND INSURE COMPLIANCE WITH ALL LOCAL AND STATE REGULATIONS).

**THE DETAILS SHOWN HEREON SUPERCEDE CFPUA
WRITTEN TECHNICAL SPECIFICATIONS VERSIONS 1.00 - 1.04**

CFPUA SANITARY SEWER

STANDARD DETAILS

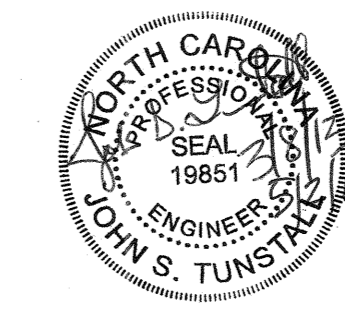


CAPE FEAR PUBLIC UTILITY AUTHORITY
235 GOVERNMENT CENTER DRIVE
WILMINGTON, NC 28403
OFFICE: (910)332-6560

DATE:
1/9/12
SCALE:
N/A
DRAWN BY:
CFPUA
CHECKED BY:
CFPUA
PROJECT NO.:

SHEET NO:
SSD-1

REV:	DESCRIPTION:	DATE:
1	AIR / VACUUM AND AIR RELEASE COMBINATION VALVE REVISED	10/26/12
2	STANDARD SEWER NOTE #6 REVISED	12/10/12


THESE DETAILS ARE A WORK PRODUCT OF CFPUA FOR WATER AND SEWER SYSTEM DESIGN AND CONSTRUCTION AND HAVE BEEN REVIEWED AND APPROVED FOR CONTENT AND GENERAL CONFORMANCE WITH THE WATER AND SEWER DESIGN FOR THIS PROJECT.

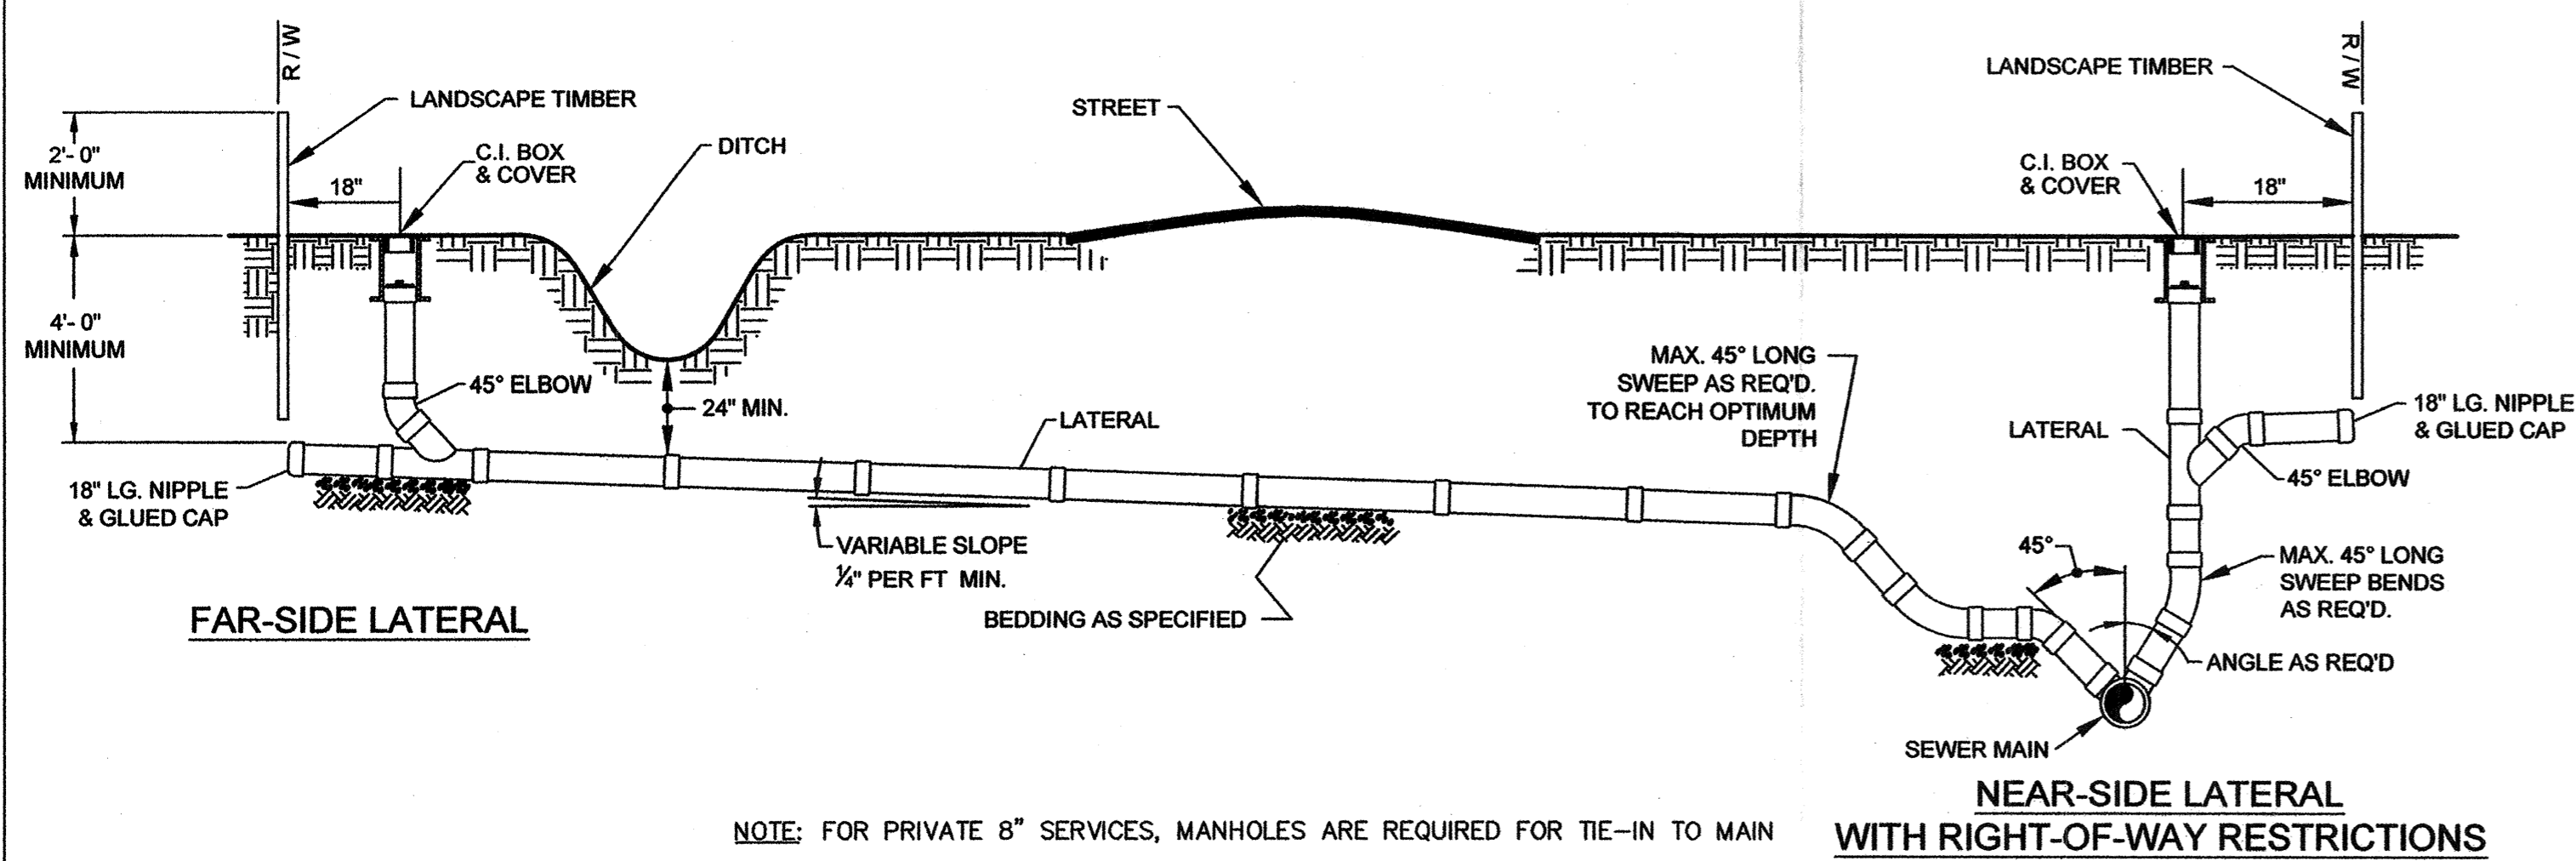

NOTE: FOR PRIVATE 8" SERVICES, MANHOLES ARE REQUIRED FOR TIE-IN TO MAIN

STANDARD SERVICE CONNECTION TO SANITARY SEWER


NOT TO SCALE

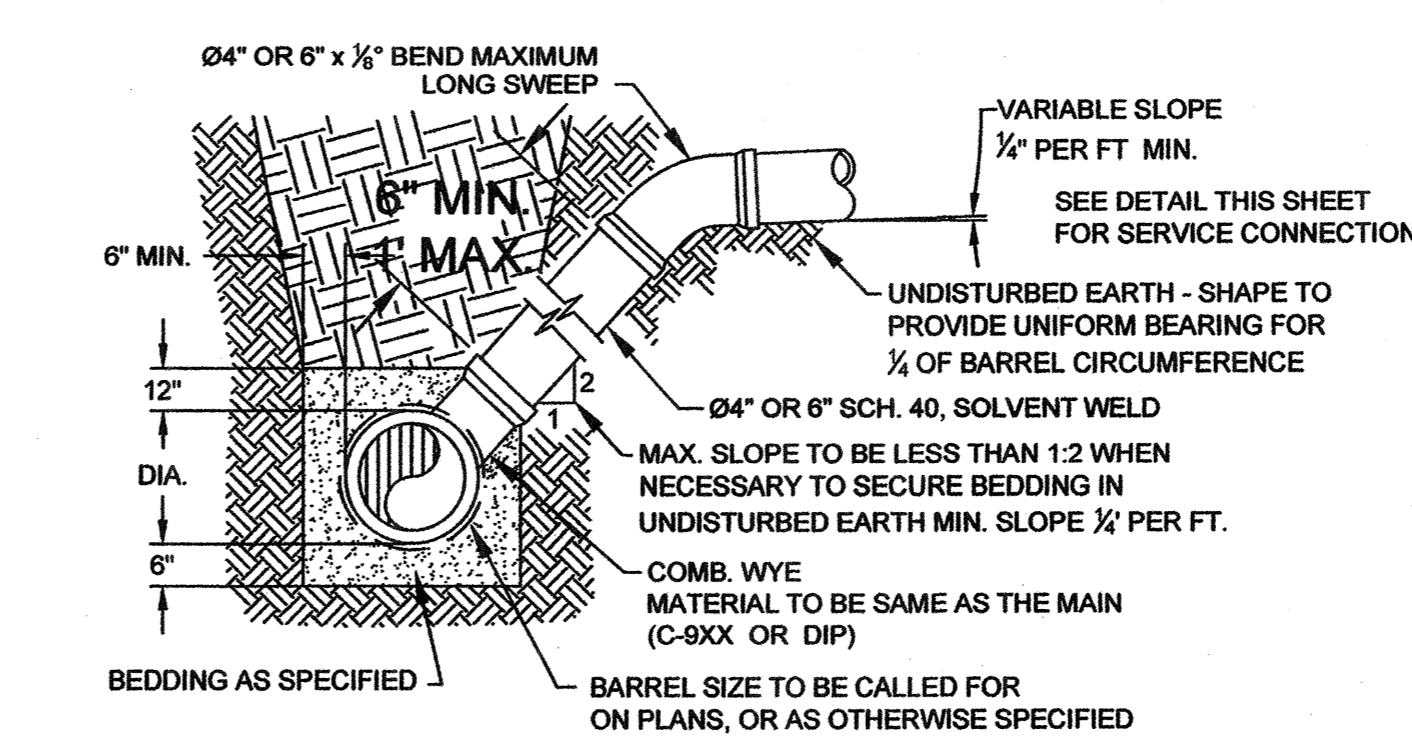

NOTE: FOR PRIVATE 8" SERVICES, MANHOLES ARE REQUIRED FOR TIE-IN TO MAIN

STANDARD SERVICE LATERAL


(MAIN DEPTH LESS THAN 8ft)
NOT TO SCALE

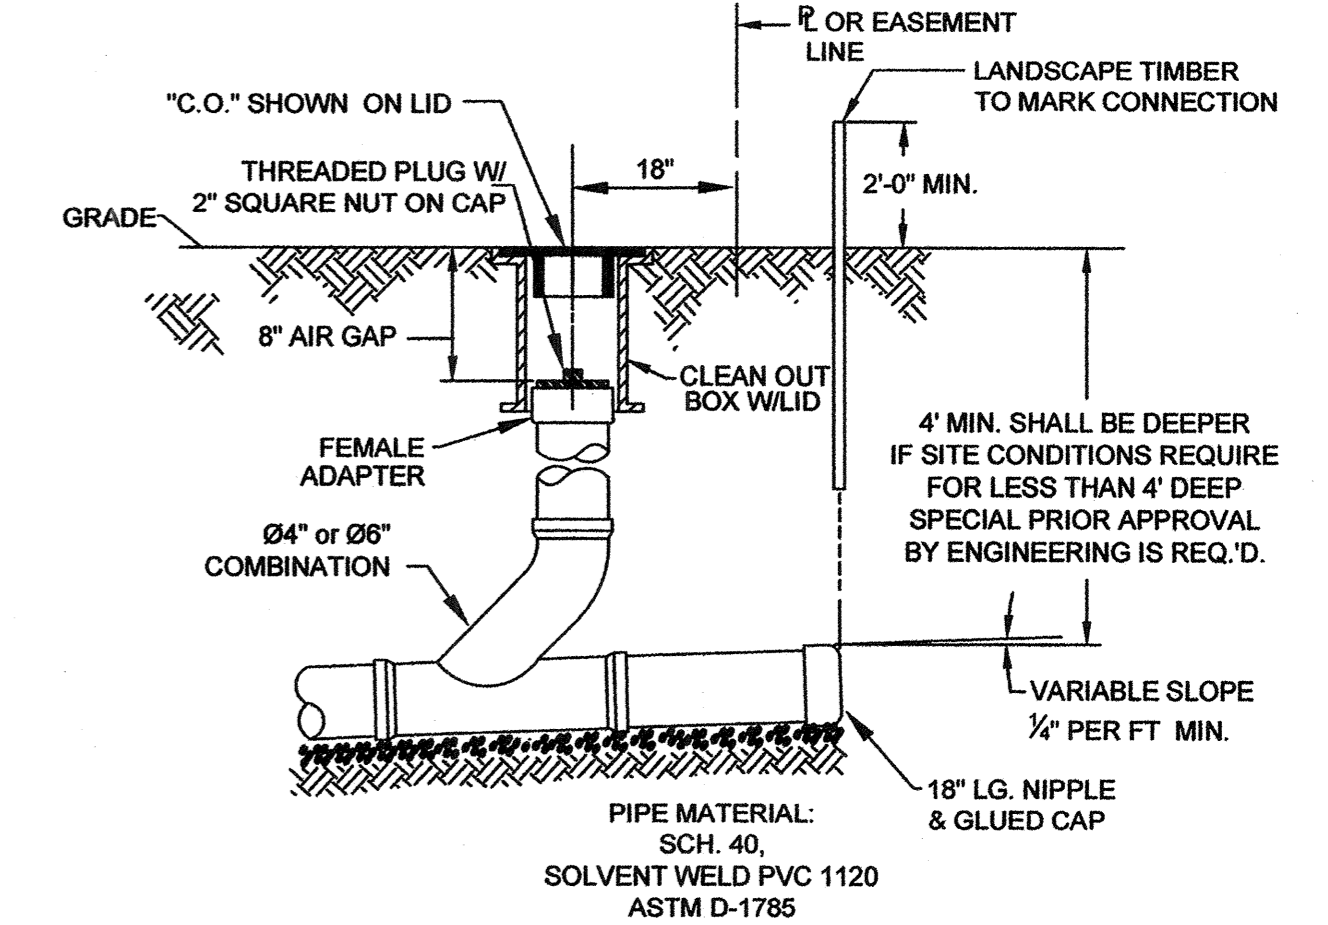

NOTE: FOR PRIVATE 8" SERVICES, MANHOLES ARE REQUIRED FOR TIE-IN TO MAIN

SERVICE CONNECTION & CLEAN-OUT

NOT TO SCALE

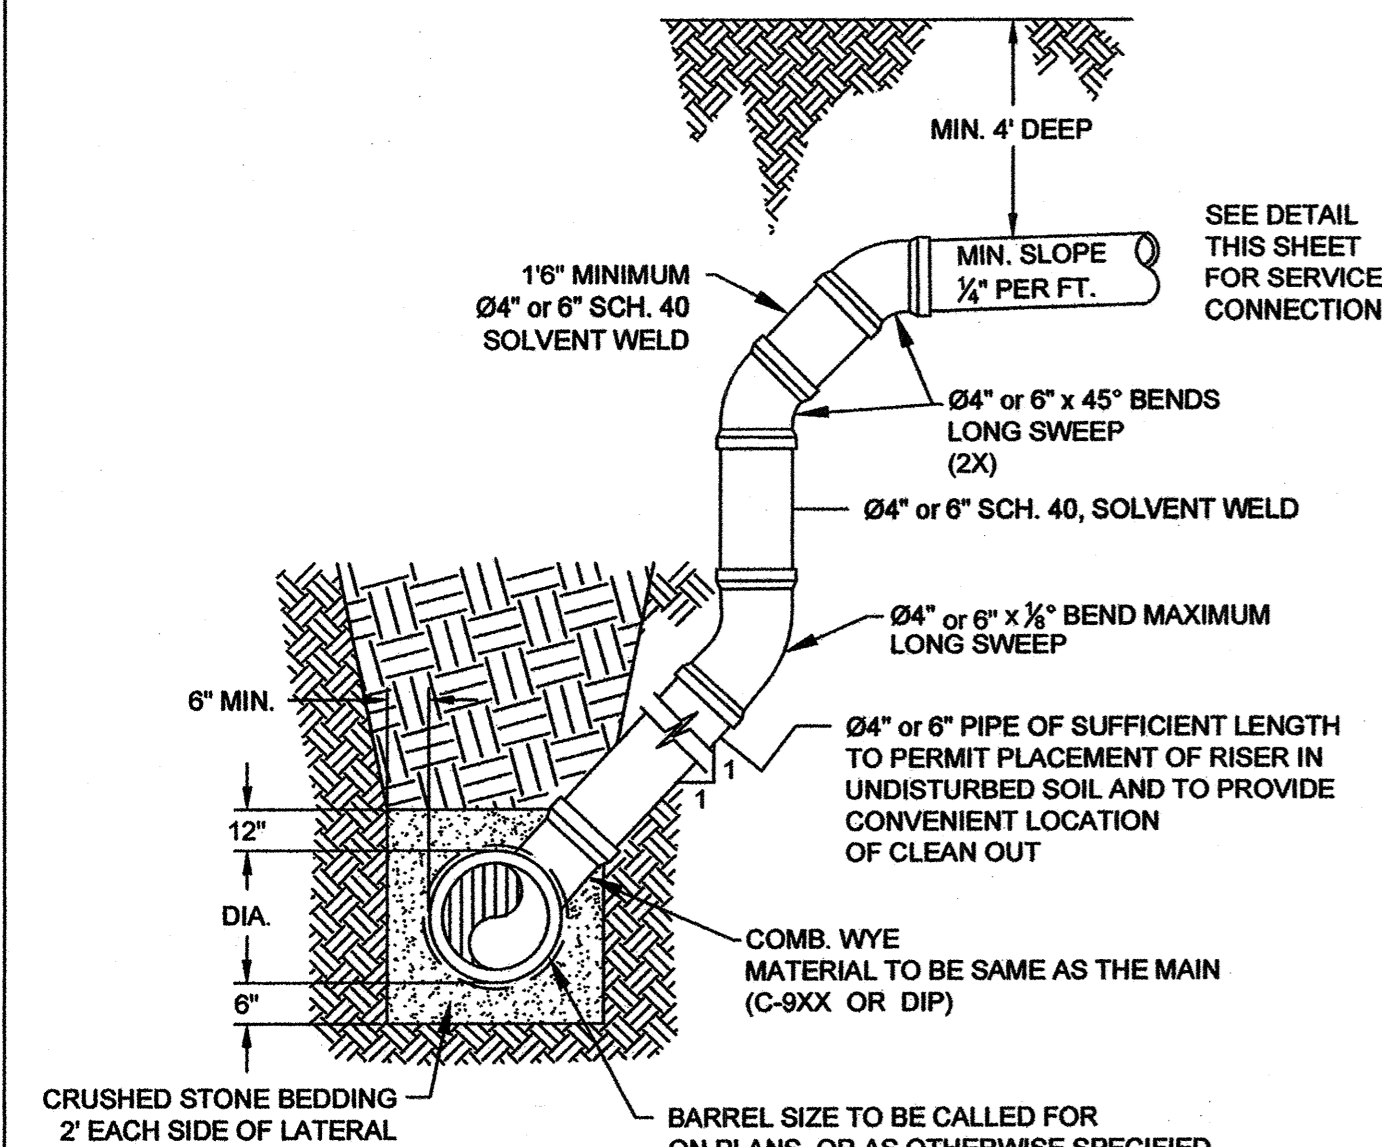


NOTE: SPECIAL CARE SHALL BE TAKEN DURING BACKFILL OPERATIONS. THE RISER SHALL BE PLUMB AND TRUE AT ALL TIMES, AND REST ON FIRM, STABLE FOUNDATION. FOR PRIVATE 8" SERVICES, MANHOLES ARE REQUIRED FOR TIE-IN TO MAIN

DEEP SERVICE LATERAL

(MAIN DEPTH GREATER THAN 8ft)


NOT TO SCALE

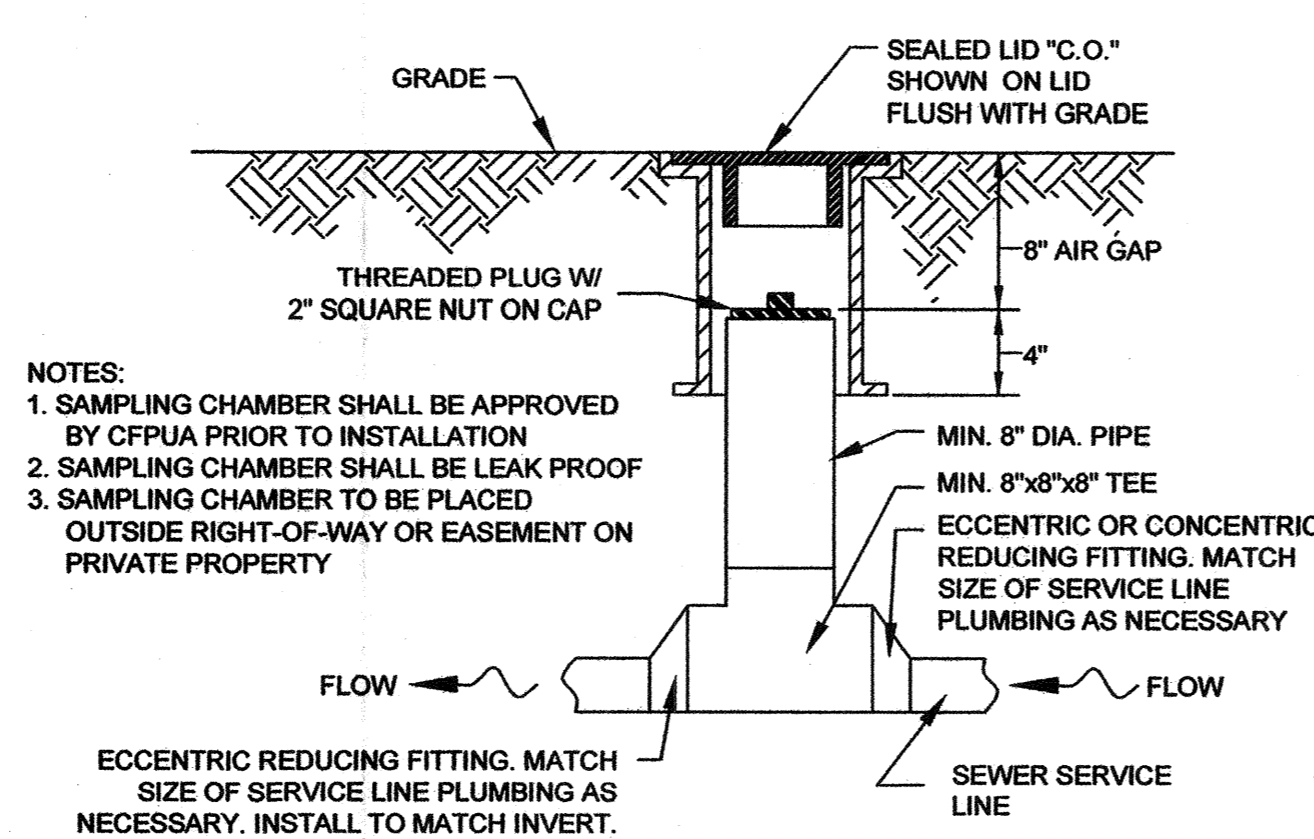

NOTES:
1. SAMPLING CHAMBER SHALL BE APPROVED BY CFPWA PRIOR TO INSTALLATION
2. SAMPLING CHAMBER SHALL BE LEAK PROOF
3. SAMPLING CHAMBER TO BE PLACED OUTSIDE RIGHT-OF-WAY OR EASEMENT ON PRIVATE PROPERTY

SAMPLING CHAMBER

NOT TO SCALE

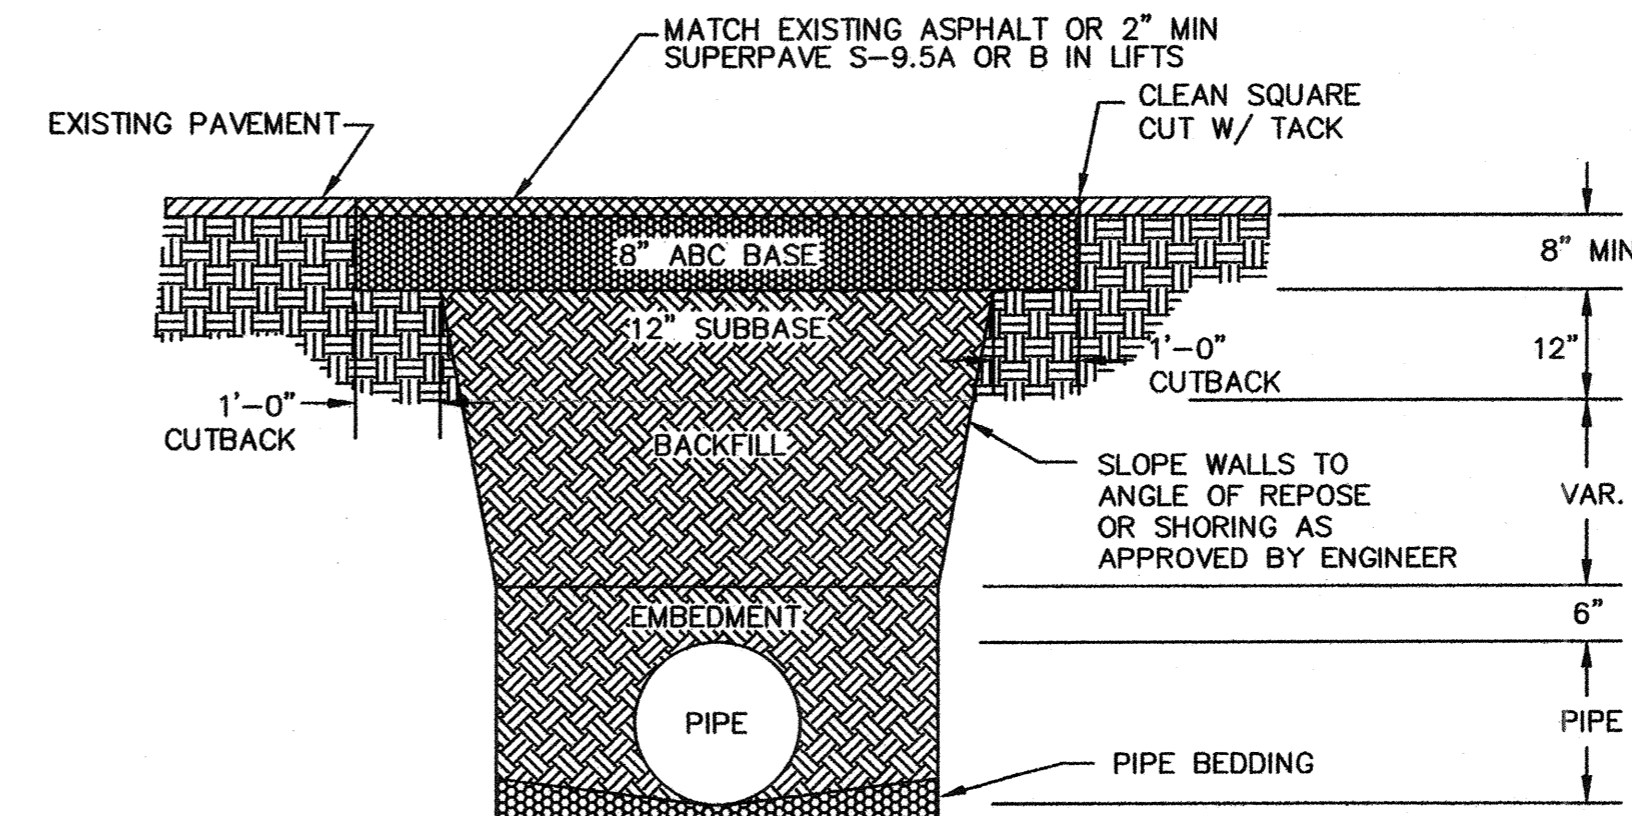


NOTES:
1. BACKFILL SHALL BE SUITABLE MATERIAL THAT IS FREE FROM HEAVY CLAY, GUMBOS, DEBRIS, ORGANICS AND LITTLE TO NO EXCESSIVE MOISTURE.
2. SELECT BACKFILL MAY BE SUBSTITUTED OR REQUIRED BY CITY TO ACHIEVE COMPACTION, (I.E. #57, ABC, CRUSHED LIMESTONE, CLEAN SAND, FLOWABLE FILL, ETC.)
3. 8-INCH OF ABC BASE MATERIAL SHALL BE USED ON CITY STREETS.
4. BACKFILL AND BASE MATERIALS SHALL BE COMPACTED 12" MINIMUM LIFTS
5. SOIL SHALL BE COMPACTED BY A MECHANIZED TAMPER (I.E. JUMPING JACK), HOWEVER, VIBRATORY ROLLERS > 18" WIDTH MAY BE USED FOR LARGER EXCAVATIONS. THE PLATE TAMP METHOD SHALL NOT BE USED.
6. ALL APPROVED CASTINGS SHALL BE SET FLUSH TO GRADE AND SUPPORTED IF APPLICABLE.
7. ABC BASE AND SUBBASE COMPACTED TO 98% AND BACKFILL AND EMBEDMENT COMPACTED TO 90% AS DETERMINED BY THE MODIFIED PROCTOR AASHTO METHOD T-99.
8. 1-FOOT CUTBACKS OF ASPHALT SHALL BE PREPARED ON UNDISTURBED SOIL. MINIMUM ASPHALT DENSITY IS 90%.

PAVEMENT REPAIR WHERE PIPE INSTALLED


(FOR PRIVATE ROADS AND PAVED AREAS; CONTRACTOR TO MEET MIN. REQUIREMENTS AS DEFINED BY RIGHT-OF-WAY OWNER FOR PUBLIC ROAD REPAIRS)

NOT TO SCALE

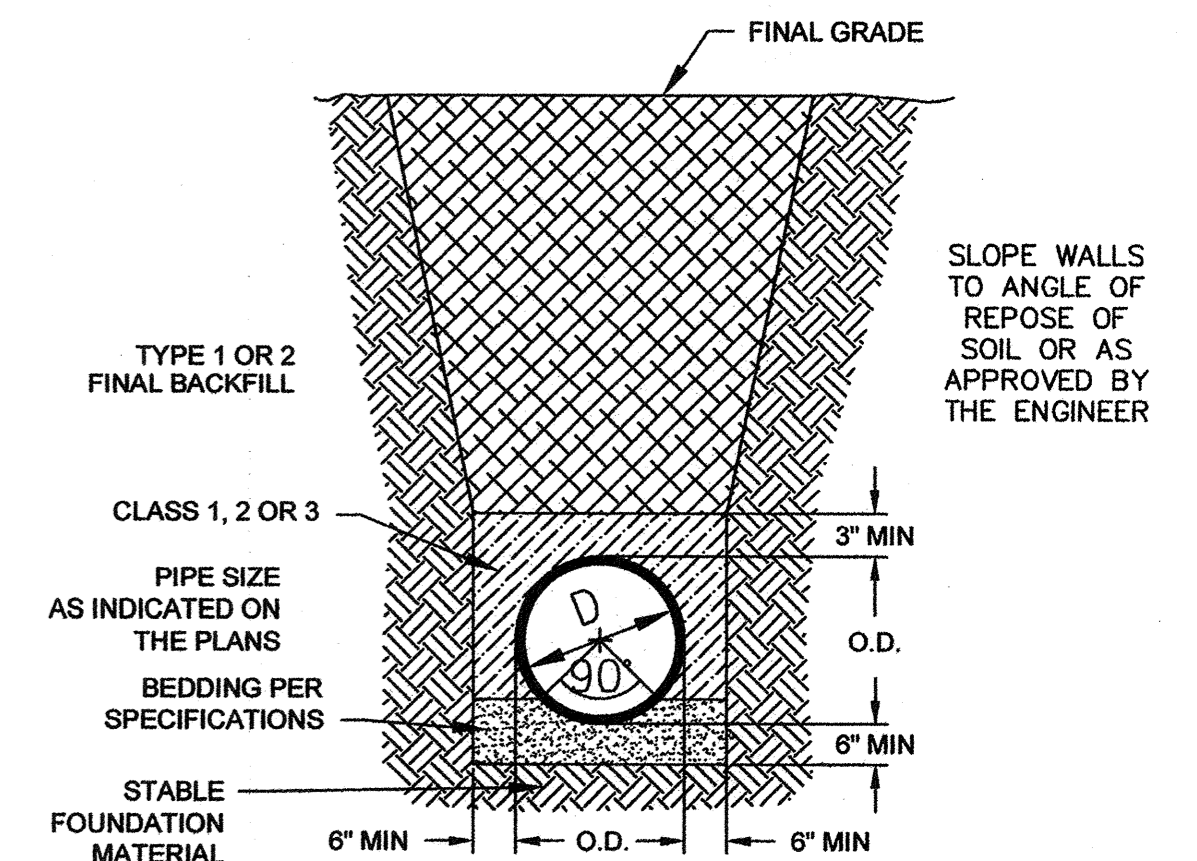

CL 50 DUCTILE IRON DR 18 PVC PIPE TRENCH DETAIL


NOT TO SCALE

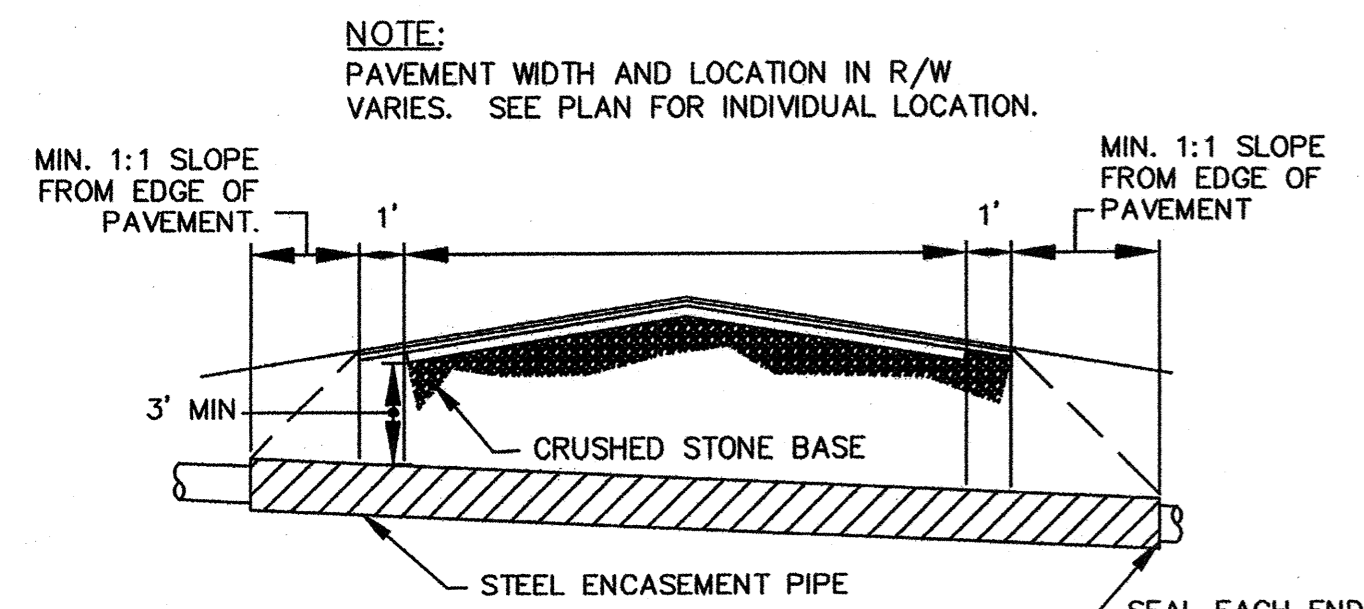


NOTES:
1. CASING WILL BE INSTALLED AT LINE AND GRADE SHOWN ON INDIVIDUAL PLAN FOR EACH CROSSING. BORING/JACKING TO LINE AND GRADE IS REQUIRED.
2. TRACER WIRE SHALL BE CONTINUED THROUGH CASING

TYPICAL BORING/JACKING DETAIL

NOT TO SCALE

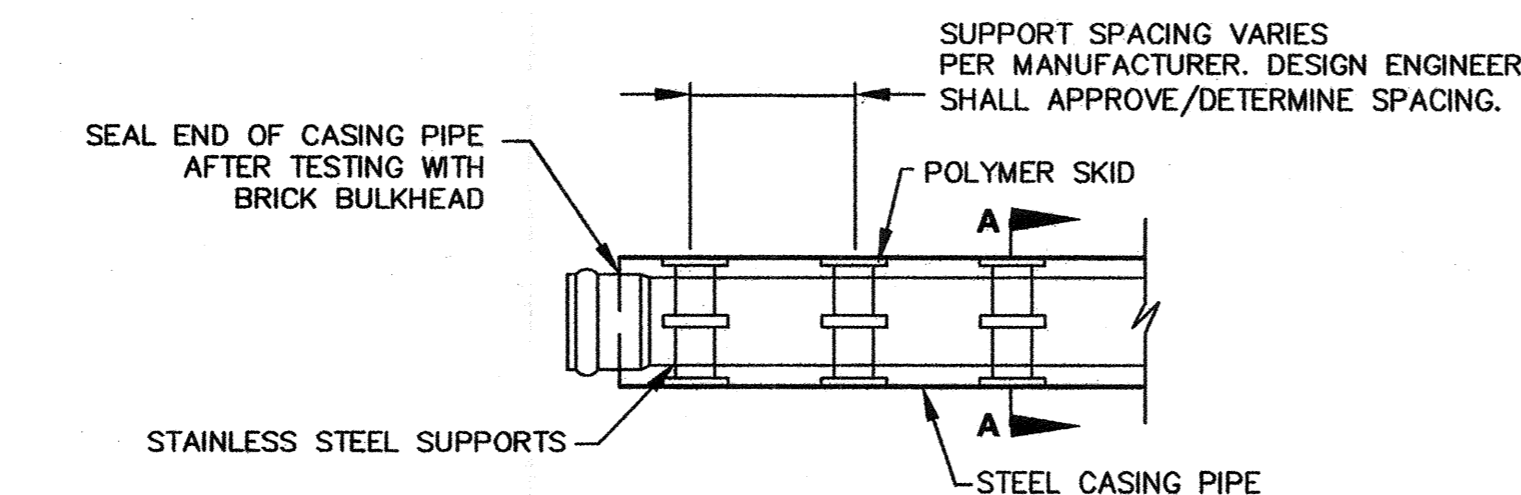

NOTE: PIPE SUPPORT TO BE PLACED TO PROVIDE PROPER SUPPORT, ALIGNMENT, AND GRADE AS SPECIFIED. CONTINUOUS SUPPORTS MAY BE USED AS ALTERNATIVE. OIL, GREASE, OR PETROLEUM PRODUCT MAY NOT BE USED AS LUBRICANT.

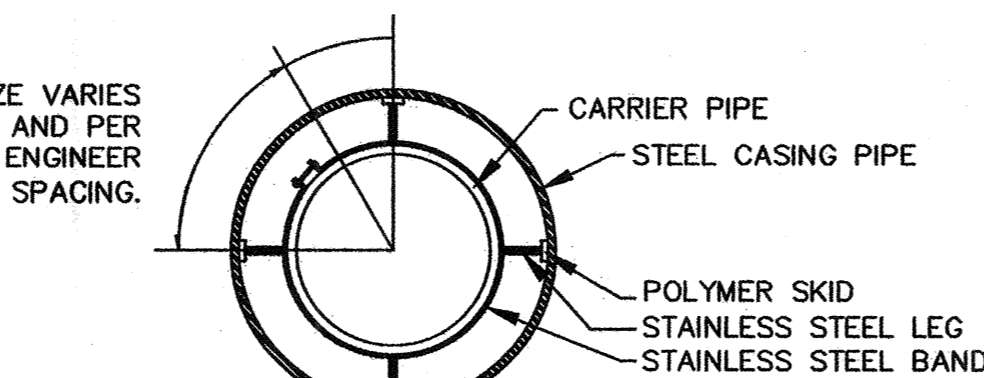

PIPE CASING SUPPORT DETAIL

NOT TO SCALE

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- THE CONTRACTOR IS RESPONSIBLE FOR TEMPORARY SEDIMENT AND EROSION CONTROL MEASURES WHILE CONSTRUCTION IS IN PROGRESS.
- THE CONTRACTOR IS RESPONSIBLE FOR STABILIZATION OF ALL DISTURBED AREAS.
- THE CONTRACTOR IS RESPONSIBLE FOR LAY DOWN & STOCKPILE AREAS (TO ARRANGE AND INSURE COMPLIANCE WITH ALL LOCAL AND STATE REGULATIONS).

THE DETAILS SHOWN HEREON SUPERCEDE CFPWA WRITTEN TECHNICAL SPECIFICATIONS VERSIONS 1.00 - 1.04

REV:	DESCRIPTION:	DATE:
1	SAMPLING CHAMBER REVISED	10/26/12

CFPUA SANITARY SEWER


STANDARD DETAILS

CAPE FEAR PUBLIC UTILITY AUTHORITY
235 GOVERNMENT CENTER DRIVE
WILMINGTON, NC 28403
OFFICE: (910)832-6660

DATE: 1/9/12
SCALE: N/A
DRAWN BY: CFPWA
CHECKED BY: CFPWA
PROJECT NO.:

SHEET NO:
SSD-2


THESE DETAILS ARE A WORK PRODUCT OF CFPWA FOR WATER AND SEWER SYSTEM DESIGN AND CONSTRUCTION AND HAVE BEEN REVIEWED AND APPROVED FOR CONTENT AND GENERAL CONFORMANCE WITH THE WATER AND SEWER DESIGN FOR THIS PROJECT.

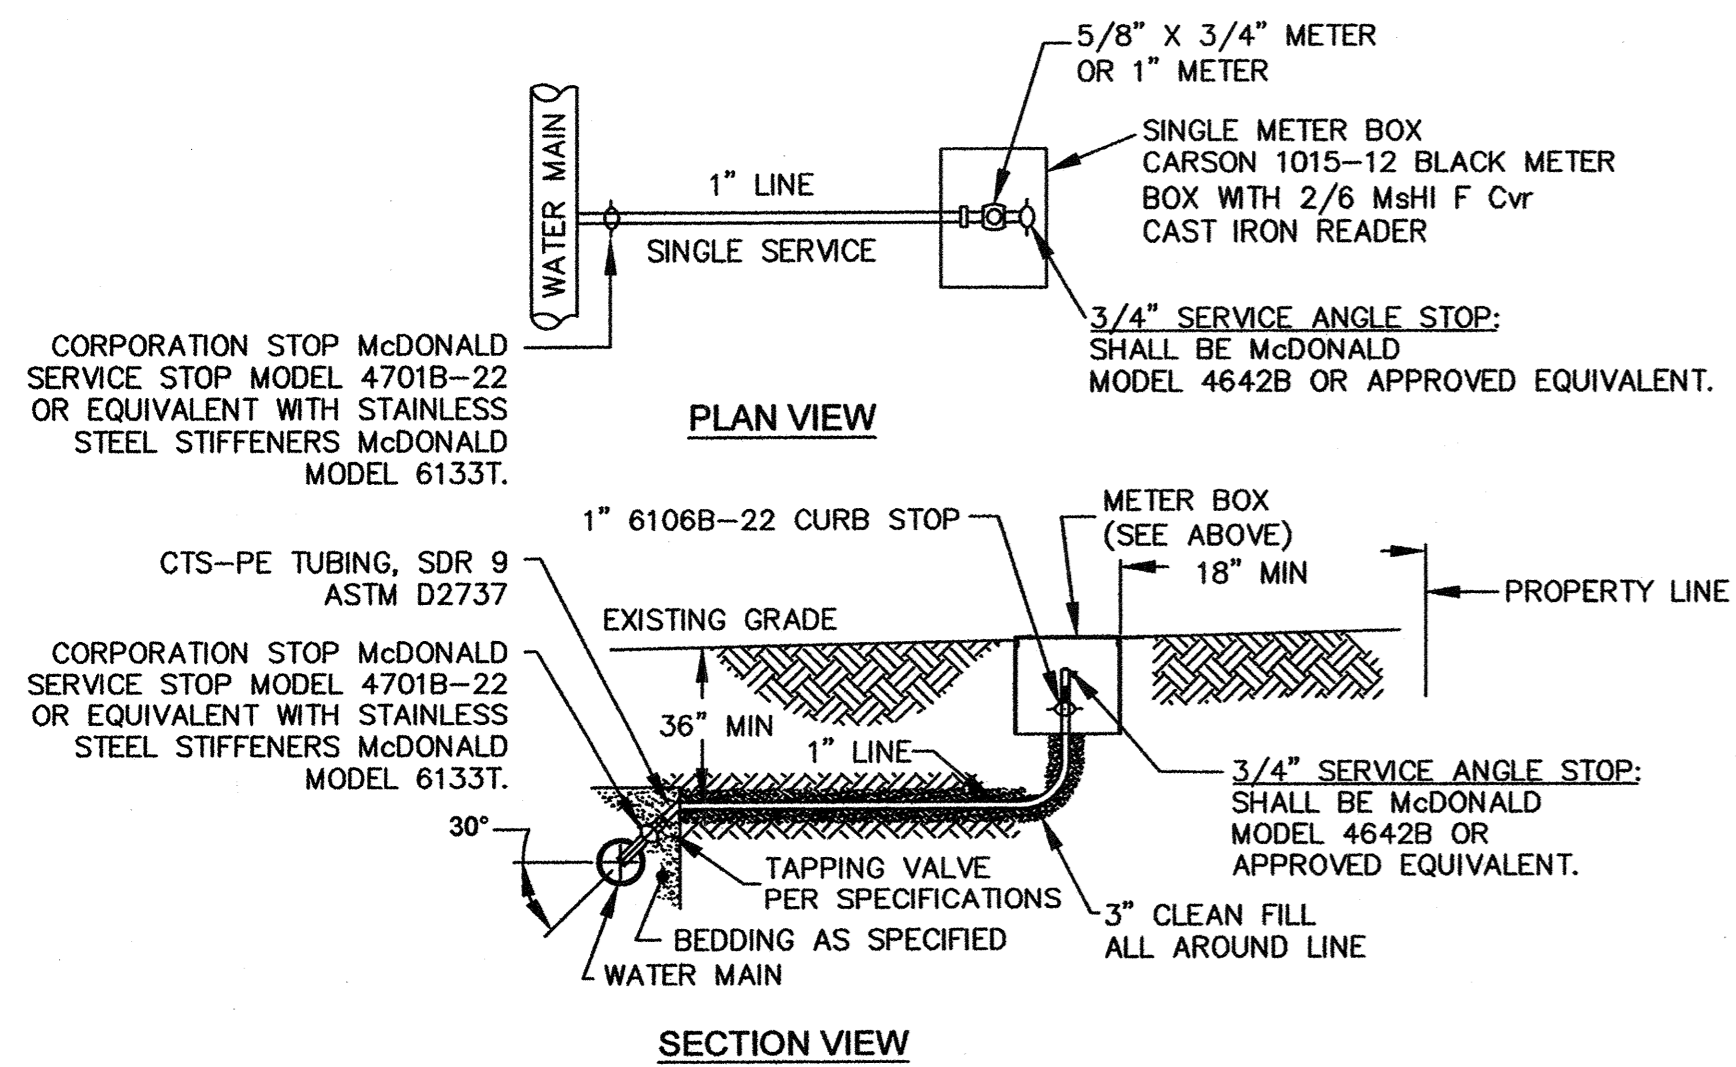


- NOTES:**
- NO JOINT SHALL BE INSTALLED BETWEEN THE MAIN SERVICE TAP AND THE METER STOP. ALL SERVICES SHALL BE INSTALLED PERPENDICULAR TO MAIN.
 - SERVICE SADDLES ON PVC MAINS SHALL BE WIDE BAND BRASS BODY; SADDLE McDONALD 3801 OR EQUIVALENT.
 - METER BOXES SUSCEPTIBLE TO TRAFFIC SHALL CONFORM TO ASTM A48, CLASS 30B AND AASHTO H20 LOAD RATING STANDARDS (SIP MODEL 4240 OR APPROVED EQUIVALENT)

SINGLE SERVICE CONNECTION




TYPICAL WATER SERVICE CONNECTION FOR RESIDENTIAL SINGLE FAMILY HOME ON CFPWA WATER SYSTEM
NOT TO SCALE

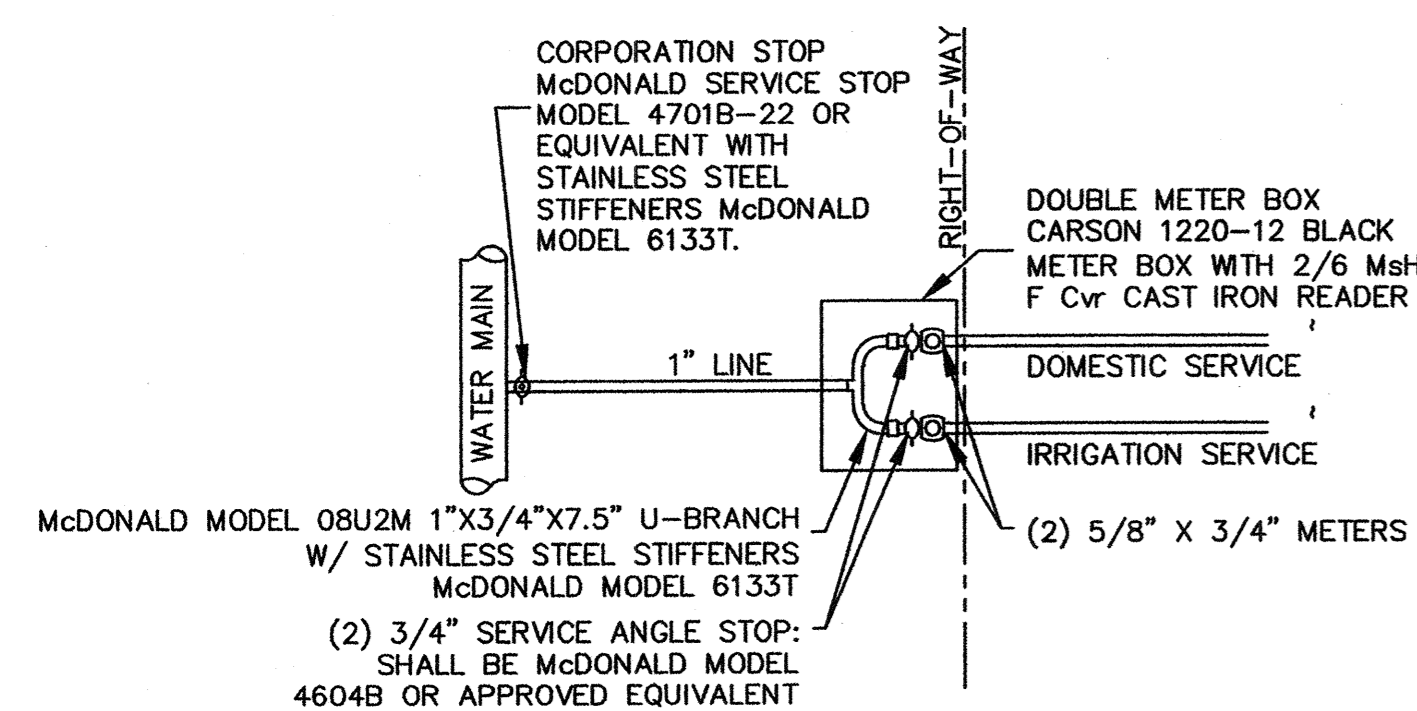

DOUBLE SERVICE CONNECTION
(ONE DOMESTIC SERVICE PER TAP)
NOT TO SCALE

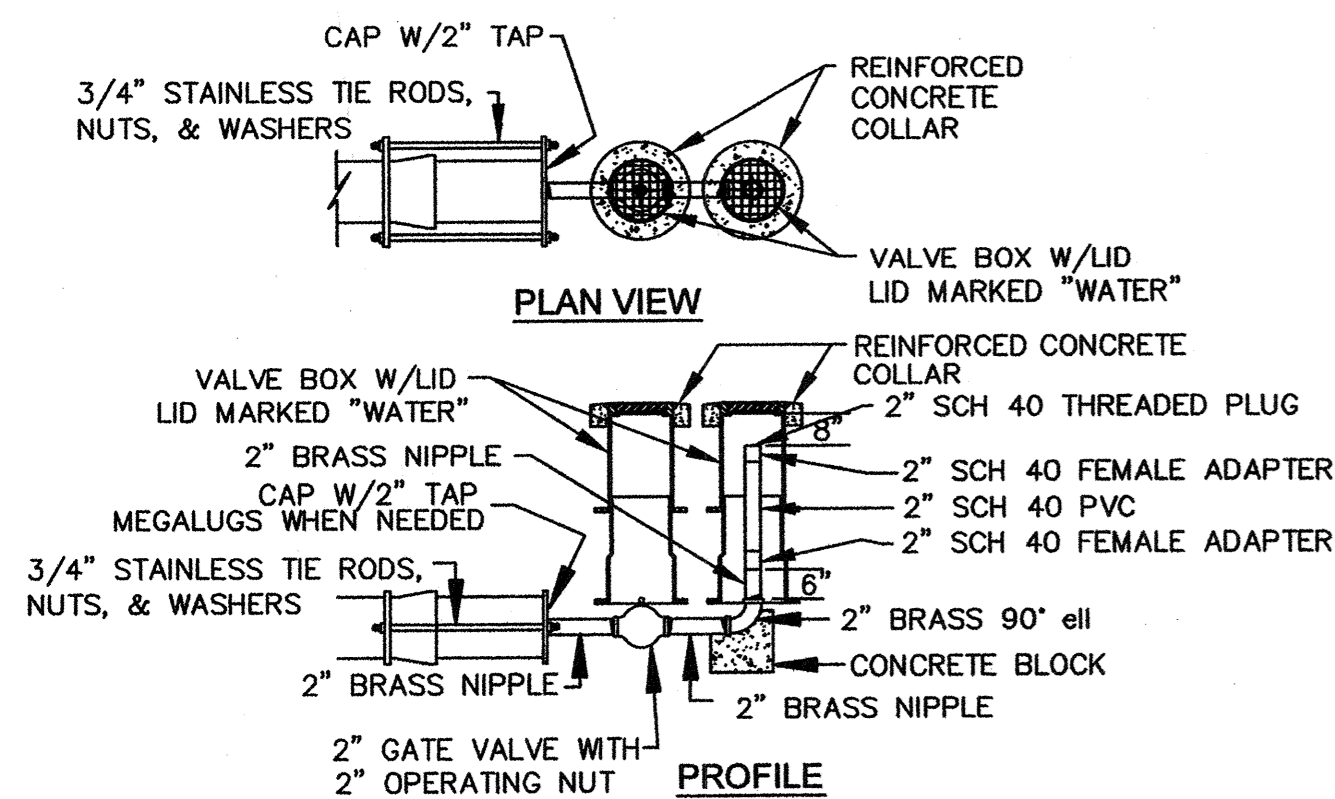


PAVED AREA UNPAVED AREA

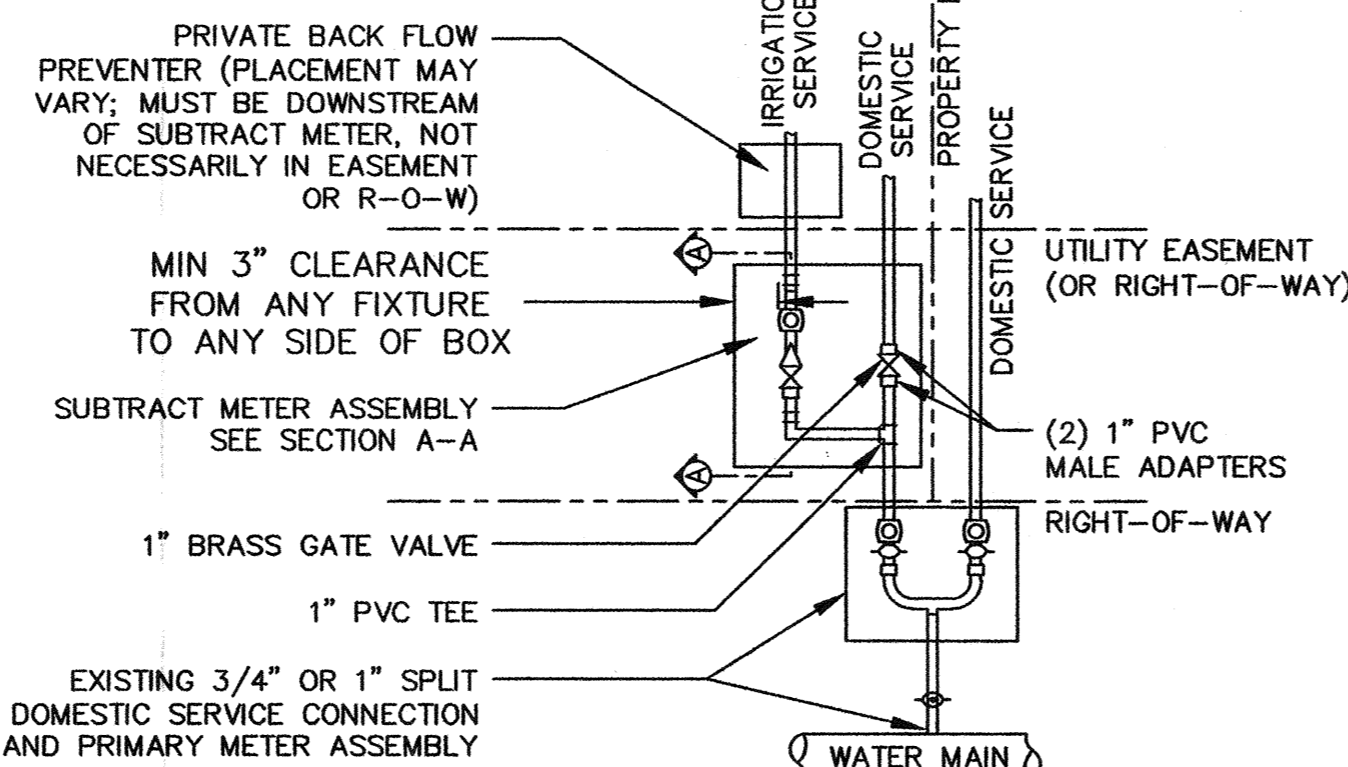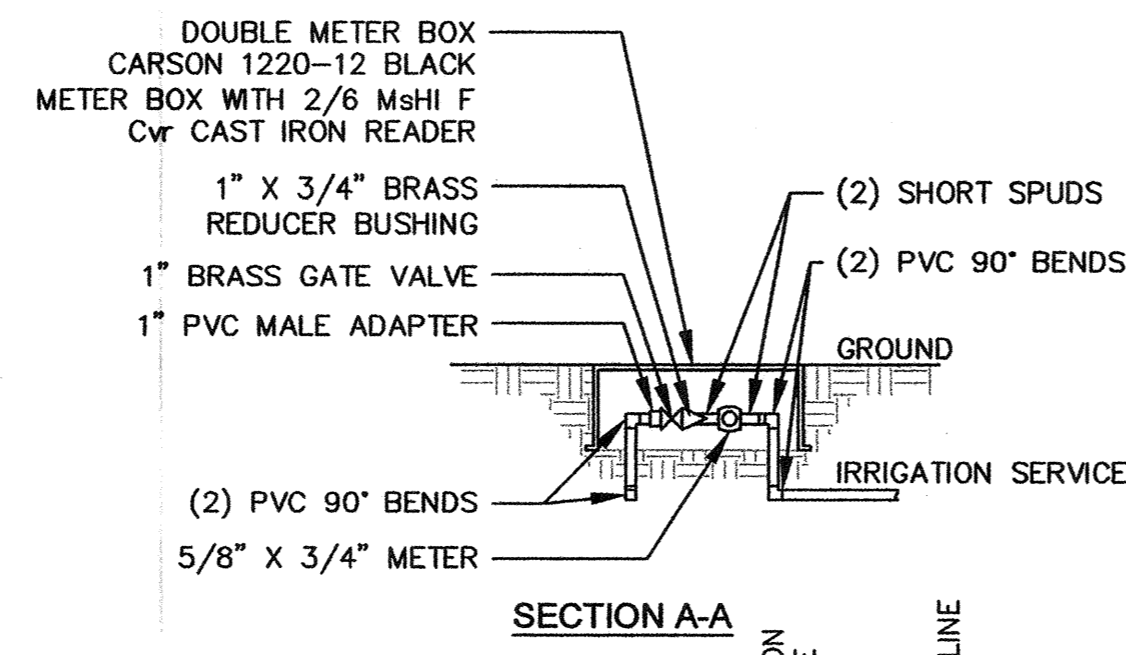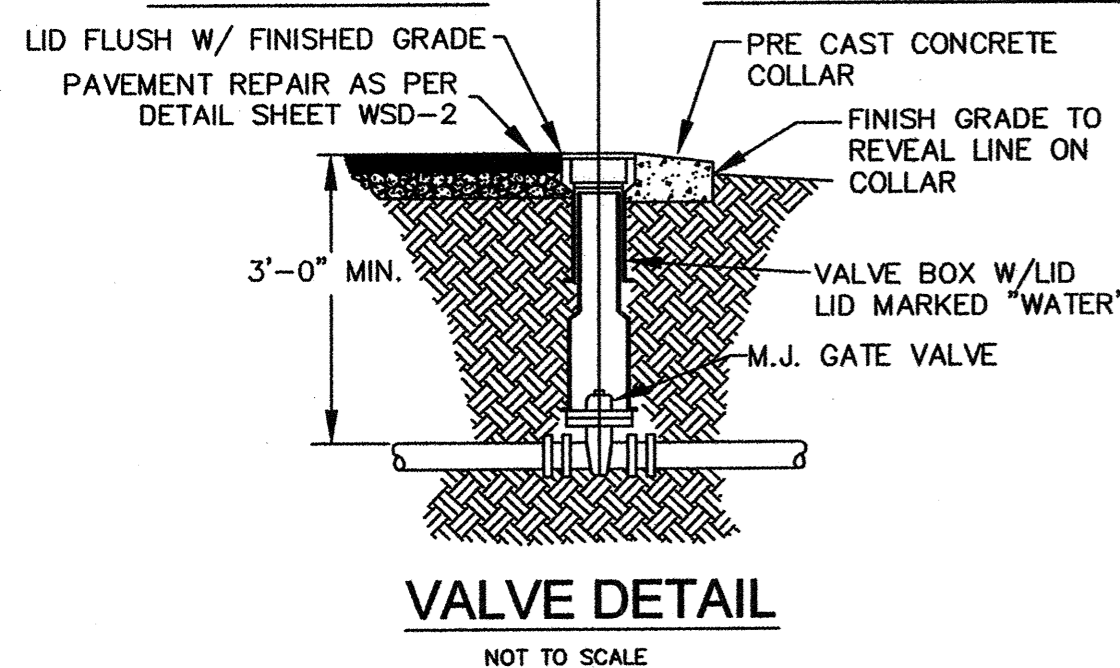

- NOTES:**
- BEYOND THE PRIMARY DOMESTIC METER ASSEMBLY, CFPWA IS ONLY RESPONSIBLE FOR METER AND WASHERS OF SUBTRACT METER ASSEMBLY
 - ALL PIPE AND FITTINGS UP TO FINAL SERVICE LINE TO BE 1" EXCLUDING METERS

DOUBLE SERVICE CONNECTION USING SUBTRACT METER



(MULTIPLE DOMESTIC SERVICES PER TAP)
NOT TO SCALE

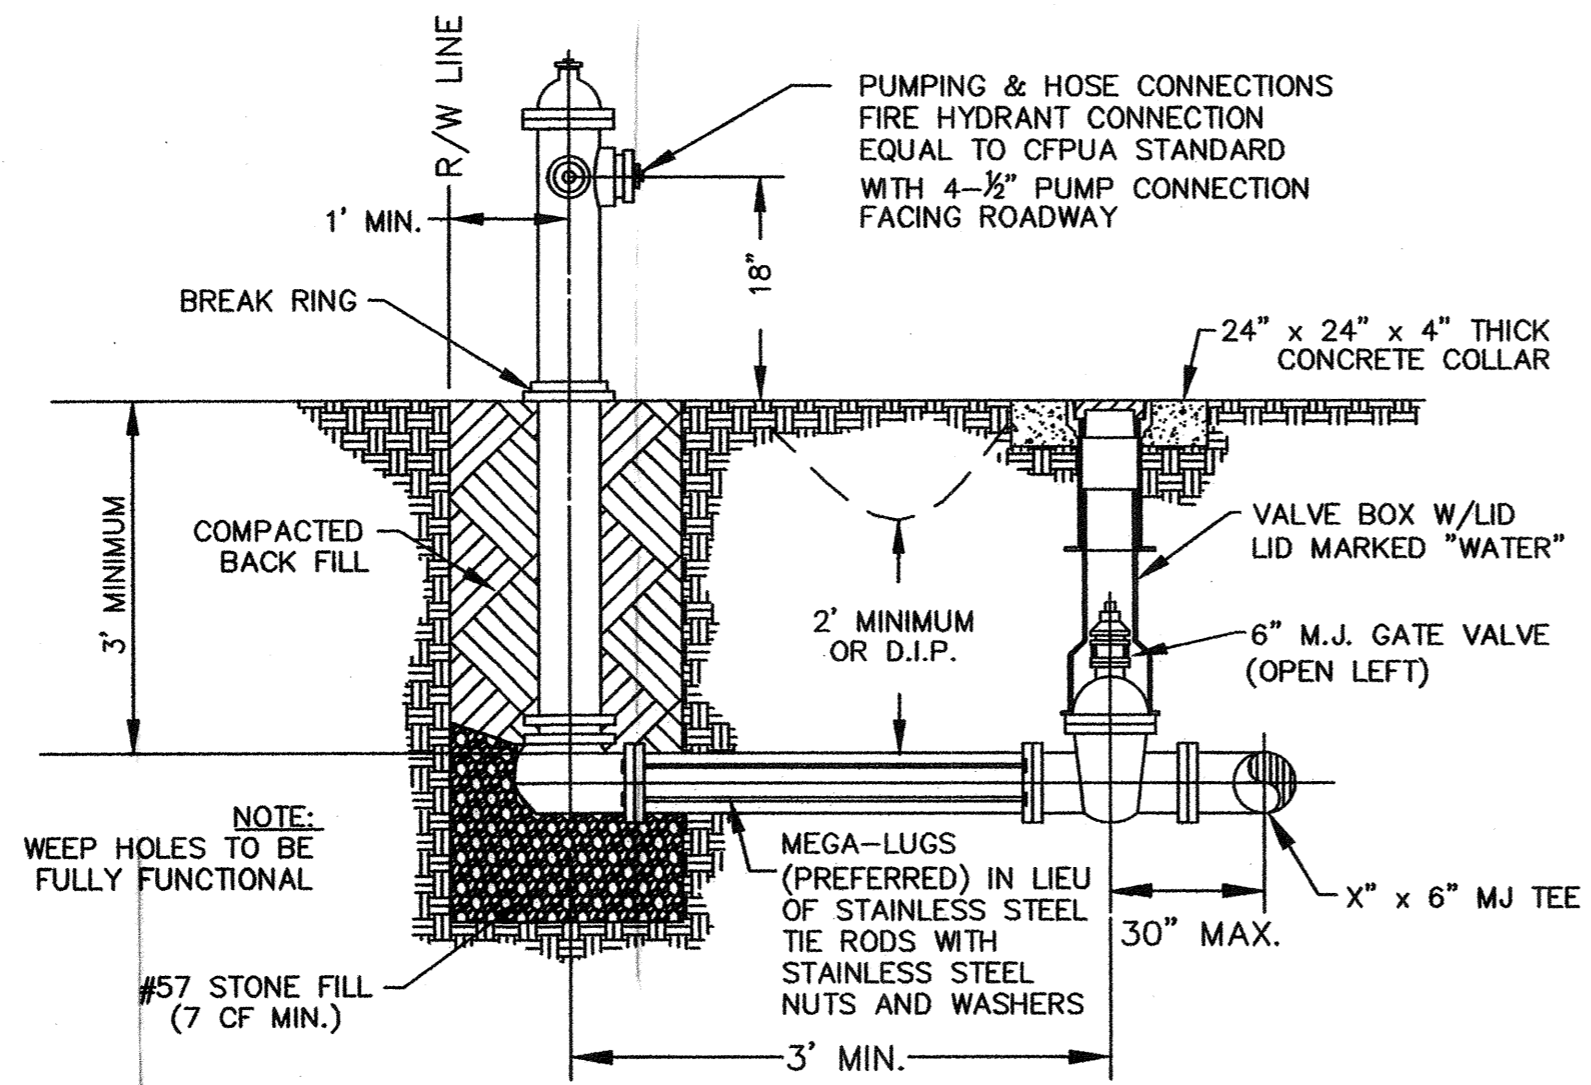


FIRE HYDRANT ASSEMBLY

NOT TO SCALE


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WATER METER VAULT
FOR WATER METERS LARGER THAN 2"

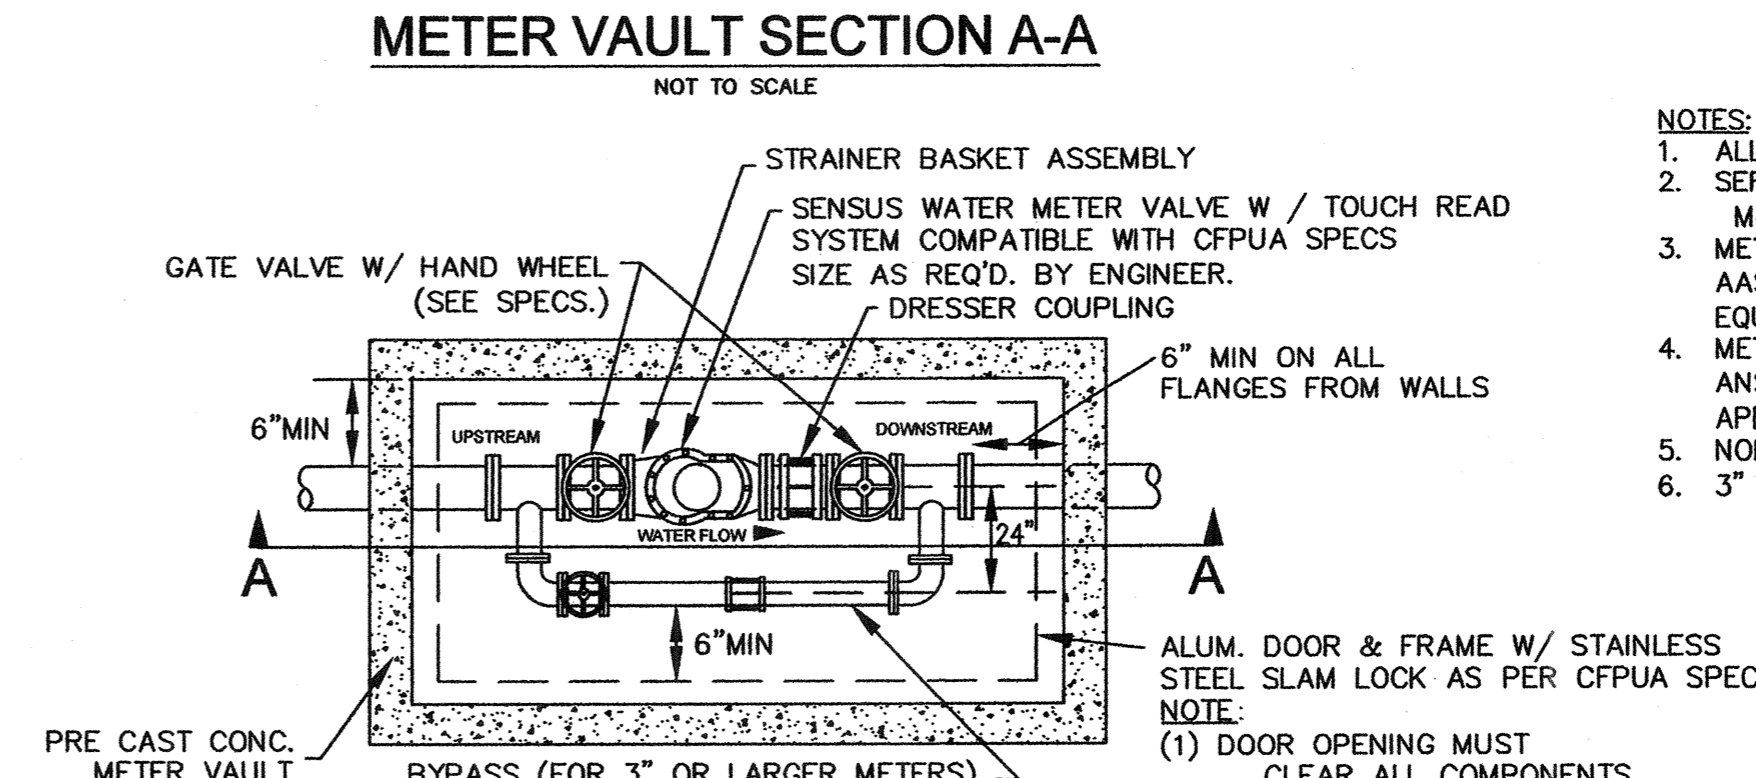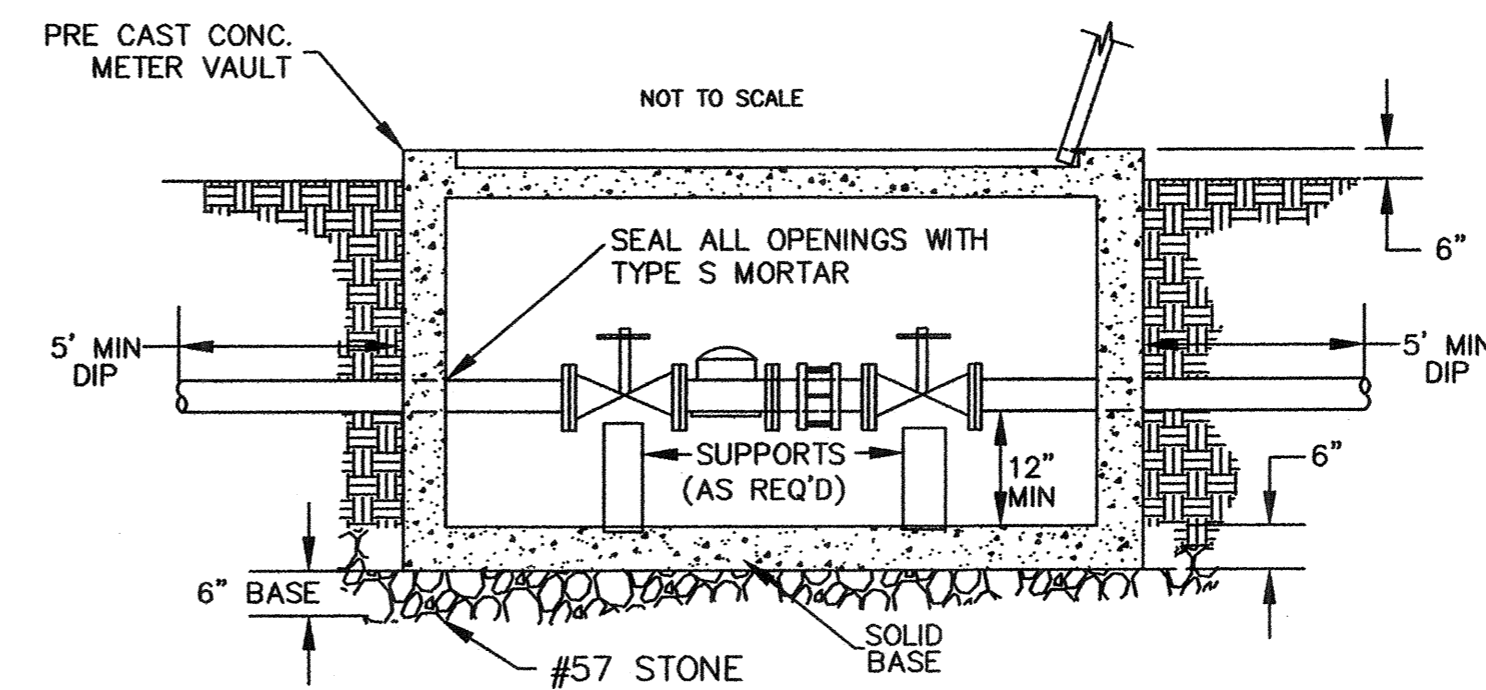


NOTE: MUST BE MIN. 36" AWAY FROM ANY ELECTRICAL PANEL

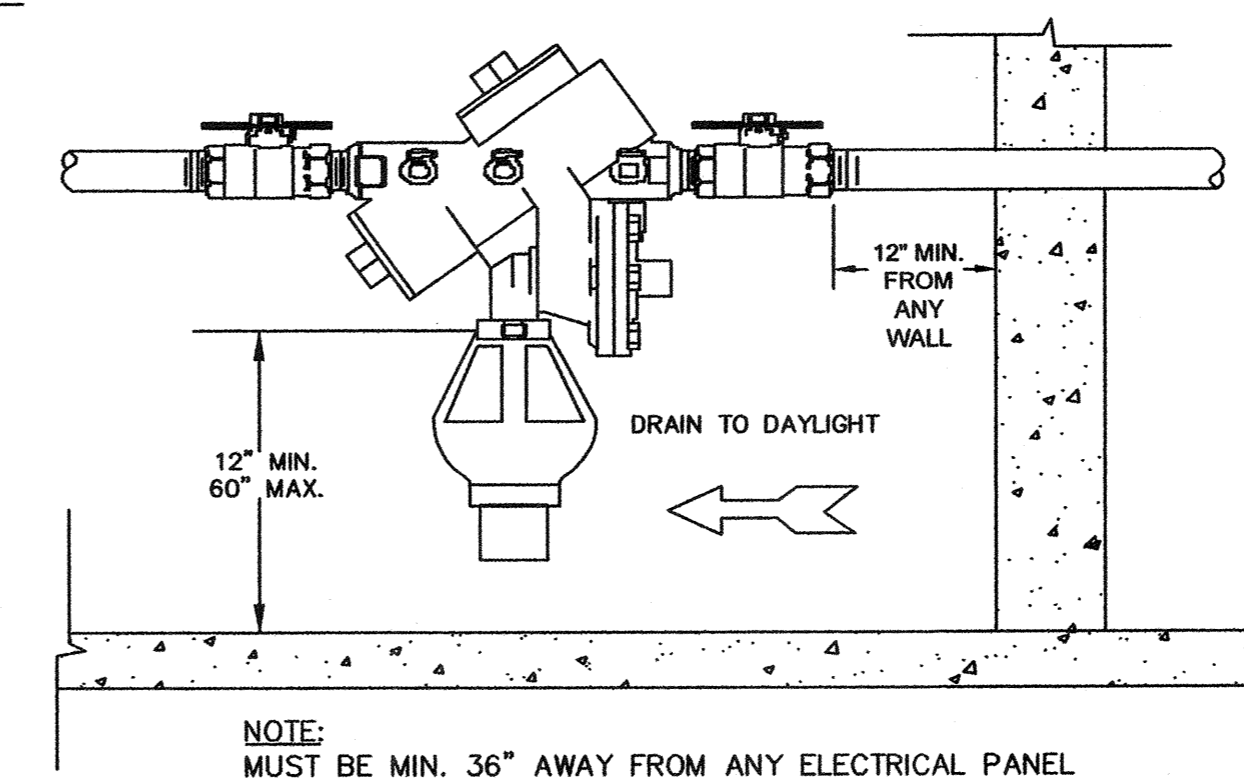

NOTE: 1. MUST BE MIN. 36" AWAY FROM ANY ELECTRICAL PANEL
2. VALVE REQ'D DOWNSTREAM OF BACKFLOW ASSEMBLY
3. VERTICAL INSTALLATION SHALL BE DESIGNED AND SUBMITTED TO CFPWA ESMD FOR APPROVAL

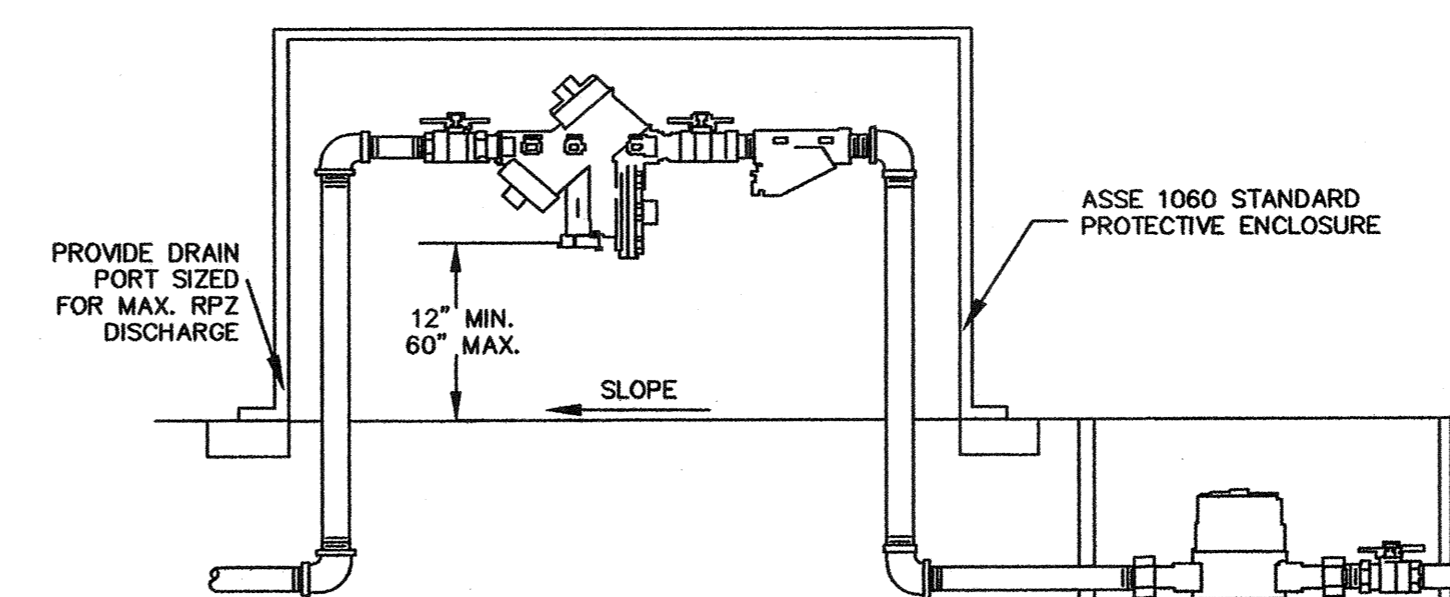REDUCED PRESSURE PRINCIPLE ASSEMBLY
NOT TO SCALE



REV:	DESCRIPTION:	DATE:
1	Single Service Connection, Double Service Connection, and Large Meter Revised	10/26/12

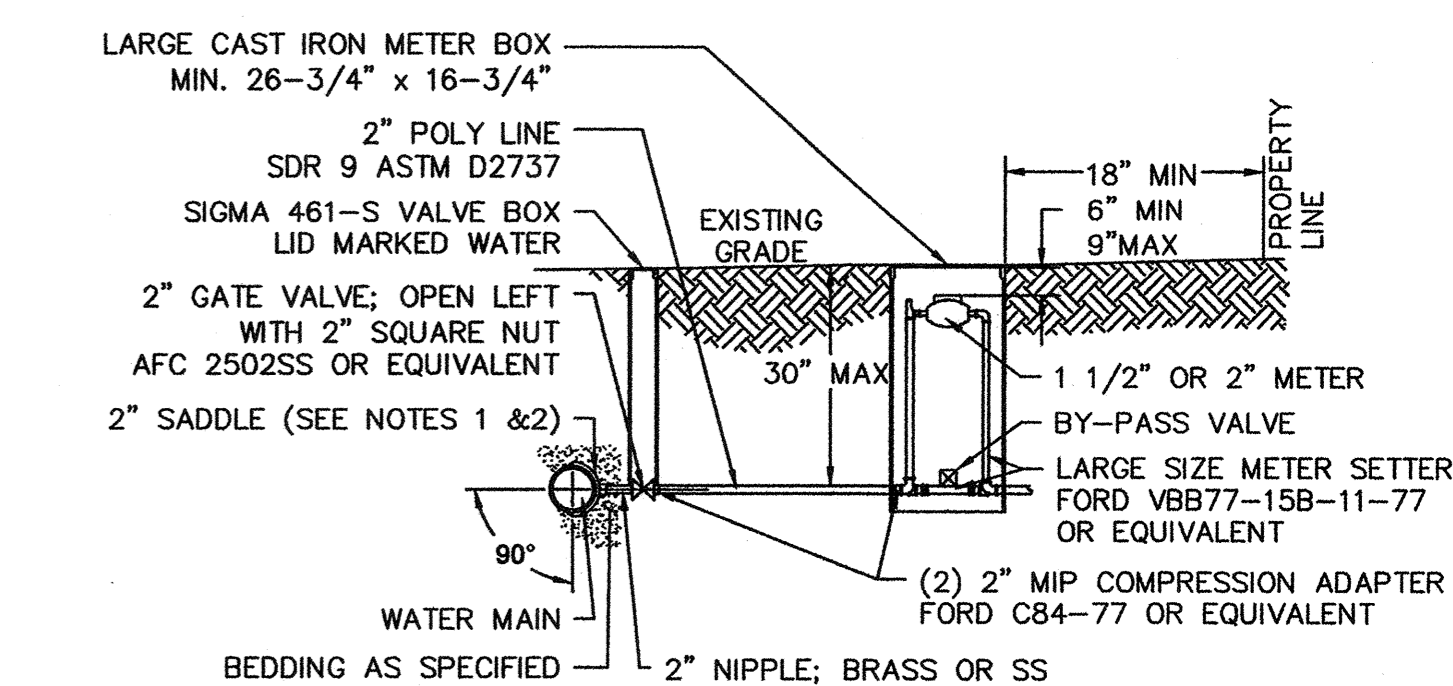

- NOTES:**
- ALL SERVICES SHALL BE INSTALLED PERPENDICULAR TO MAIN.
 - SERVICE SADDLES ON PVC MAINS SHALL BE WIDE BAND BRASS BODY; McDONALD 3800, FORD S90 (DOUBLE STRAP) OR EQUIVALENT.
 - METER BOXES SUSCEPTIBLE TO TRAFFIC SHALL CONFORM TO ASTM A48, CLASS 30B AND AASHTO H20 LOAD RATING STANDARDS (OLDCASTLE PRECAST MODEL B1730 OR APPROVED EQUIVALENT).
 - METER BOXES SUSCEPTIBLE TO INCIDENTAL, NON-DELIBERATE TRAFFIC SHALL CONFORM TO ANSI/SCTE 77 TIER 15 LOAD RATING STANDARDS (SYNERTECH MODEL DUO 17x30 OR APPROVED EQUIVALENT).
 - NON-TRAFFIC METER BOXES SHALL BE SIGMA MB2203 OR APPROVED EQUIVALENT.
 - 3" CLEAN FILL REQUIRED ALL AROUND 2" POLY SERVICE LINE.

LARGE METER

FOR 1 1/2" OR 2" WATER SERVICES
NOT TO SCALE

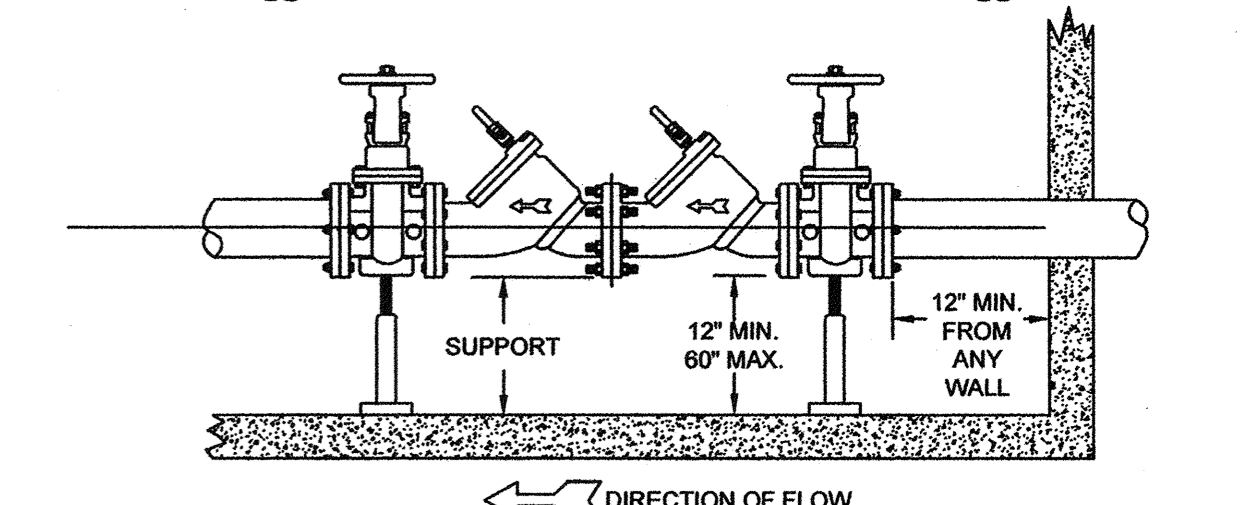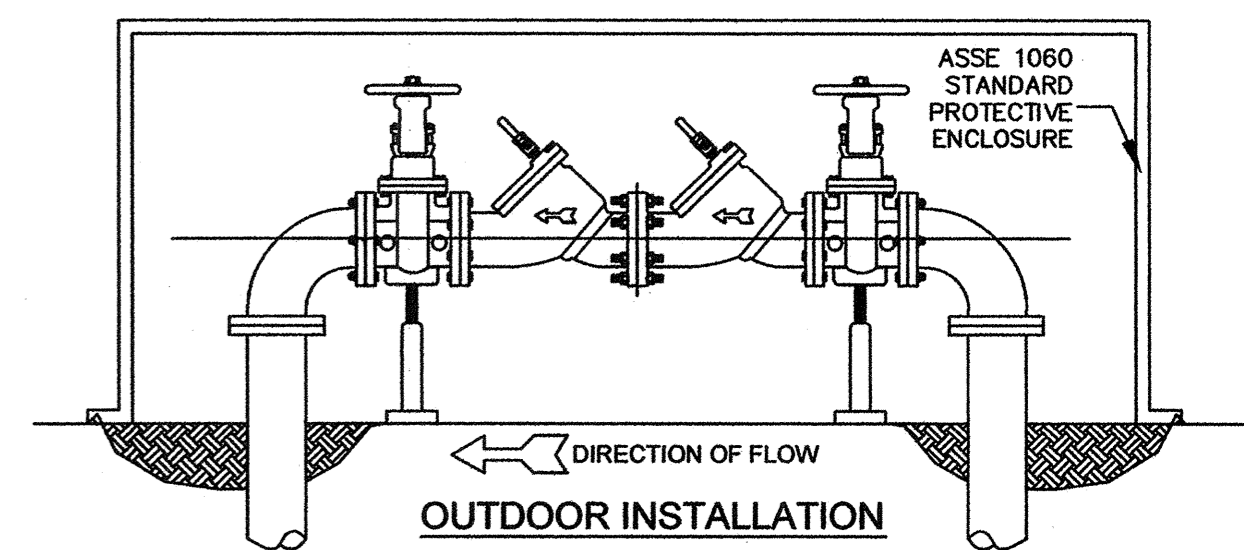

- NOTE:**
- MUST BE MIN. 36" AWAY FROM ANY ELECTRICAL PANEL
 - VALVE REQ'D DOWNSTREAM OF BACKFLOW ASSEMBLY
 - VERTICAL INSTALLATION SHALL BE DESIGNED AND SUBMITTED TO CFPWA ESMD FOR APPROVAL

DOUBLE CHECK VALVE ASSEMBLY


NOT TO SCALE

GENERAL NOTES:


- NO EXCAVATED MATERIAL SHALL BE PLACED IN ANY STREAM, DITCH OR DRAINAGE-WAY.
- THE CONTRACTOR IS RESPONSIBLE FOR LOCATING ALL UNDERGROUND UTILITIES BEFORE ANY CONSTRUCTION BEGINS.
- THE CONTRACTOR IS RESPONSIBLE FOR TEMPORARY SEDIMENT AND EROSION CONTROL MEASURES WHILE CONSTRUCTION IS IN PROGRESS.
- THE CONTRACTOR IS RESPONSIBLE FOR STABILIZATION OF ALL DISTURBED AREAS.
- THE CONTRACTOR IS RESPONSIBLE FOR LAY DOWN & STOCKPILE AREAS (TO ARRANGE AND ENSURE COMPLIANCE WITH ALL LOCAL AND STATE REGULATIONS).

THE DETAILS SHOWN HEREON SUPERCEDE CFPWA WRITTEN TECHNICAL SPECIFICATIONS VERSIONS 1.00 - 1.04

CFPUA WATER DISTRIBUTION SYSTEM		DATE: 1/9/12
STANDARD DETAILS		SCALE: N/A
CAPE FEAR PUBLIC UTILITY AUTHORITY 235 GOVERNMENT CENTER DRIVE WILMINGTON, NC 28403 OFFICE: (910)332-6560		DRAWN BY: CFPUA
Stewardship. Sustainability. Service.		CHECKED BY: CFPUA
		PROJECT NO.:
SHEET NO: WSD-1		

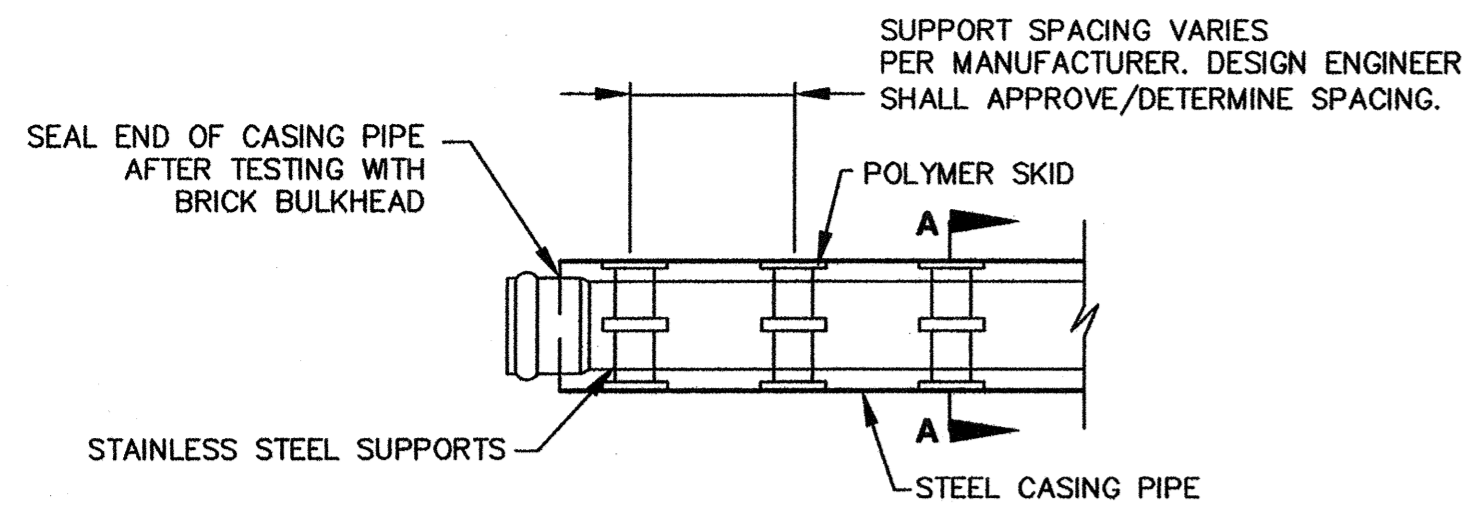


NOTE: PIPE SUPPORT TO BE PLACED TO PROVIDE PROPER SUPPORT, ALIGNMENT, AND GRADE AS SPECIFIED. CONTINUOUS SUPPORTS MAY BE USED AS ALTERNATIVE. OIL, GREASE, OR PETROLEUM PRODUCT MAY NOT BE USED AS LUBRICANT.

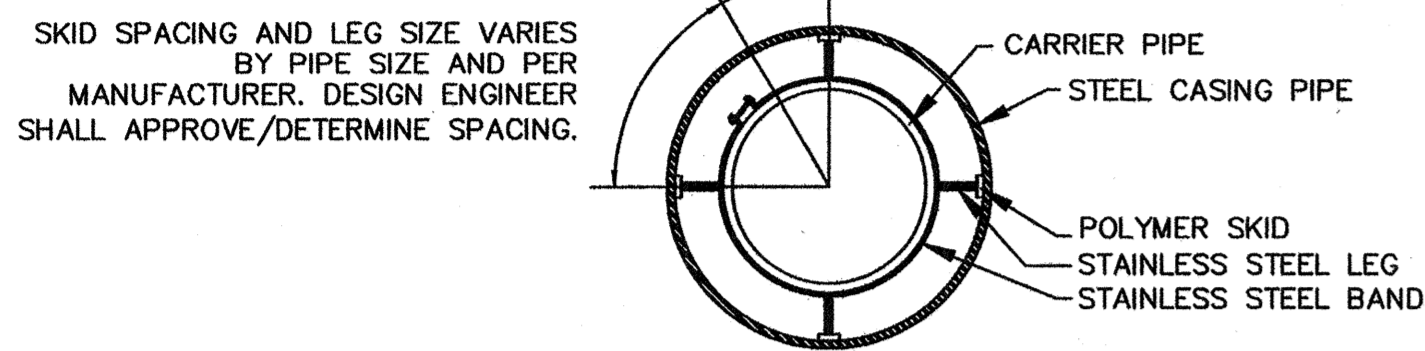

PIPE CASING SUPPORT DETAIL

NOT TO SCALE


NOTE: PAVEMENT WIDTH AND LOCATION IN R/W VARIES. SEE PLAN FOR INDIVIDUAL LOCATION.

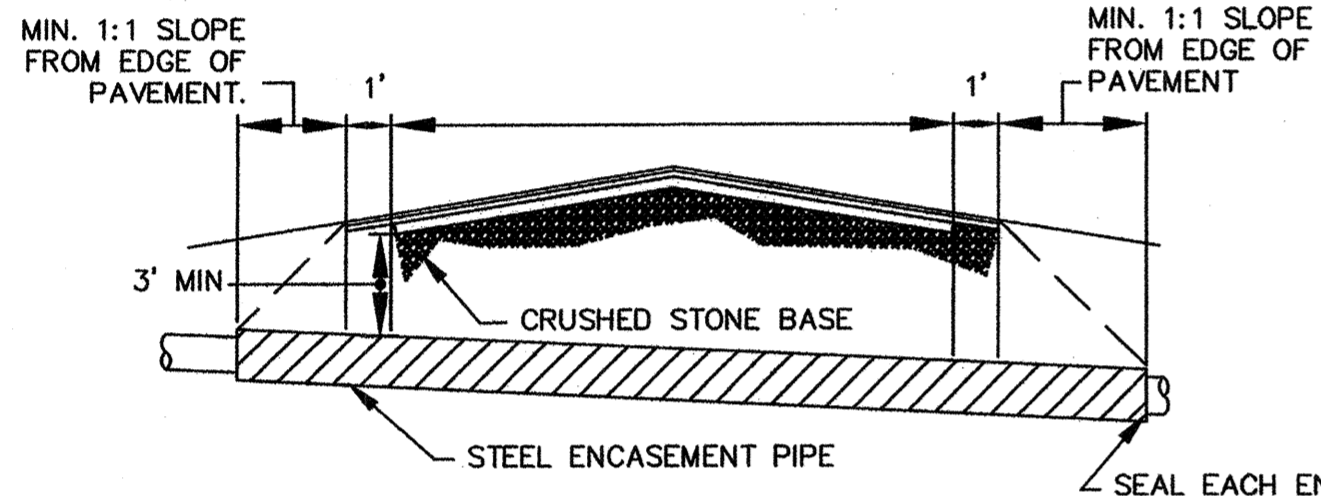

NOTES:
1. CASING WILL BE INSTALLED AT LINE AND GRADE SHOWN ON INDIVIDUAL PROFILE FOR EACH CROSSING. BORING/JACKING TO LINE AND GRADE IS REQUIRED.
2. TRACER WIRE SHALL BE CONTINUED THROUGH CASING

TYPICAL BORING/JACKING DETAIL


NOT TO SCALE

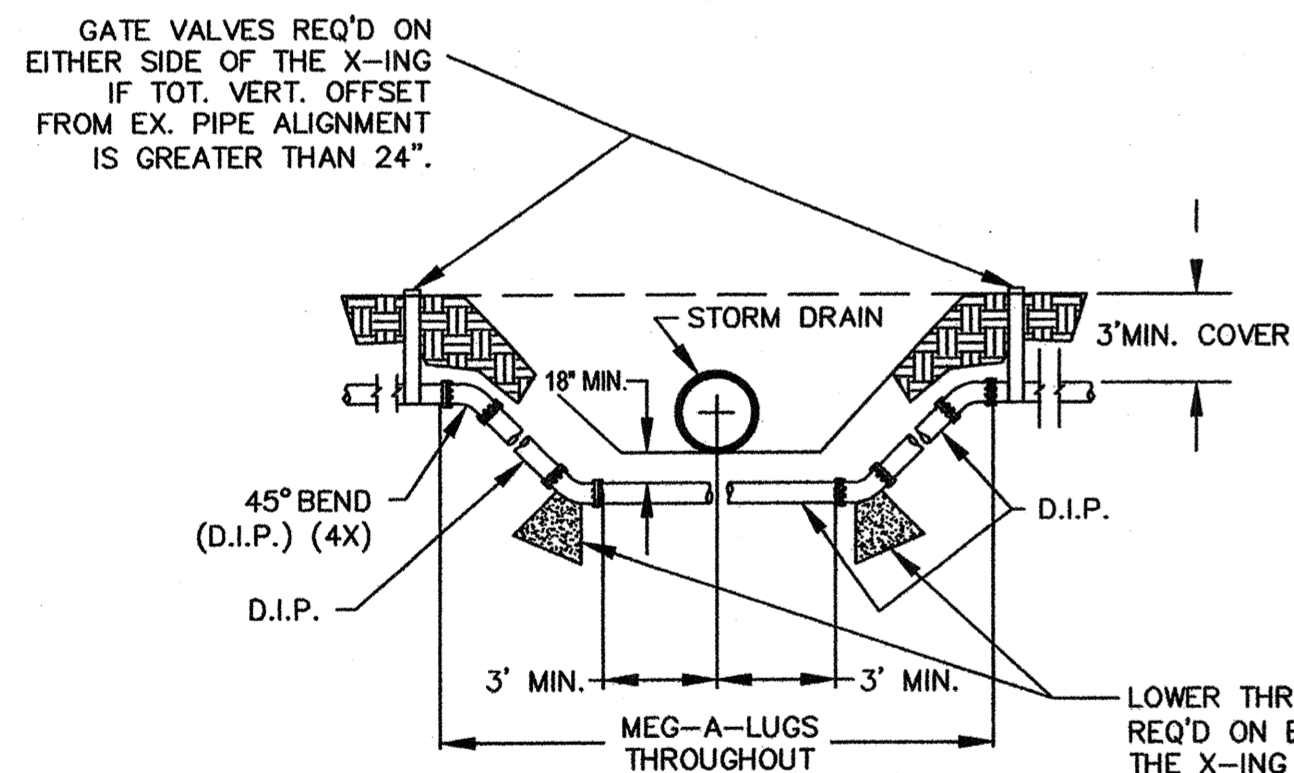

NOTE: USE D.I.P. (CL50 OR BETTER)

WATER MAIN DITCH & STORM DRAIN CROSSING

NOT TO SCALE

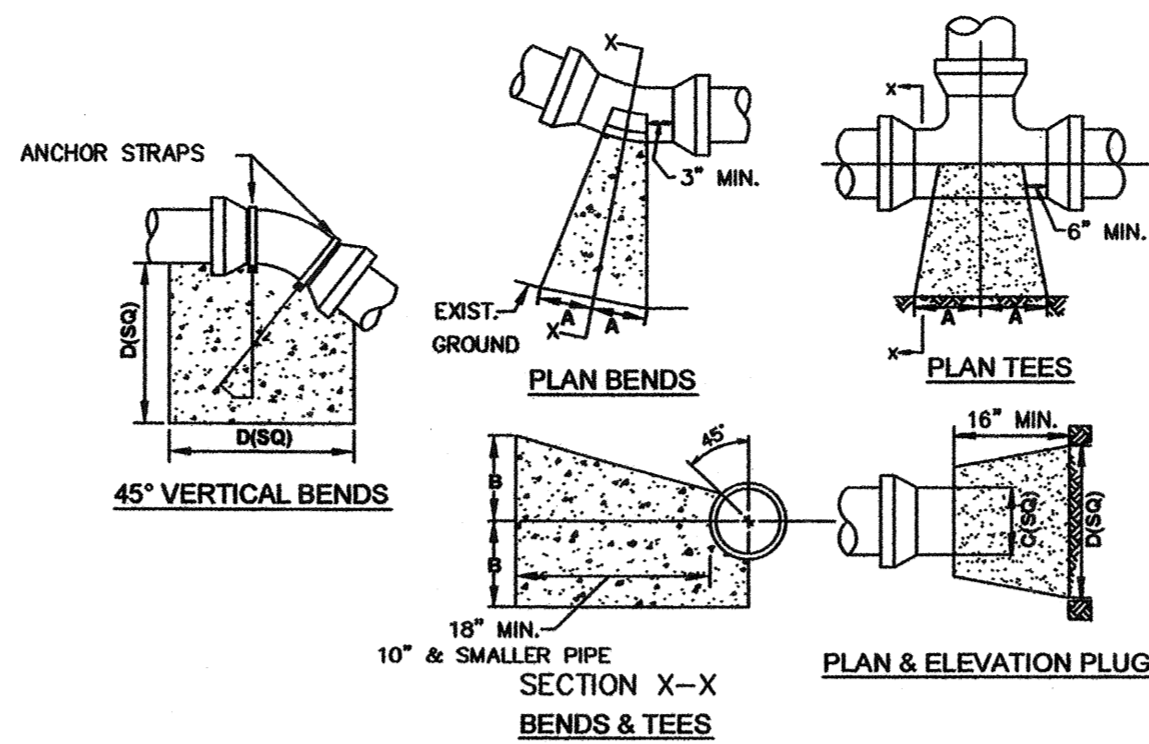


SIZE	90° BENDS		45° BENDS		22 1/2° BENDS		TEES/PLUGS		45° VERT. BENDS
	A	B	A	B	A	B	A	B	
3"	8"	6"	5"	6"	3"	7"	6"	8"	27"
4"	8"	9"	5"	8"	3"	11"	6"	9"	28"
6"	14"	11"	9"	9"	8"	8"	12"	9"	36"
8"	16"	16"	12"	12"	10"	13"	14"	13"	42"
10"	18"	22"	15"	14"	14"	16"	18"	15"	50"
12"	20"	28"	18"	17"	16"	16"	22"	18"	62"
14"	26"	29"	21"	19"	18"	18"	26"	20"	72"
16"	33"	29"	25"	21"	20"	21"	32"	21"	83"
18"	40"	30"	28"	24"	22"	23"	36"	24"	88"

NOTES:
1. BASED ON 160 PSI TEST PRESSURE AND 2000 PSF SOIL BEARING CAPACITY.
2. ALL BEARING SURFACES TO BE CARRIED TO UNDISTURBED GROUND.
3. USE MEG-A-LUG (PREFERRED) IN LIEU OF BLOCKING AND RODDING.


THRUST BLOCK DETAIL

NOT TO SCALE

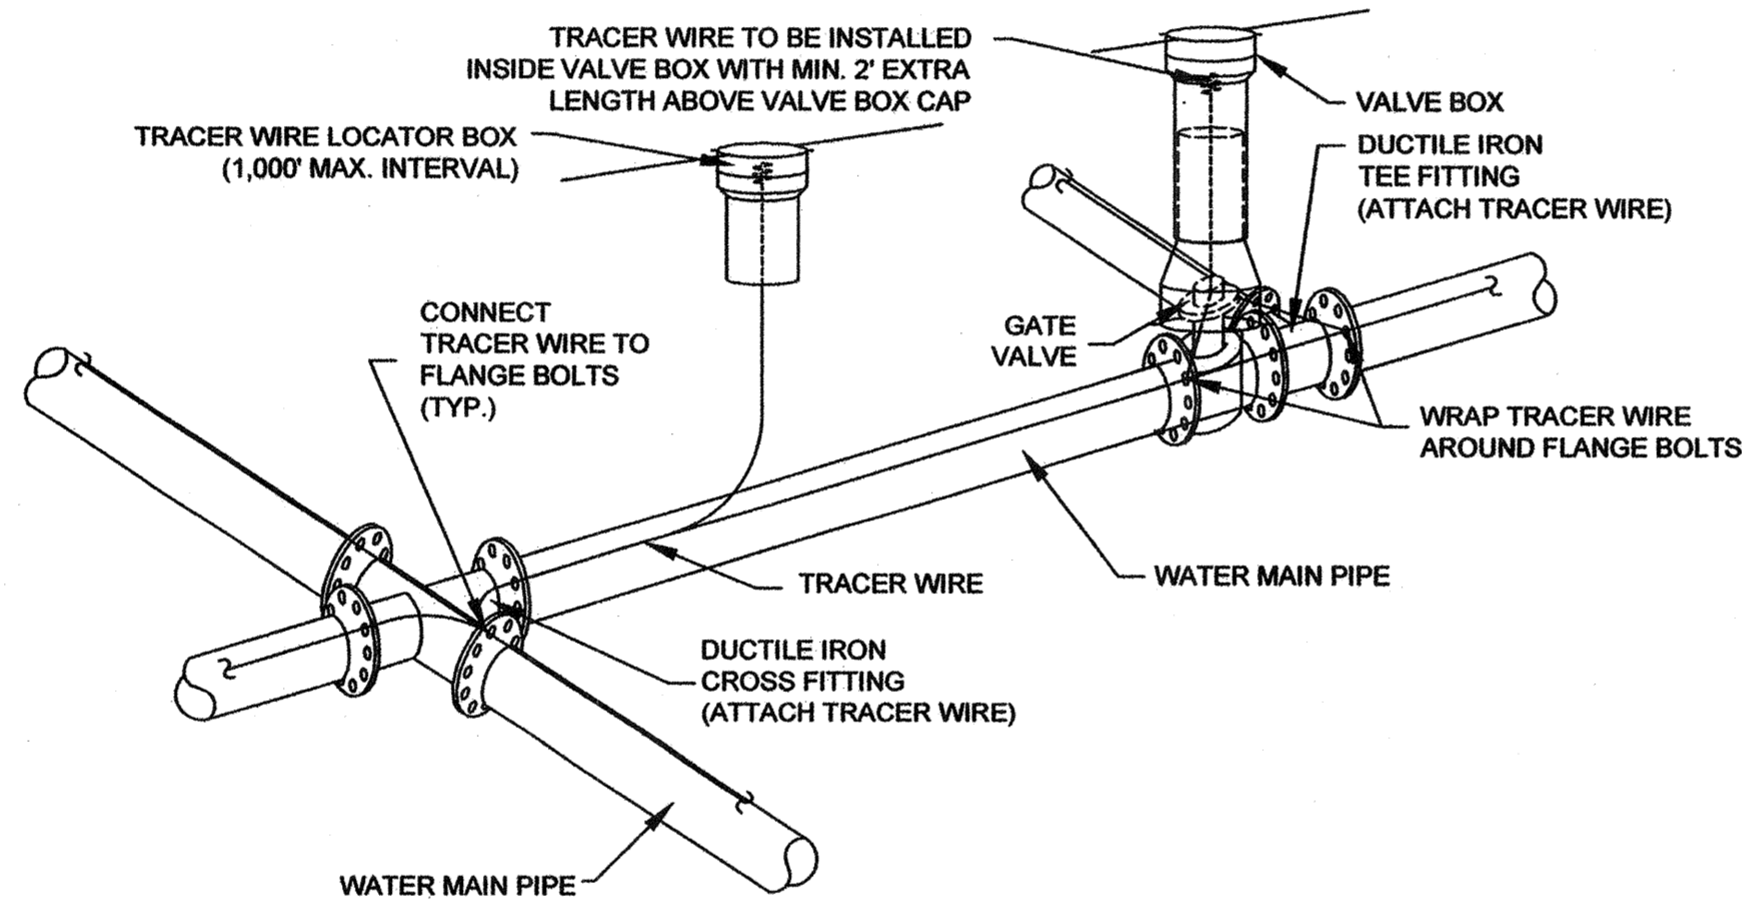


NOTES:
1. TRACER WIRE SHALL BE #10 COPPER SOLID CORE COPPER WIRE WITH GAS AND OIL RESISTANT INSULATION
2. WIRE SHALL BE STRAPPED TO ALL PVC WATER MAIN PIPING WITH DUCT TAPE AT 12-FT. INTERVALS.
3. SECURE WIRE TO ALL TEE AND CROSS FITTINGS.
4. ALL WIRE SPLICES SHALL HAVE WATER PROOF WIRE CONNECTIONS.

TRACER WIRE DETAIL

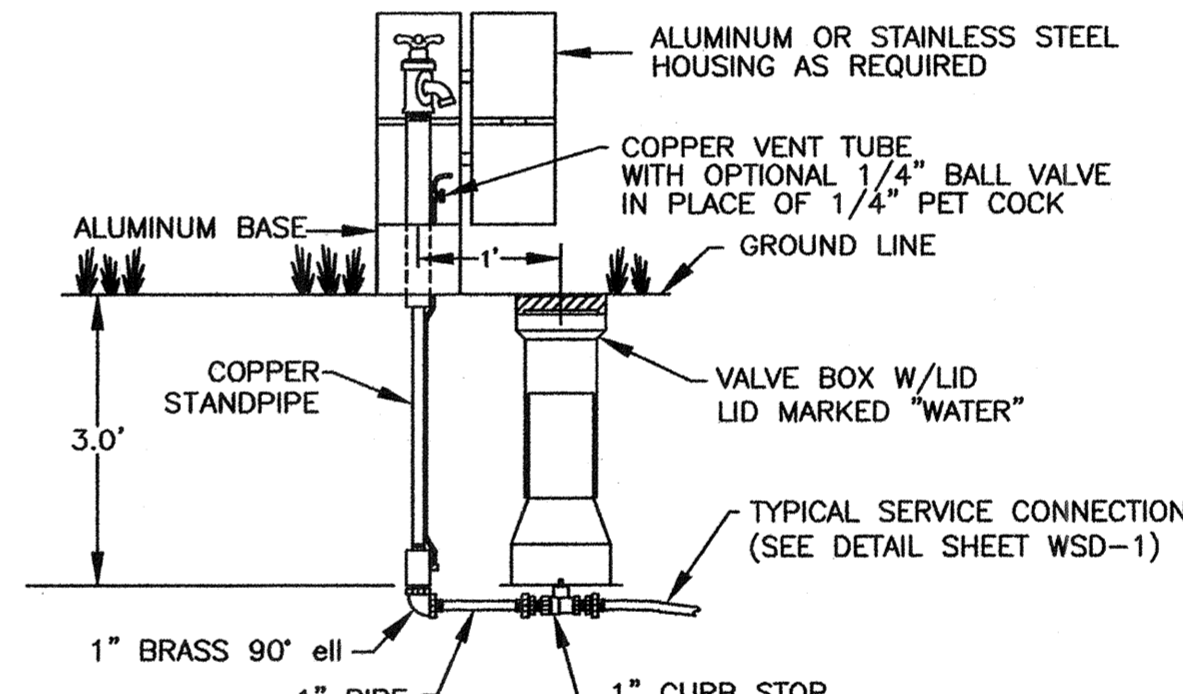

SAMPLING STATION

NOT TO SCALE

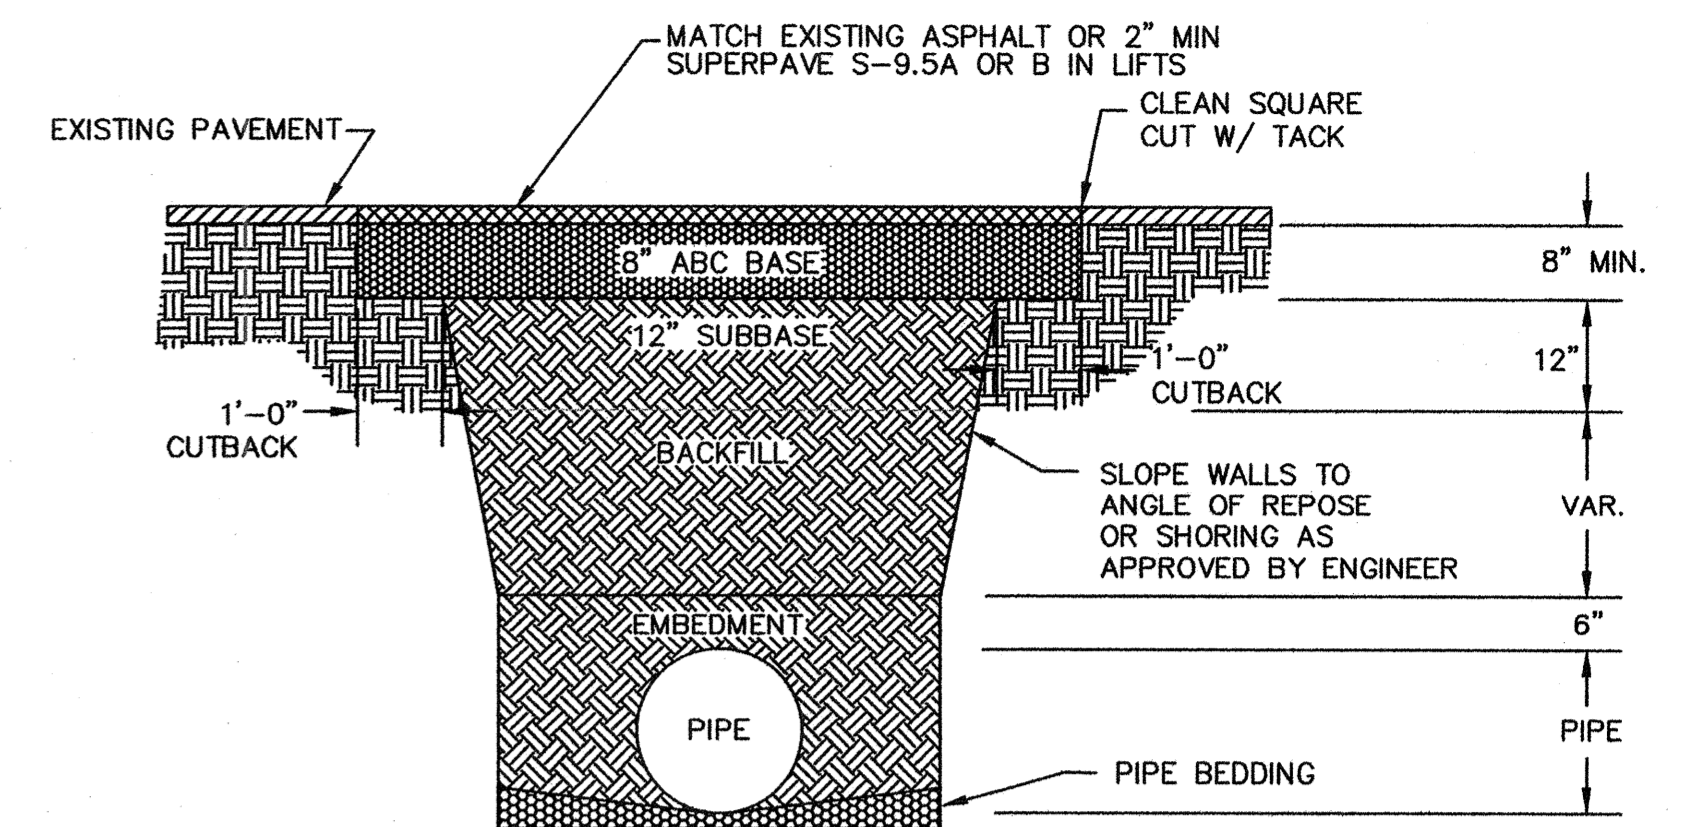


NOTES:

- BACKFILL SHALL BE SUITABLE MATERIAL THAT IS FREE FROM HEAVY CLAY, GUMBOS, DEBRIS, ORGANICS AND LITTLE TO NO EXCESSIVE MOISTURE.
- SELECT BACKFILL MAY BE SUBSTITUTED OR REQUIRED BY CITY TO ACHIEVE COMPACTION, (I.E. #57, ABC, CRUSHED LIMESTONE, CLEAN SAND, FLOWABLE FILL, ETC).
- 8-INCH OF ABC BASE MATERIAL SHALL BE USED ON CITY STREETS.
- BACKFILL AND BASE MATERIALS SHALL BE COMPACTED 12" MINIMUM LIFTS
- SOIL SHALL BE COMPACTED BY A MECHANIZED TAMPER (I.E. JUMPING JACK). HOWEVER, VIBRATORY ROLLERS > 18" WIDTH MAY BE USED FOR LARGER EXCAVATIONS. THE PLATE TAMP METHOD SHALL NOT BE USED.
- ALL APPROVED CASTINGS SHALL BE SET FLUSH TO GRADE AND SUPPORTED IF APPLICABLE.
- ABC BASE AND SUBBASE COMPACTED TO 98% AND BACKFILL AND EMBEDMENT COMPACTED TO 90% AS DETERMINED BY THE MODIFIED PROCTOR AASHTO METHOD T-99.
- 1-FOOT CUTBACKS OF ASPHALT SHALL BE PREPARED ON UNDISTURBED SOIL. MINIMUM ASPHALT DENSITY IS 90%.

PAVEMENT REPAIR WHERE PIPE INSTALLED

(FOR PRIVATE ROADS AND PAVED AREAS; CONTRACTOR TO MEET MIN. REQUIREMENTS AS DEFINED BY RIGHT-OF-WAY OWNER FOR PUBLIC ROAD REPAIRS)

NOT TO SCALE

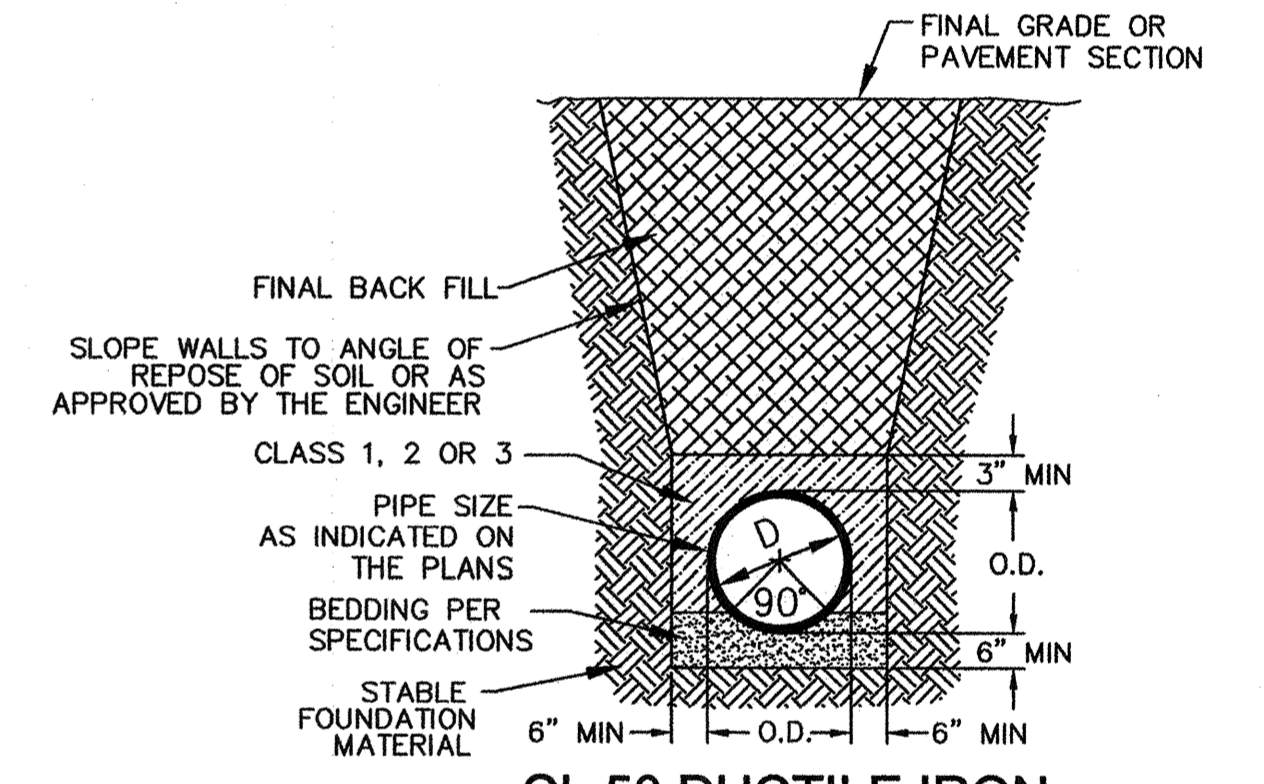

CL 50 DUCTILE IRON DR 18 PVC PIPE TRENCH DETAIL


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CFPUA WATER DISTRIBUTION SYSTEM



STANDARD DETAILS

CAPE FEAR PUBLIC UTILITY AUTHORITY
235 GOVERNMENT CENTER DRIVE
WILMINGTON, NC 28403
OFFICE: (910)332-6560

DATE: 1/9/12
SCALE: N/A
DRAWN BY: CFPWA
CHECKED BY: CFPWA
PROJECT NO.:

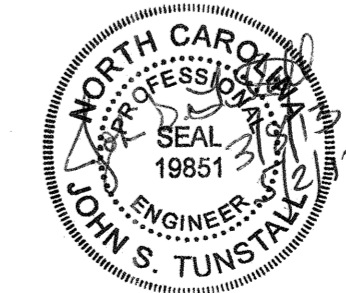SHEET NO: WSD-2

REV:	DESCRIPTION:	DATE:

THESE DETAILS ARE A WORK PRODUCT OF CFPWA FOR WATER AND SEWER SYSTEM DESIGN AND CONSTRUCTION AND HAVE BEEN REVIEWED AND APPROVED FOR CONTENT AND GENERAL CONFORMANCE WITH THE WATER AND SEWER DESIGN FOR THIS PROJECT.